Isle Of Dreams

1400 79th Street Causeway North Bay Village, FL 33141

SHORELINE SUBMITTAL

MAY 30, 2025

PREPARED FOR:

ARQUITECTONICA




CONSULTANTS





PLANNING LANDSCAPE ARCHITECTURE URBAN DESIGN

1512 E. BROWARD BOULEVARD, SUITE 110 FORT LAUDERDALE, FLORIDA 33301 USA TEL: 954.524.3330 | LCC000001



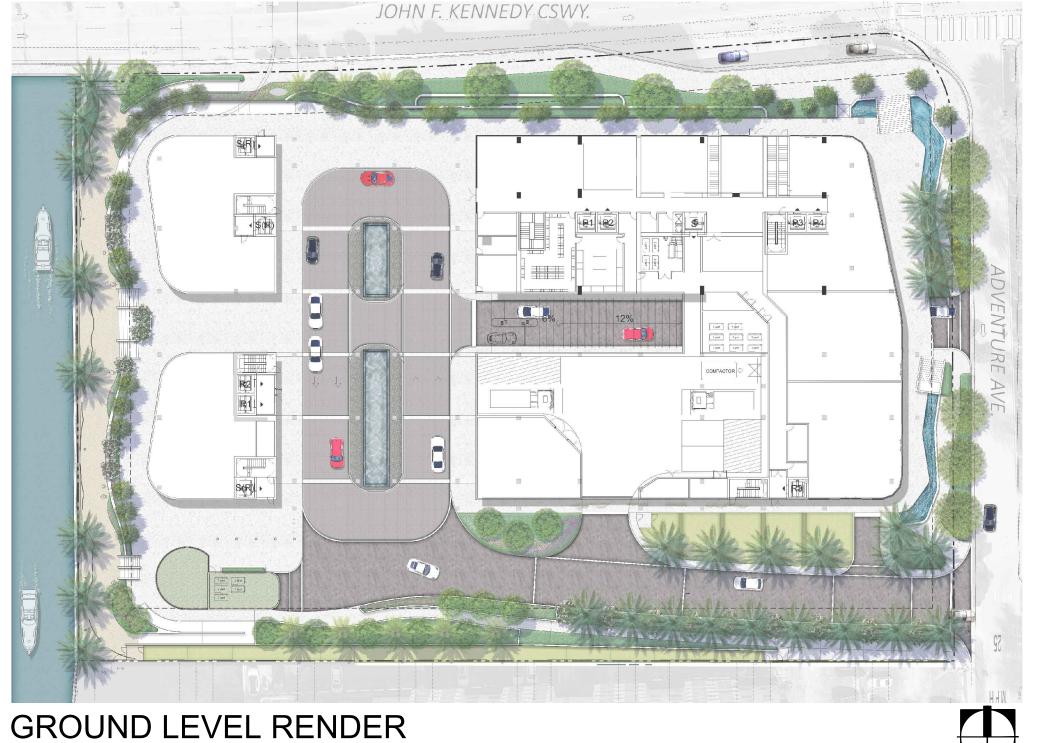

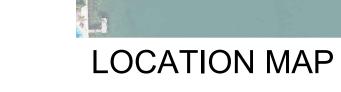

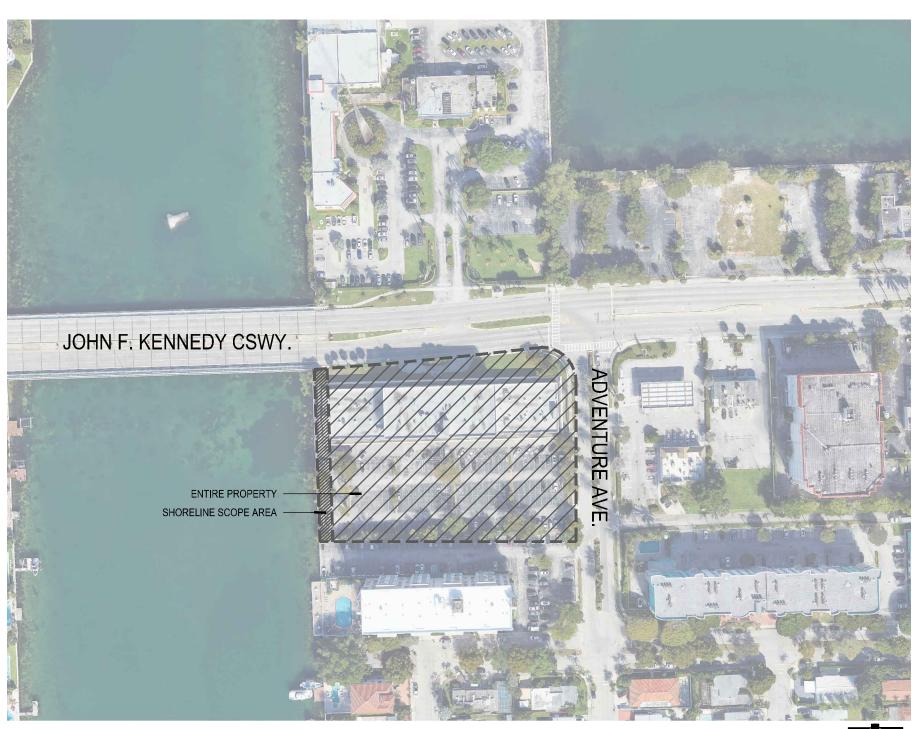

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Project Na

ISLE OF DREAMS

ARQUITECTONICA



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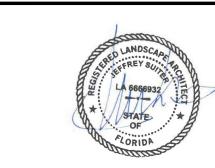
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Consultants:

Plan

Rev	Date	Issued for

Date	05/30/2025
Designed By	MH, LDC
Drawn By	LDC
Approved / Checked By	JS
Project Number	SE240000



Project Phase


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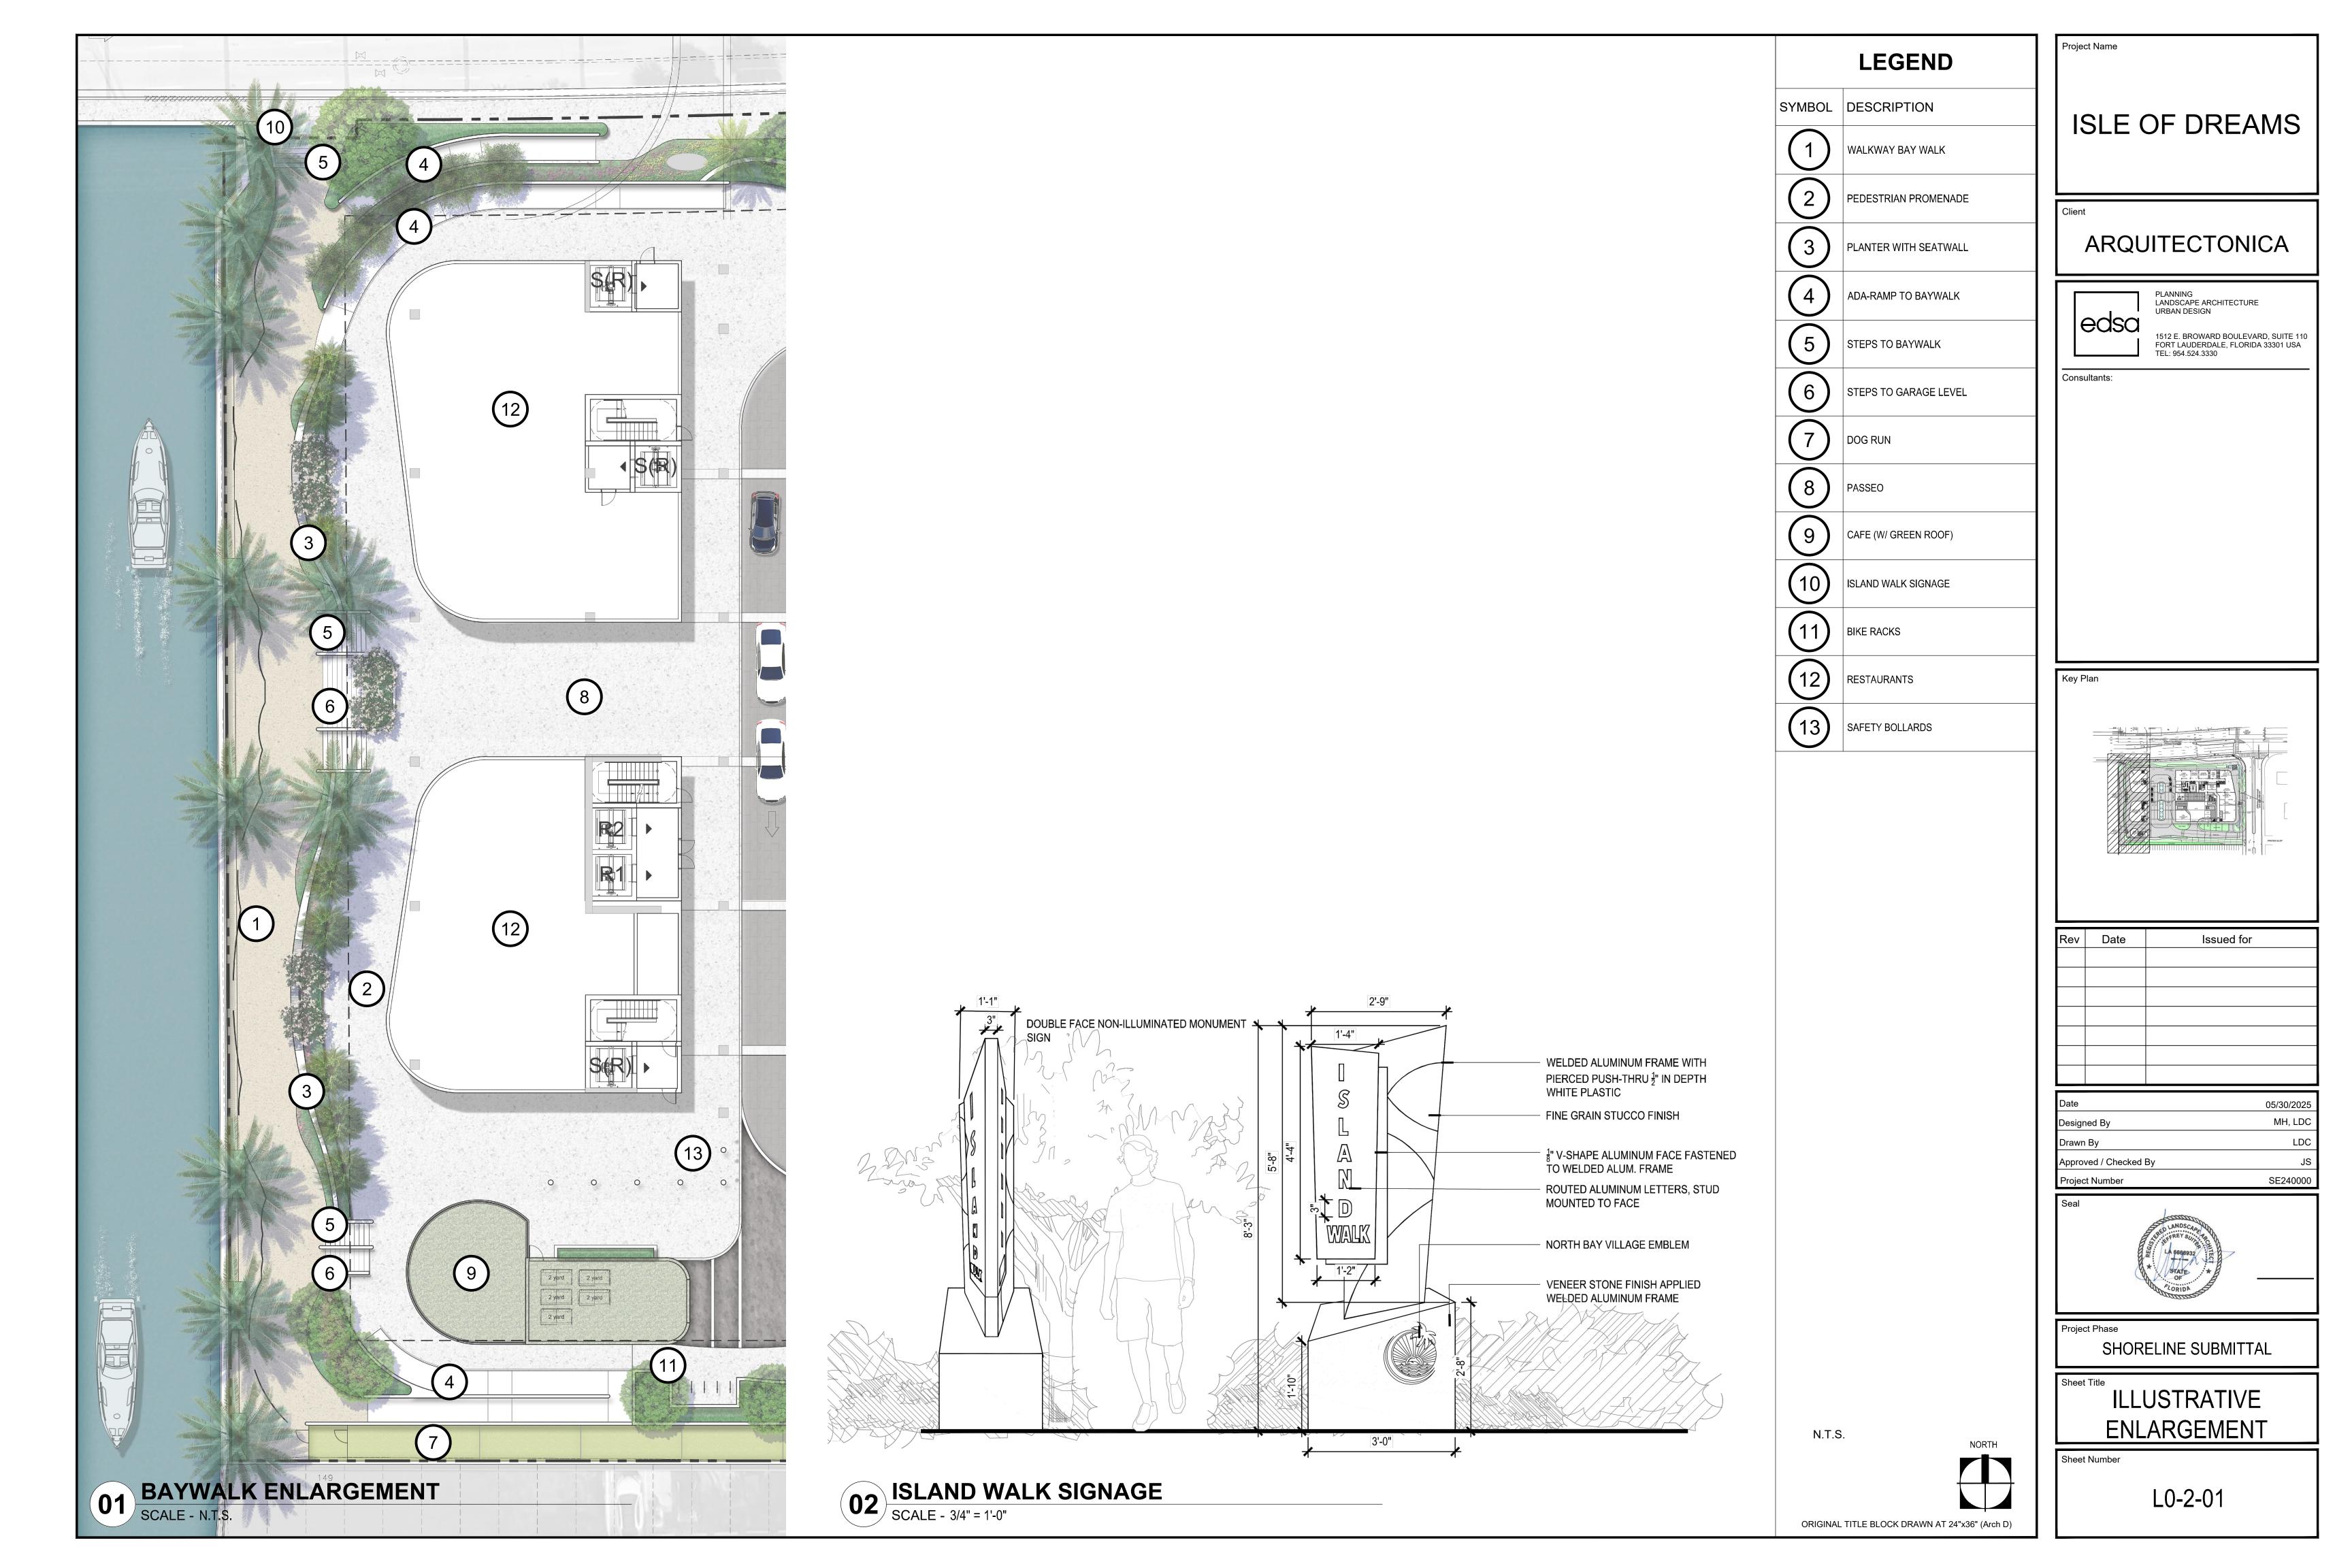
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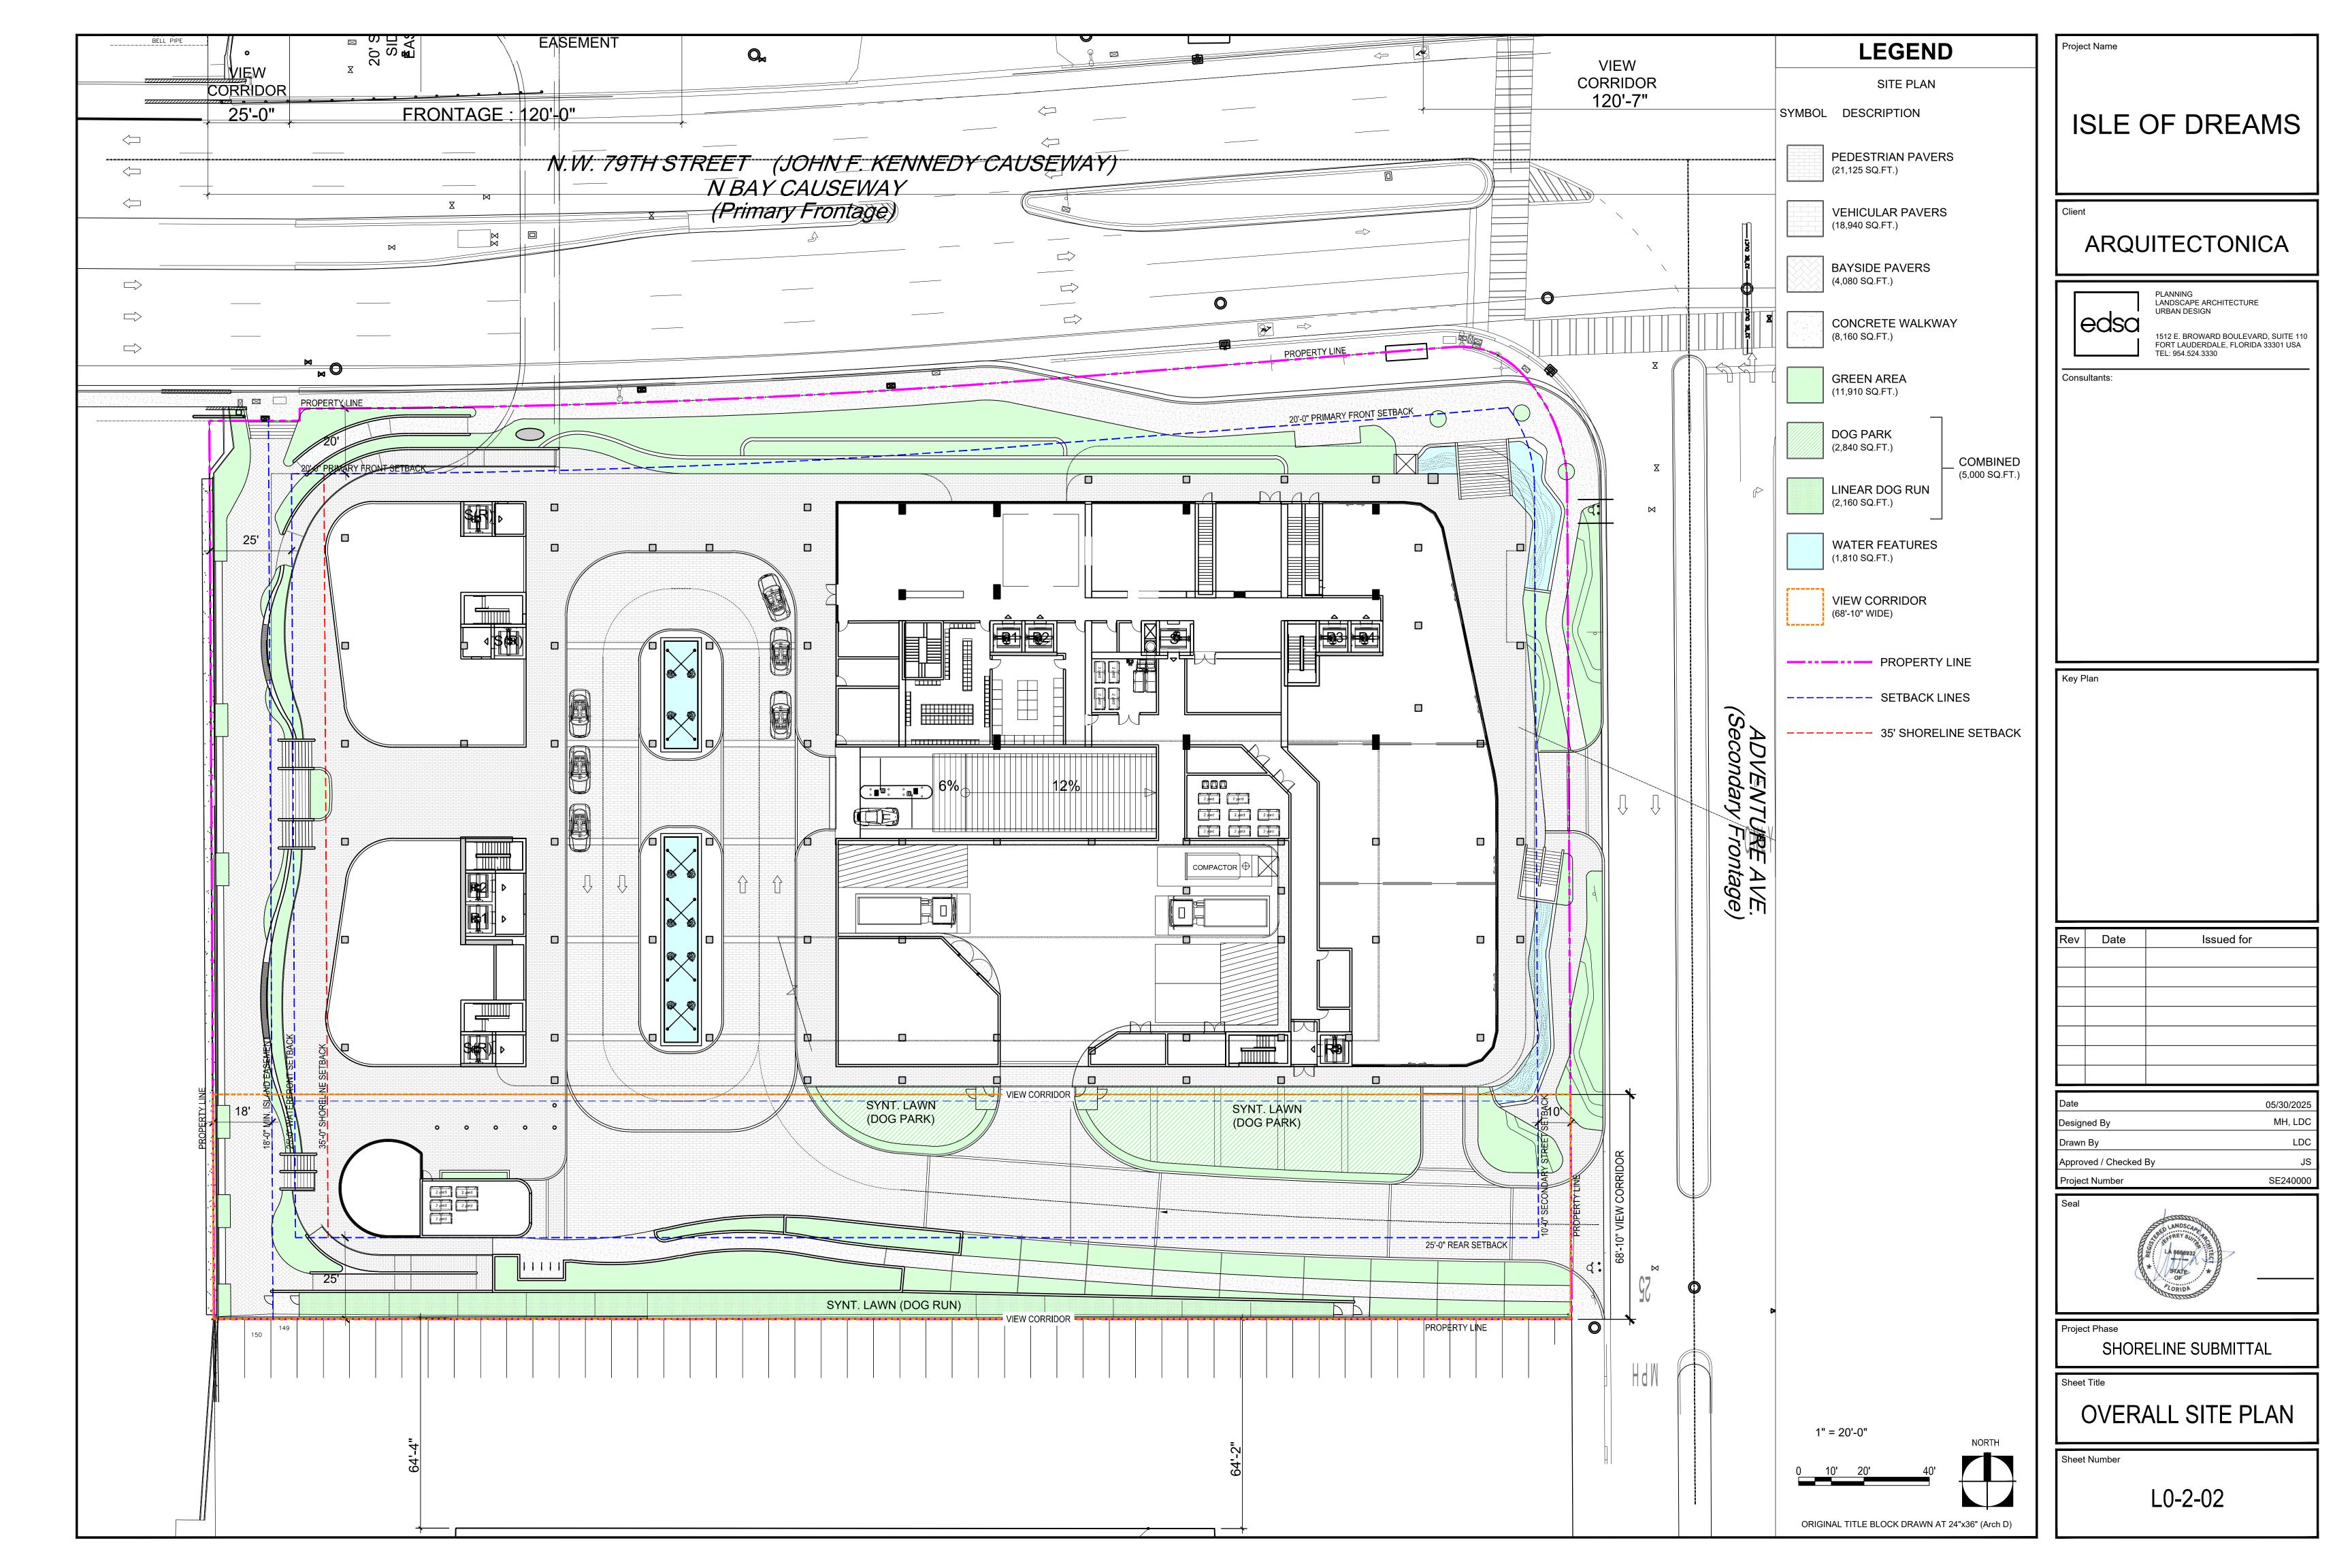
SITE CONTEXT & INDEX


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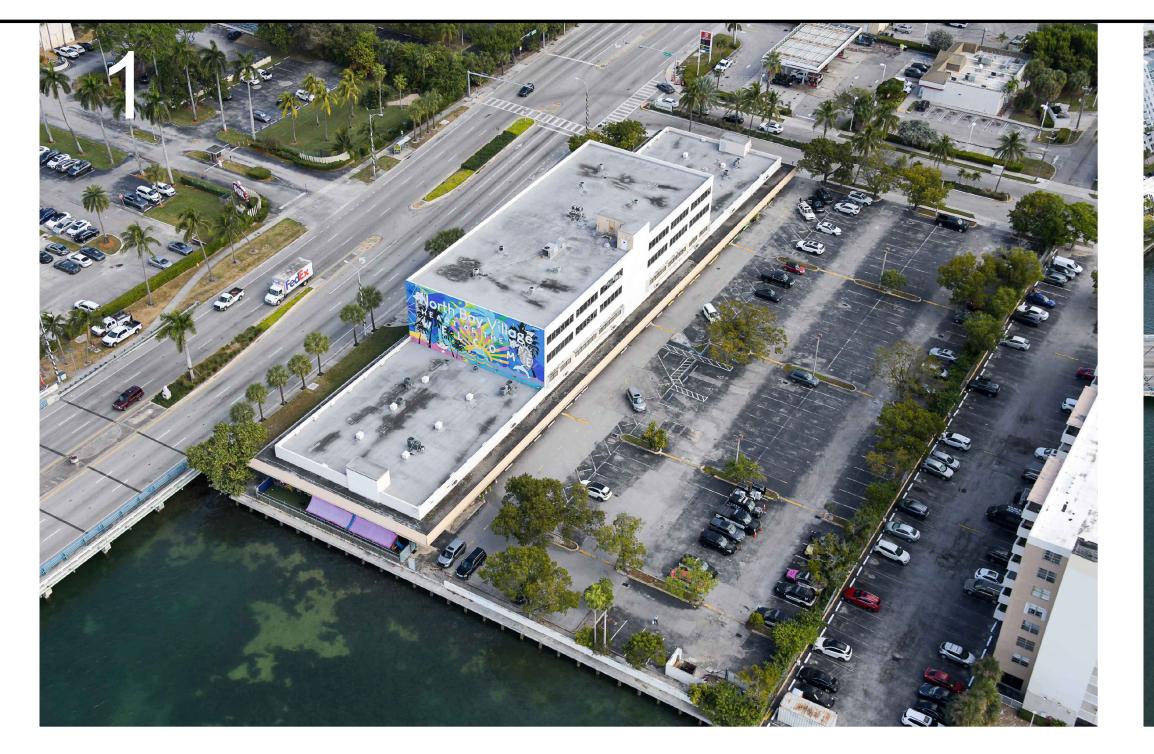
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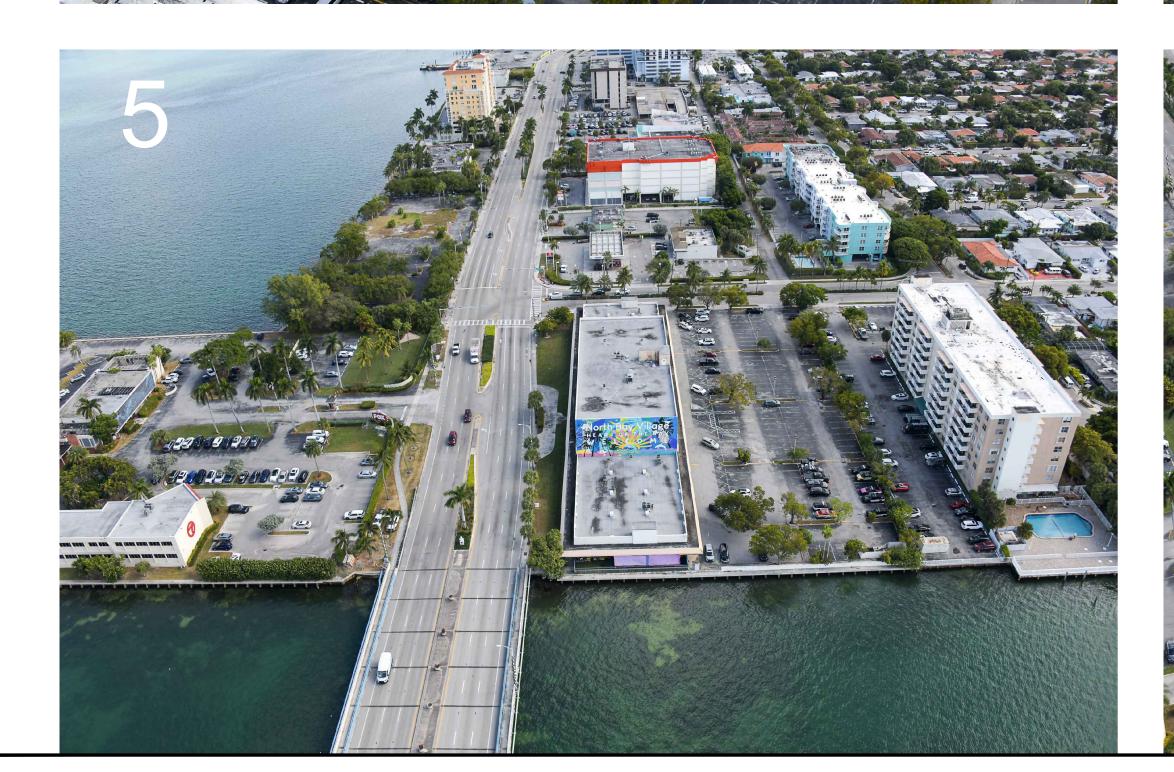









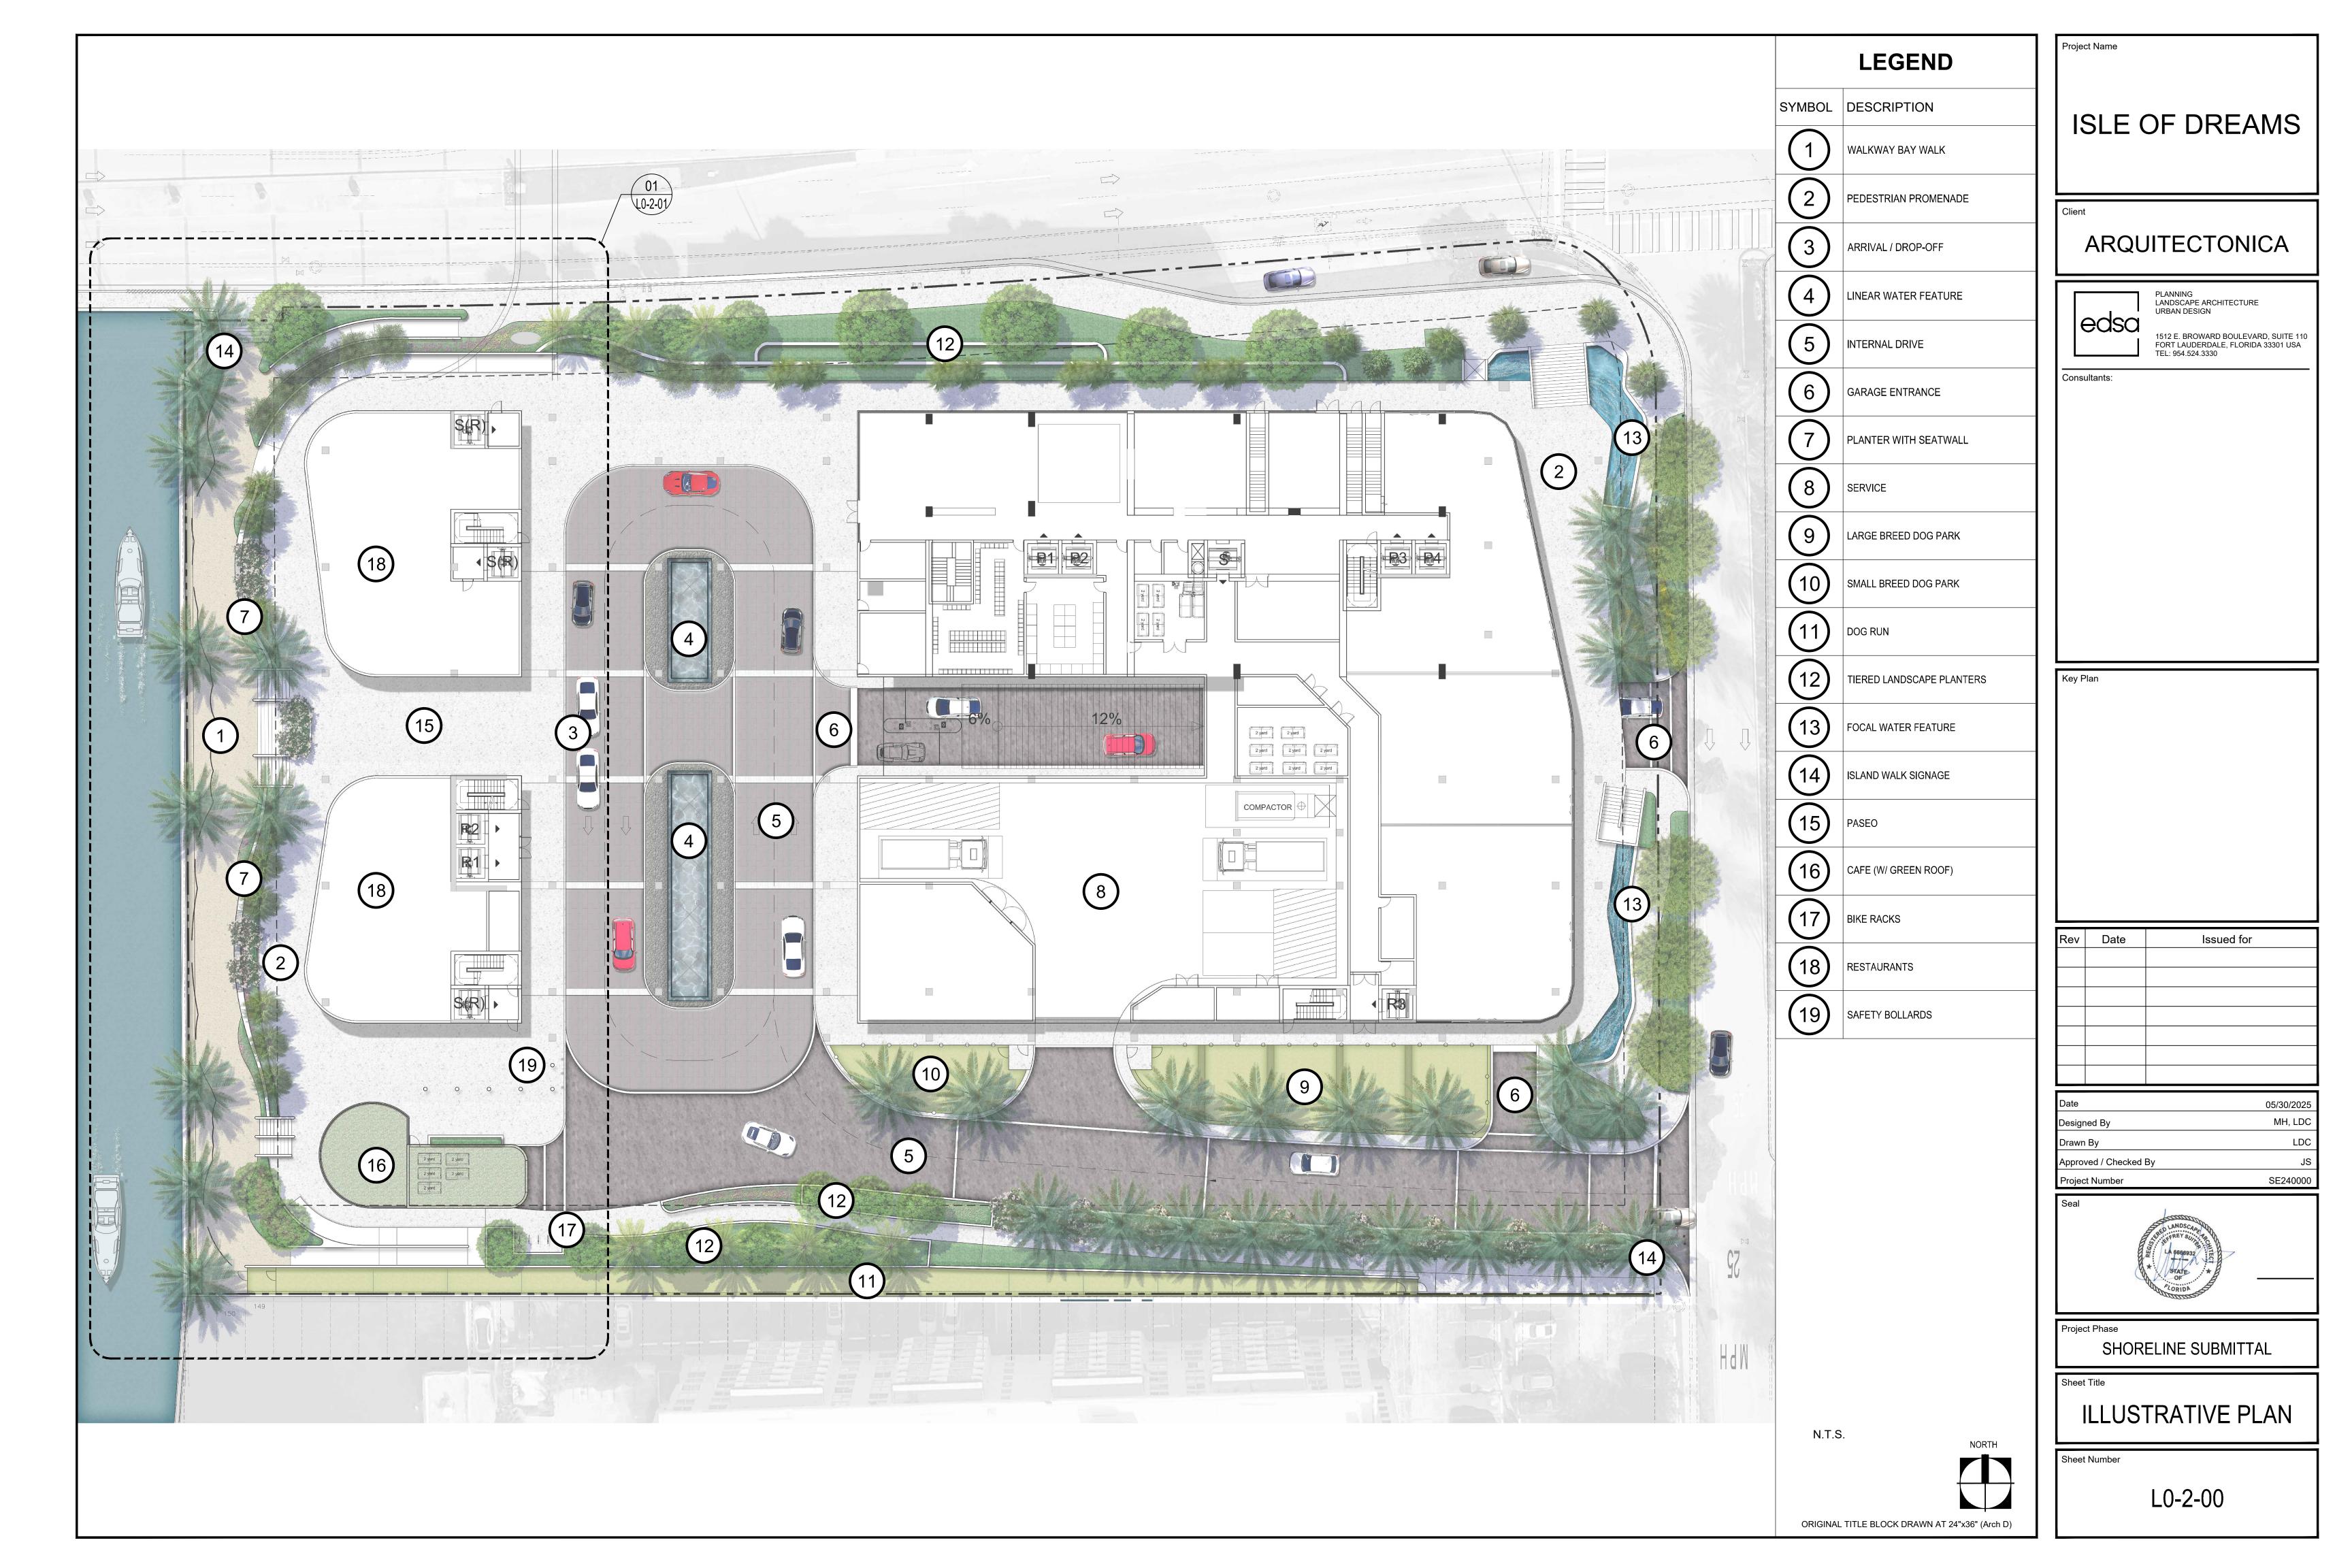

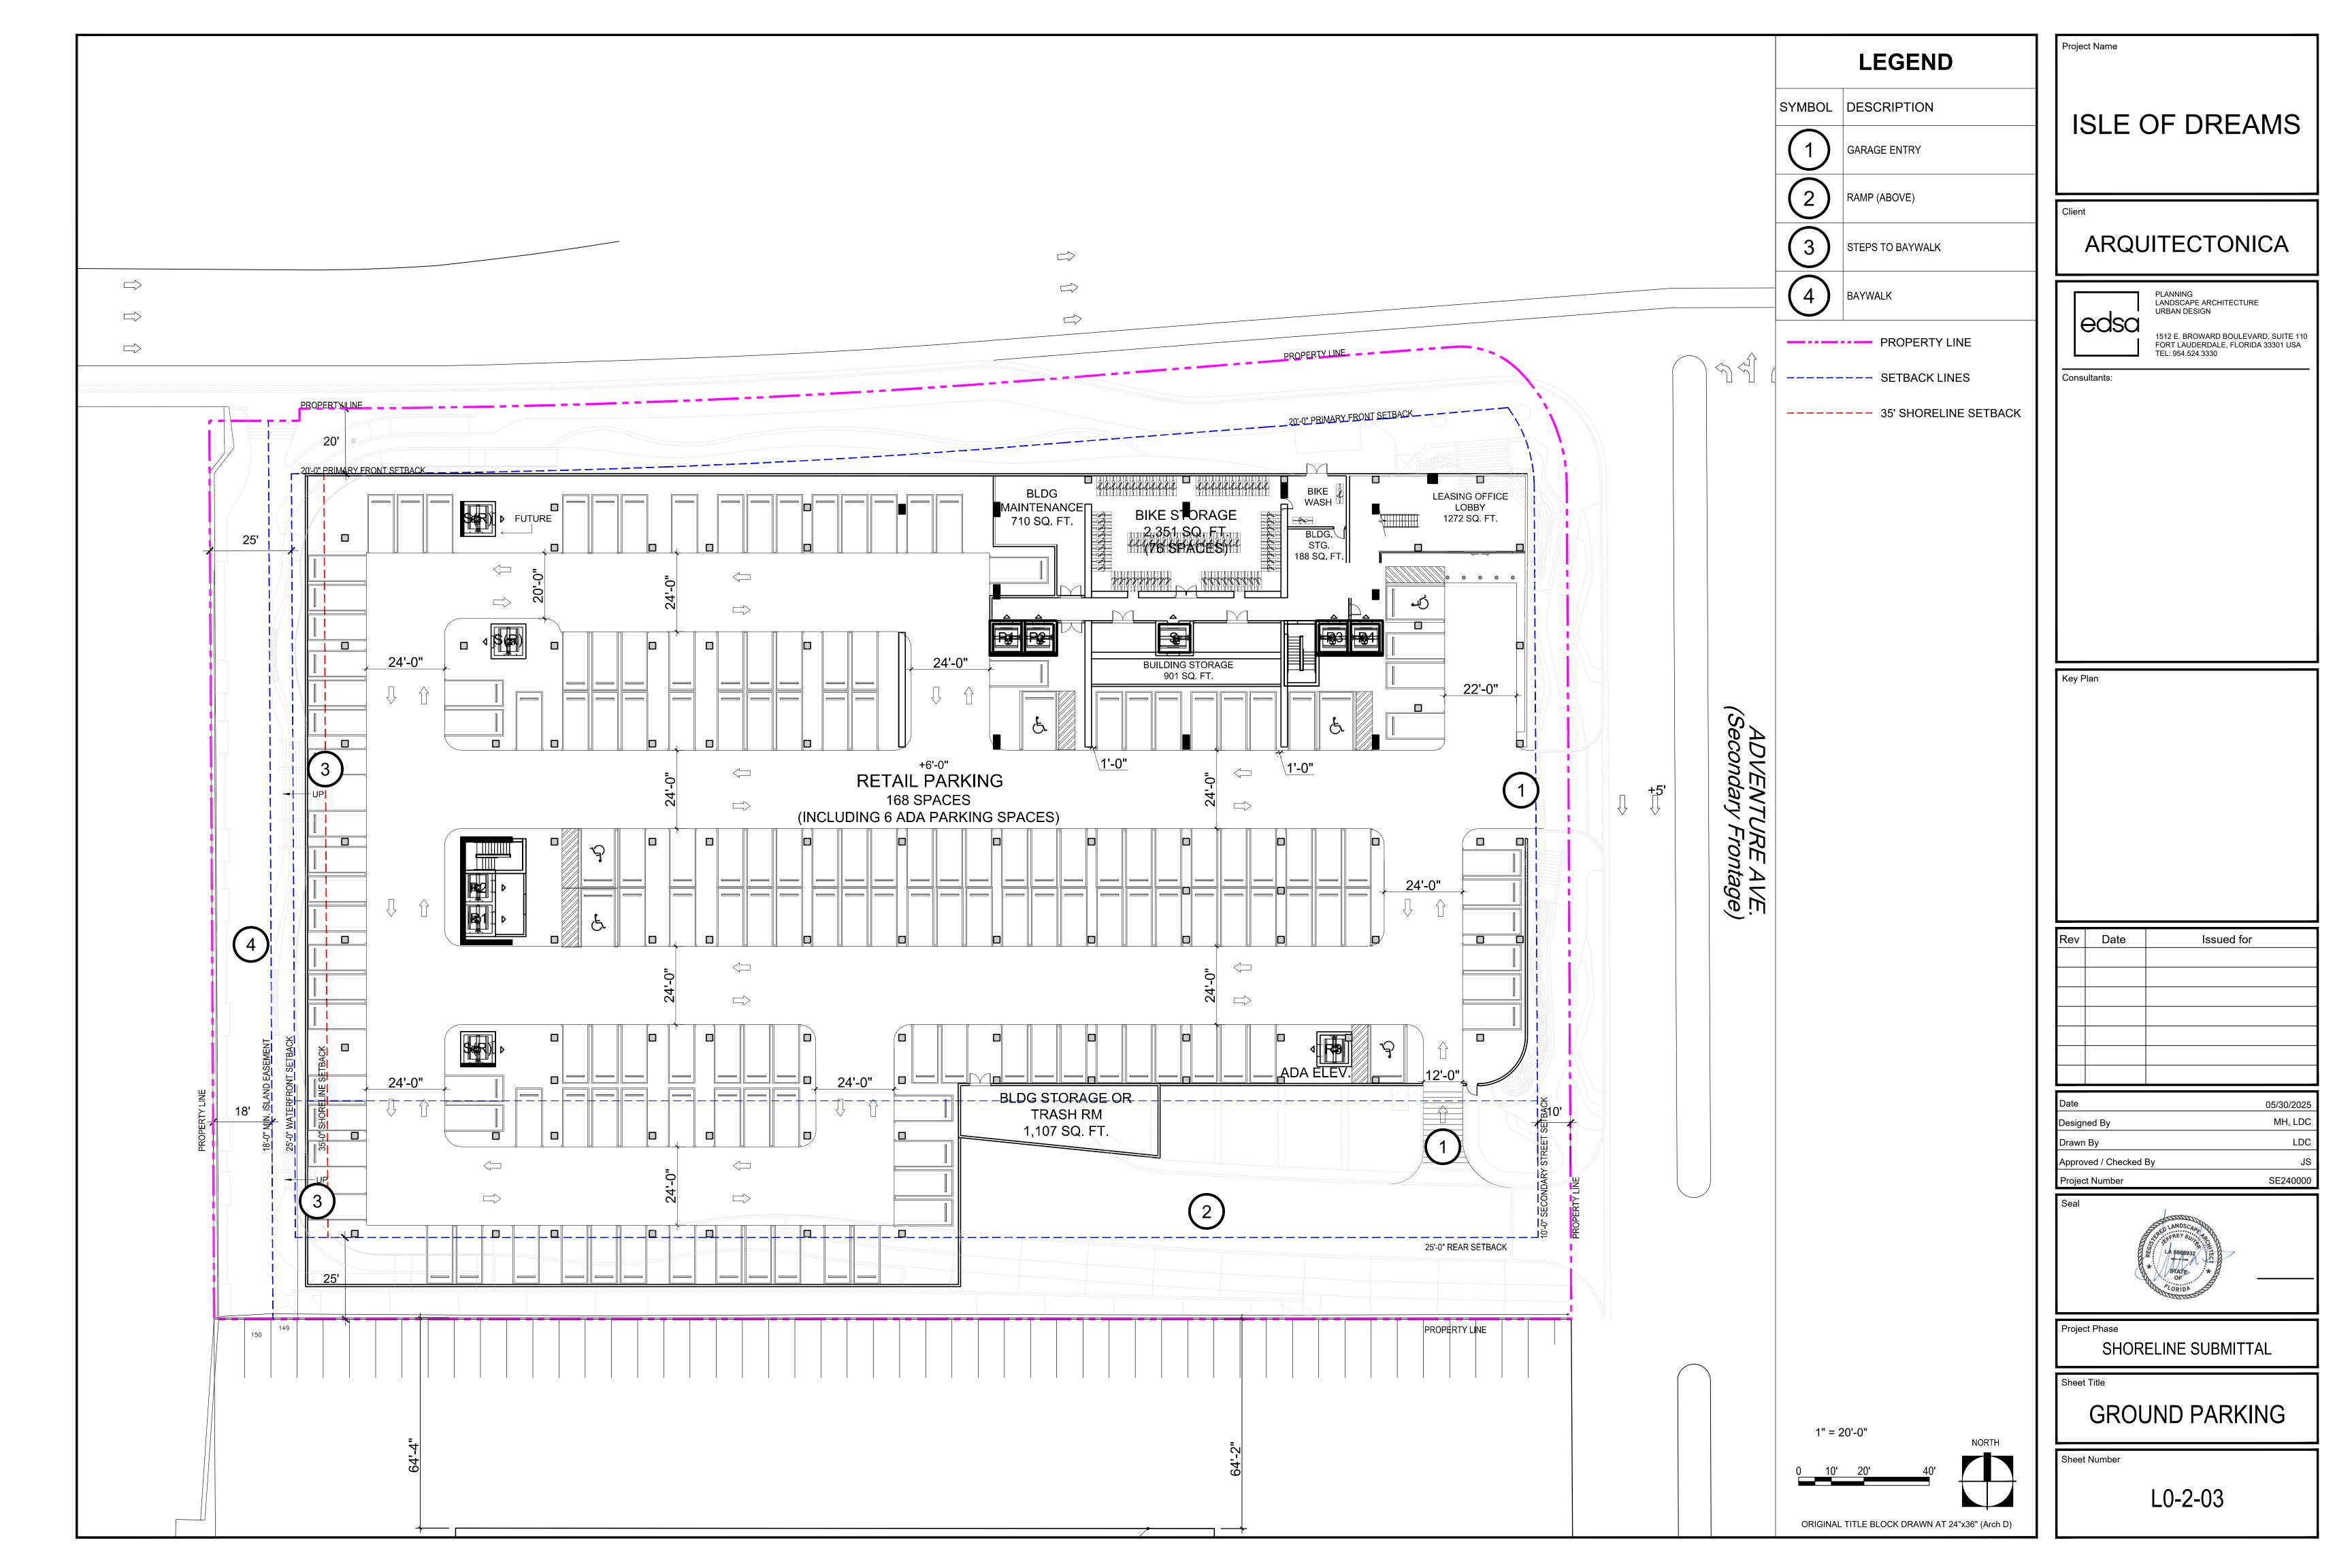

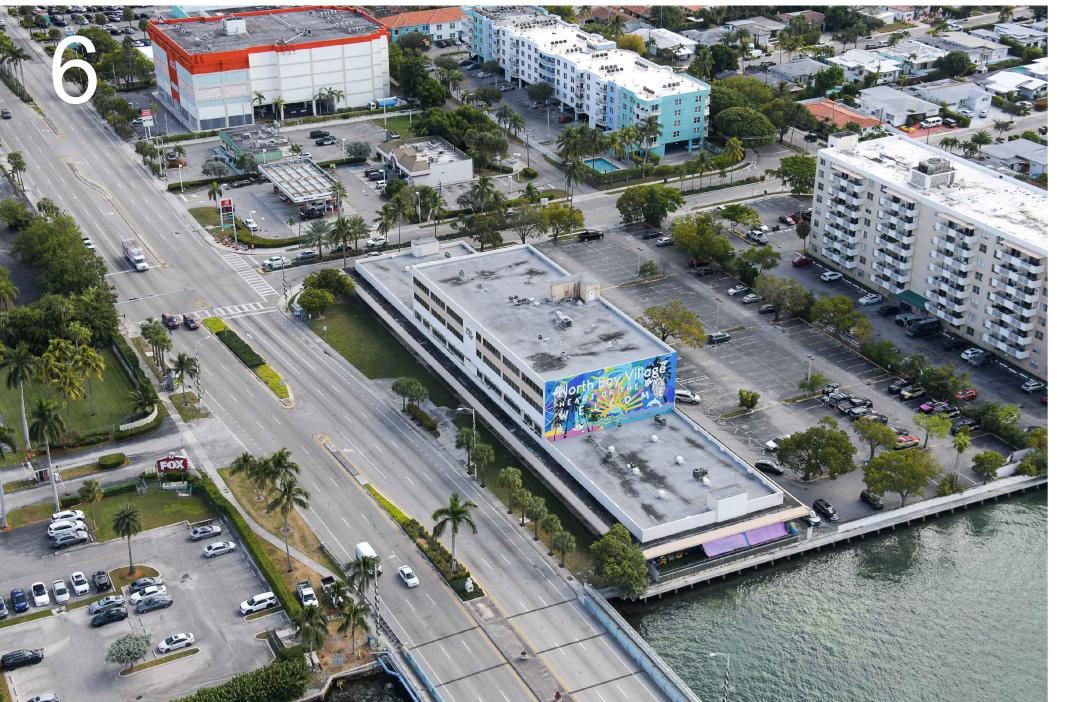

AERIAL PHOTOS SYMBOL DESCRIPTION 1 VIEW FROM SOUTHWEST 2 VIEW FROM SOUTH 3 VIEW FROM SOUTHEAST 4 VIEW FROM NORTHEAST 5 VIEW FROM WEST

VIEW FROM NORTHWEST

Project Name

ISLE OF DREAMS

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 Designed By
 MH, LDC

 Drawn By
 LDC

 Approved / Checked By
 JS

 Project Number
 SE240000



roject Phase

SHORELINE SUBMITTAL

Sheet Title

SITE PHOTOS

Sheet Number

L0-2-04

ORIGINAL TITLE BLOCK DRAWN AT 24"x36" (Arch D)

DEMOLITION / SITE CLEARING GENERAL NOTES:

- 1. PRIOR TO INITIATING DEMOLITION AND/OR SITE CLEARING THE CONTRACTOR SHALL PROVIDE FOR THE FOLLOWING:
- A. ALL SEDIMENT AND EROSION CONTROL MEASURES SHALL BE INSTALLED AND FULLY OPERATIONAL. SEE CIVIL ENGINEERING CONTRACT DOCUMENTS FOR REQUIREMENTS AND DETAILS.
- B. ERECT BARRICADES TO PROTECT EXISTING TREES INDICATED TO REMAIN. SEE TREE PROTECTION REQUIREMENTS FOR ADDITIONAL REQUIREMENTS AND DETAILS.
- C. COORDINATE WITH ALL UTILITY COMPANIES THAT MAY HAVE UTILITY SERVICES ON THIS SITE TO OBTAIN ALL PERMITS AS APPLICABLE. CONTRACTOR SHALL MAKE ALL ARRANGEMENTS AS REQUIRED T TAKE SUCH UTILITY SYSTEMS OUT OF SERVICE IF REQUIRED.
- D. UTILITIES OUTSIDE OF HE LIMITS OF CONSTRUCTION ARE TO BE MAINTAINED AND OPERATIONAL THROUGHOUT ALL PHASES OF CONSTRUCTION.
- E. OWNER RESERVES THE RIGHT TO SALVAGE ANY MATERIAL, FIXTURES OR EQUIPMENT FROM THE SITE PRIOR TO DEMOLITION.
- F. ALL EXISTING SITE FACILITIES TO REMAIN SHALL BE PROTECTED FROM ANY DAMAGE THROUGHOUT ALL PHASES OF CONSTRUCTION. THE CONTRACTOR SHALL REPAIR ANY DAMAGE TO SAID FACILITIES THAT OCCURS DUE TO WORK PERFORMED BY THE CONTRACTOR CALLED FOR IN THE CONTRACT DOCUMENTS.

DEMOLITION / SITE CLEARING NOTES:

- 1. THE CONTRACTOR SHALL PROVIDE AT LEAST 48-HOUR NOTICE TO ALL UTILITY COMPANIES PRIOR TO INITIATING DEMOLITION AND/OR SITE CLEARING TO PROVIDE FIELD LOCATES OF EXISTING UTILITIES.
- 2. REMOVE IN THEIR ENTIRETY ALL BUILDINGS, PAVEMENTS, STRUCTURES, RUBBISH, DEBRIS, UTILITIES AND ALL OTHER APPURTENANCES WHICH ARE NECESSARY TO PERMIT THE PROPOSED CONSTRUCTION AS DESIGNATED ION THE CONSTURCITON DOCUMENTS.
- 3. ALL VEGETATIVE GROWTH, TIMER AND BRUSH SHALL BE REMOVED TO A DEPTH OF 18 INCHES BELOW NATURAL GROUND OR DESIGN GRADE WHICHEVER IS LOWER.
- 4. PAVEMENTS TO BE REMOVED SHALL BE SAW CUT TO ENSURE A CLEAN EDGE. CONCRETE PAVEMENT SHALL BE REMOVED TO THE NEAREST CONTROL JOINT WHERE APPLICABLE.
- 5. ALL DELETERIOUS SUBSURFACE MATERIAL (I.E. MUCK, PEAT, BURIED DEBRIS) IS TO BE EXCAVATED AND REMOVED. EXCAVATED
- AREAS SHALL BE BACKFILLED WITH CLEAN BUILDERS SAND AND RETURNED TO NATURAL GROUND OR DESIGN GRADE.

 6. AFTER DEMOLITION / SITE CLEARING TILL/DISK ALL SURFACES TO A DEPTH OF SIX INCHES (6") AND REMOVE ANY REMAINING
- DELETERIOUS MATERIAL GREATER THAN 1 INCH (1") IN DIAMETER.

 7. SHOULD ANY HAZARDOUS MATERIALS BE ENCOUNTERED DURING DEMOLITION AND/OR SITE CLEARING THE CONTRACTOR SHALL CEASE WORK IMMEDIATELY IN THE AFFECTED AREA AND NOTIFY THE OWNERS REPRESENTATIVE FOR DIRECTION ON HOW TO
- 8. ALL DEBRIS AND WASTE MATERIALS GENERATED BY DEMOLITION AND/OR SITE CLEARING ACTIVITIES SHALL BE DISPOSED OFF-SITE IN A LEGAL MANNER AT AN APPROVED DISPOSAL FACILITY. THE CONTRACTOR SHALL OBTAIN ALL PERMITS REQUIRED FOR THE HAULING AND DISPOSAL OF WASTE MATERIAL.

TREE/PALM PROTECTION NOTES:

PROCEED.

- 1. THE CONTRACTOR SHALL CALL FOR AND ATTEND AN INSPECTION OF EXISTING TREES/PALMS TO REMAIN WITH THE OWNERS REPRESENTATIVE PRIOR TO COMMENCING DEMOLITION AND/OR SITE CLEARING.
- 2. ALL TREE/PALM PROTECTION SHALL COMPLY WITH ANSI A-300 STANDARDS FOR TREE CARE. ALL TREE CARE ACTIVITIES INCLUDING BUT NOT LIMITED TO CROWN PRUNING, FERTILIZING AND ROOT PRUNING SHALL BE CONDUCTED BY OR PREFORMED UNDER SUPERVISION OF AN ISA CERTIFIED ARBORIST. THE CONTRACTOR SHALL BE RESPONSIBLE FOR OBTAINING AND SHALL BE EAR THE COST OF THE ARBORIST.
- 3. ERECT TREE/PALM PROTECTION BARRICADES AS DETAILED IN THE CONTRACT DOCUMENTS. ALL BARRICADES SHALL BE PLACED A MINIMUM OF TEN FEET (10') CLEAR DISTANCE FROM THE FACE OF ANY PROTECTED TREE/PALM OR AS INDICATED BY EXISTING CODE OR ORDINANCES WHICHEVER IS GREATER. BARRICADES SHALL FULLY ENCLOSE ALL TREES/PALMS TO REMAIN.
- 4. NOTHING SHALL BE PLACED INSIDE THE BARRICADES INCLUDING BUT NOT LIMITED TO CONSTRUCTION MATERIAL, MACHINERY, CHEMICALS, VEHICLES, OR SOIL DEPOSITS. ANY ACTIVITY THAT INVOLVES DISTURBING SOIL WITHIN THE BARRICADES SHALL BE DONE BY HAND OR LIGHT RUBBER WHEELED EQUIPMENT THAT WILL NOT COMPACT THE SOIL OR DAMAGE THE TREE/PALM ROOTS
- 5. ALL TREES SUBJECT TO ENCROACHMENT INTO THE DRIP LINE DUE TO PROPOSED CONSTRUCTION SHALL BE ROOT PRUNED EIGHTEEN INCHES (18") FROM THE EDGE OF SAID CONSTRUCTION.
- A. ROOT PRUNING SHALL CONSIST OF DIGGING A TRENCH FORTY-EIGHT INCHES (48") DEEP BY SIX INCHES (6") WIDE EITHER BY HAND OR WITH A TRENCHING MACHINE DESIGNED FOR THIS PURPOSE. ALL ROOTS SHALL BE CLEAN CUT WITH NO SPLITS OR TEARS.
- B. TRENCH SHALL BE FILLED WITH TOPSOIL (SEE LANDSCAPE NOTES) PLACED IN TWELVE INCH (12") LIFTS. EACH LIFT SHALL BE WATERED IN TO PREVENT AIR POCKETS.
- 6. BARRICADES SHALL REMAIN IN PLACE FOR THE DURATION OF CONSTRUCTION OR AS DIRECTED BY THE OWNERS REPRESENTATIVE.
- 7. PROTECTED TREES/PALMS DEEMED UNACCEPTABLE BY THE OWNERS REPRESENTATIVE AT THE PROJECT COMPLETION DUE TO DAMAGE, LACK OF PROTECTION OR NEGLIGENCE ON THE PART OF THE CONTRACTOR SHALL BE REMOVED IN THEIR ENTIRETY AND REPLACED WITH A COMPARABLE SPECIMEN AT NO ADDITIONAL COST TO THE OWNER.

PROTECT COORDINATION NOTES:

- 1. THE CONTRACTOR SHALL COORDINATE AND SCHEDULE ALL WORK TO INTERFACE SMOOTHLY WITH OTHER WORK BEING PREFORMED ON OR ADJACENT TO THE SITE BY OTHER CONTRACTORS AND UTILITY COMPANIES.
- 2. CONTRACTOR SHALL REFER TO THE HARDSCAPE NOTES, LANDSCAPE NOTES, SPECIFICATIONS AND THE CONTRACT DOCUMENTS PREPARED BY BUT NOT LIMITED TO ARCHITECTURAL, MEP, IRRIGATION, STRUCTURAL AND CIVIL ENGINEERING CONSULTANTS FOR ADDITIONAL REQUIREMENTS.

TREE / PALM RELOCATION GENERAL NOTES:

- 1. TREES/PALMS TO BE RELOCATED ARE DESIGNATED ON THE DRAWINGS OR AS IDENTIFIED BY THE OWNERS REPRESENTATIVE.
- 2. THE CONTRACTOR SHALL CALL FOR AND ATTEND AN INSPECTION OF THE EXISTING CONDITIONS WITH THE OWNERS REPRESENTATIVE AT BOTH THE CURRENT AND PROPOSED LOCATIONS OF RELOCATIONS PRIOR TO COMMENCING WORK. THE CONTRACTOR SHALL SUBMIT A WRITTEN REPORT DOCUMENTING THE EXISTING CONDITIONS INCLUDING BUT NOT LIMITED TO PHOTOGRAPHS IDENTIFYING TREES/PALMS TO BE RELOCATED, POTENTIAL OBSTRUCTIONS AND IDENTIFICATION OF A PROPOSED MOVING ROUTE THAT AVOIDS AND PROTECTS OVERHEAD AND UNDERGROUND UTILITIES. THE REPORT WILL SERVE AS A REFERENCE POINT FOR MONITORING THE EXISTING CONDITIONS WHICH WILL BECOME THE RESPONSIBILITY OF THE CONTRACTOR TO KEEP INTACT.
- 3. ALL TREE/PALM RELOCATIONS SHALL COMPLY WITH ANSI A-300 STANDARDS FOR TREE RELOCATIONS. ALL RELOCATION ACTIVITIES SHALL BE CONDUCTED BY OR PREFORMED UNDER THE SUPERVISION OF AN ISA CERTIFIED ARBORIST. THE CONTRACTOR SHALL BE RESPONSIBLE FOR OBTAINING AND SHALL BEAR THE COST OF THE ARBORIST.
- 4. THE CONTRACTOR SHALL NOTIFY THE OWNERS REPRESENTATIVE 24 HOURS IN ADVANCE OF EACH RELOCATION TO ALLOW FOR OBSERVATION OF THE PROCEDURES.
- 5. TREES/PALMS SHALL ONLY BE MOVED ONCE, WITHIN 24 HOURS OF THE PLANTS EXCAVATION. NO NURSERY OR HOLDING ARE MAY BE USED.

PREPARATION NOTES:

- 1. TREES SIX INCH (6") CALIPER OR LESS AND PALMS OTHER THAN THOSE LISTED AS SPECIMEN PALMS MAY BE RELOCATED BY MECHANICAL MACHINERY AND DO NOT REQUIRE ROOT PRUNING. (SEE MECHANICAL RELOCATION)
- 2. TREES/PALMS REQUIRING ROOT PRUNING SHALL HAVE THIS PREFORMED ACCORDING TO THE FOLLOWING SCHEDULE:
- B. TREES FIFTEEN INCH (15") TO TWENTY-EIGHT INCH (28") CALIPER.......6 MONTHS PRIOR TO RELOCATING.
- C. TREES OVER TWENTY-EIGHT INCH (28") CALIPER......9 MONTHS PRIOR TO RELOCATING.
- 3. EQUIPMENT USED FOR ROOT PRUNING SHALL BE DESIGNED FOR THIS TASK AND SHALL PRODUCE CLEAN CUTS OF ROOTS WITHOUT DAMAGE TO THE RESULTING ROOT BALL.
- 4. TREES SHALL HAVE A MINIMUM ROOT BALL SIZE OF TEN INCHES (10") PER ONE INCH (1") OF CALIPER. ROOT BALLS ARE TO BE FORMED SQUARE WITH EQUAL DISTANCE FROM THE TRUNK.
- 5. SPECIMEN PALMS SHALL HAVE A MINIMUM ROOT BALL OF THIRTY-SIX INCHES (36") AND SHALL BE FORMED SQUARE WITH EQUAL DISTANCE FROM THE TRUNK.
- 6. ROOT BALLS FOR TREES/PALMS SHALL BE FORMED BY DIGGING A TRENCH FORTY-EIGHT INCHES (48") DEEP AND SIX INCHES (6") WIDE EITHER BY HAND OR BY A TRENCHING MACHINE DESIGNED FOR THE PURPOSE.
- 7. IF ROOT PRUNING HAS BEEN PERFORMED OUTSIDE OF THE SCOPE OF THIS CONTRACT THE CONTRACTOR SHALL CONFIRM IN WIRITING WITH THE OWNERS REPRESENTATIVE THAT ROOT PRUNING HAS BEEN ACCOMPLISHED AS DESCRIBED ABOVE.

HAND DIGGING / RELOCATION NOTES:

- 1. TREES/PALMS SHALL BE PRUNED AS DIRECTED BY THE ARBORIST PRIOR TO DIGGING.
- 2. ALL ROOT BALLS SHALL BE THOROUGHLY SOAKED FOR SEVEN (7) DAYS PRIOR TO DIGGING.
- 3. EXCAVATE TWELVE INCHES (12") OUTSIDE OF PREVIOUS ROOT PRUNING TO A DEPTH OF FORTY-EIGHT INCHES (48").
- 4. ROOT BALLS SHALL BE UNDERCUT PRIOR TO LIFTING. DO NOT FORCE TREE/PALM FROM GROUND.
- 5. TREES/PALMS SHALL BE LIFTED AND TRANSPORTED IN SUCH A MANNER AS TO AVOID DAMAGE TO BARK, LIMBS, TRUNKS OR FRONDS. SUPPORT CHAINS, STRAPS AND/OR CABLES SHALL BE PADDED AS REQUIRED. OWNERS REPRESENTATIVE RESERVES THE RIGHT TO REQUIRE DOWELING IN LIEU OF LIFTING BY STRAPS.
- 6. EXCAVATE NEW PLANT PIT TWENTY-FOUR INCHES (24") WIDER THAN ROOT BALL AND TO A DEPTH THAT ALLOWS NEW ROOT BALL TO BE SITUATED THREE INCHES (3") ABOVE PROPOSED GRADE.
- 7. ROTATE TREE/PALM PRIOR TO SETTING TO ACHIEVE BEST POSITIONING AS DIRECTED BY THE OWNERS REPRESENTATIVE.
- 8. BACKFILL PLANTING PIT WITH PREPARED PLANTING SOIL (SEE LANDSCAPE NOTES/SPECIFICATIONS) IN TWELVE INCH (12") LIFTS THOROUGHLY DRENCHING EACH LIFT WITH WATER TO PREVENT AIR POCKETS.
- 9. APPLY FERTILIZER, TRANSPLANT INOCULANTS AND ROOT STIMULANTS AS DIRECTED BY THE ARBORIST.
- 10. TREES/PALMS SHALL BE STAKED AND MULCHED ACCORDING TO THE LANDSCAPE DETAILS.

MECHANICAL DIGGING / RELOCATION NOTES:

- TREES/PALMS SHALL BE PRUNED AS DIRECTED BY THE ARBORIST PRIOR TO DIGGING.
- 2. TREE SPADES SHALL B E LARGE ENOUGH TO ENCOMPASS THE FIBROUS FEEDER ROOTS OF EACH PLANT. TREE SPADES USED TO RELOCATE TREES/ NON-SPECIMEN PALMS SHALL MEET THE FOLLOWING CRITERIA:
- A. TREES UP TO THREE INCH (3") CALIPER......FORTY-FOUR INCH (44") SPADE
- B. TREES THREE INCH (3") TO FIVE INCH (5") CALIPER.......SIXTY INCH (60") SPADE
- C. TREES UP TO EIGHT INCH (8") CALIPER AND NON-SPECIMEN PALMS......NINETY INCH (90") SPADE
- 3. USE SAME MACHINE TO DIG RECEIVING HOLE AND TO DIG TREE/PALM FOR TRANSPLANTING.
- 4. TREE SPADES SHALL HAVE A MAXIMUM TOLERANCE OF TWO INCHES (2") BETWEEN BLADES AND SHALL BE MOUNTED TO A STABLE MACHINE CAPABLE OF SUPPORTING THE WEIGHT OF ALL RELOCATED MATERIAL.
- CENTER TREE/PALM IN THE SPADE WHEN DIGGING. CLEAN CUT ANY ROOTS PROTRUDING FROM THE DIGGING SPADE FLUSH WITH THE ROOT BALL BEFORE PLANTING.
- 6. AFTER PLACING TREE/PALM IN RECEIVING HOLE IMMEDIATELY FILL ALL CREVICES/VOIDS WITH PREPARED PLANTING SOIL. (SEE LANDSCAPE NOTES/SPECIFICATIONS) THOROUGHLY DRENCH WITH WATER TO PREVENT AIR POCKETS.
- 7. APPLY FERTILIZER, TRANSPLANT INOCULANTS AND ROOT STIMULANTS AS DIRECTED BY THE ARBORIST.
- 8. TREES/PALMS TO BE STAKED AND MULCHED ACCORDING TO THE LANDSCAPE DETAILS.

TREE / PALM RELOCATION POST PLANTING MAINTENANCE NOTES:

- 1. DURING THE PROJECT WORK PERIOD PRIOR TO SUBSTANTIAL COMPLETION ACCEPTANCE, THE CONTRACTOR SHALL MAINTAIN ALL TRANSPLANTED TREES/PALMS.
- 2. MAINTENANCE DURING THE PERIOD PRIOR TO SUBSTANTIAL COMPLETION ACCEPTANCE SHALL CONSIST OF WATERING, REMOVAL OF DEAD MATERIAL, REPAIRING AND/OR REPLACING STAKING, RESETTING PLANTS TO PROPER GRADES AND UPRIGHT POSITIONS AND APPLYING SUCH SPRAYS AS DIRECTED BY THE ARBORIST AS NECESSARY TO KEEP PLANT MATERIAL REASONABLY FREE OF DAMAGING INSECTS AND DISEASE.
- 3. ALL RELOCATED TREES/PALMS SHALL BE IRRIGATED BY HAND OR TEMPORARY AUTOMATIC IRRIGATION SYSTEM UNTIL A PERMANENT IRRIGATION SYSTEM IS OPERATIONAL.
- 4. IRRIGATION FOR TREES SHALL INCLUDE MIST HEADS AS DIRECTED BY ARBORIST.

RELATED TO THE TREE/PALM TRANSPLANTING IS COMPLETE.

SUBSTANTIAL COMPLETION ACCEPTANCE NOTES:

- 1. UPON WRITTEN NOTICE FROM THE CONTRACTOR, THE OWNERS REPRESENTATIVE SHALL REVIEW THE WORK AND DETERMINE IF THE WORK IS SUBSTANTIALLY COMPLETE.
- 2. FOR THE PURPOSE OF ACCEPTANCE, THE RELOCATED TREES/PALMS TO BE HEALTHY, VIGOROUS, UNDAMAGED AND EXHIBIT EVIDENCE OF ESTABLISHING NEW ROOTS.
- 3. THE MINIMUM ALLOWABLE RATE OF SURVIVAL OF ALL RELOCATED MATERIAL SHALL BE 90%. DETERMINATION OF SURVIVABILITY SHALL BE MADE BY THE OWNERS REPRESENTATIVE AT THE COMPLETION.
- WITH A COMPARABLE SPECIMEN AT NO ADDITIONAL COST TO THE OWNER.

 5. THE DATE OF SUBSTANTIAL COMPLETION SHALL BE THE DATE WHEN THE OWNERS REPRESENTATIVE ACCEPTS THAT ALL WORK

4. ANY TREE/PALM THAT IS DEEMED UNACCEPTABLE AS A PRODUCT OF NEGLIGENCE BY THE CONTRACTOR SHALL BE REPLACED

6. ALL TRANSPLANTED TREES/PALMS SHALL BE WARRANTED FOR A PERIOD OF ONE (1) YEAR FROM THE DATE OF WRITTEN NOTIFICATION OF SUBSTANTIAL COMPLETION FROM THE OWNERS REPRESENTATIVE. THE DATE OF SUBSTANTIAL COMPLETION MAY VARY FROM THE DATE OF SUBSTANTIAL COMPLETION FOR OTHER PORTION OF THE PROJECT.

ISLE OF DREAMS

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PLANNING LANDSCAPE ARCHITECTURE URBAN DESIGN

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Consultants:

Key Plan

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SE240000

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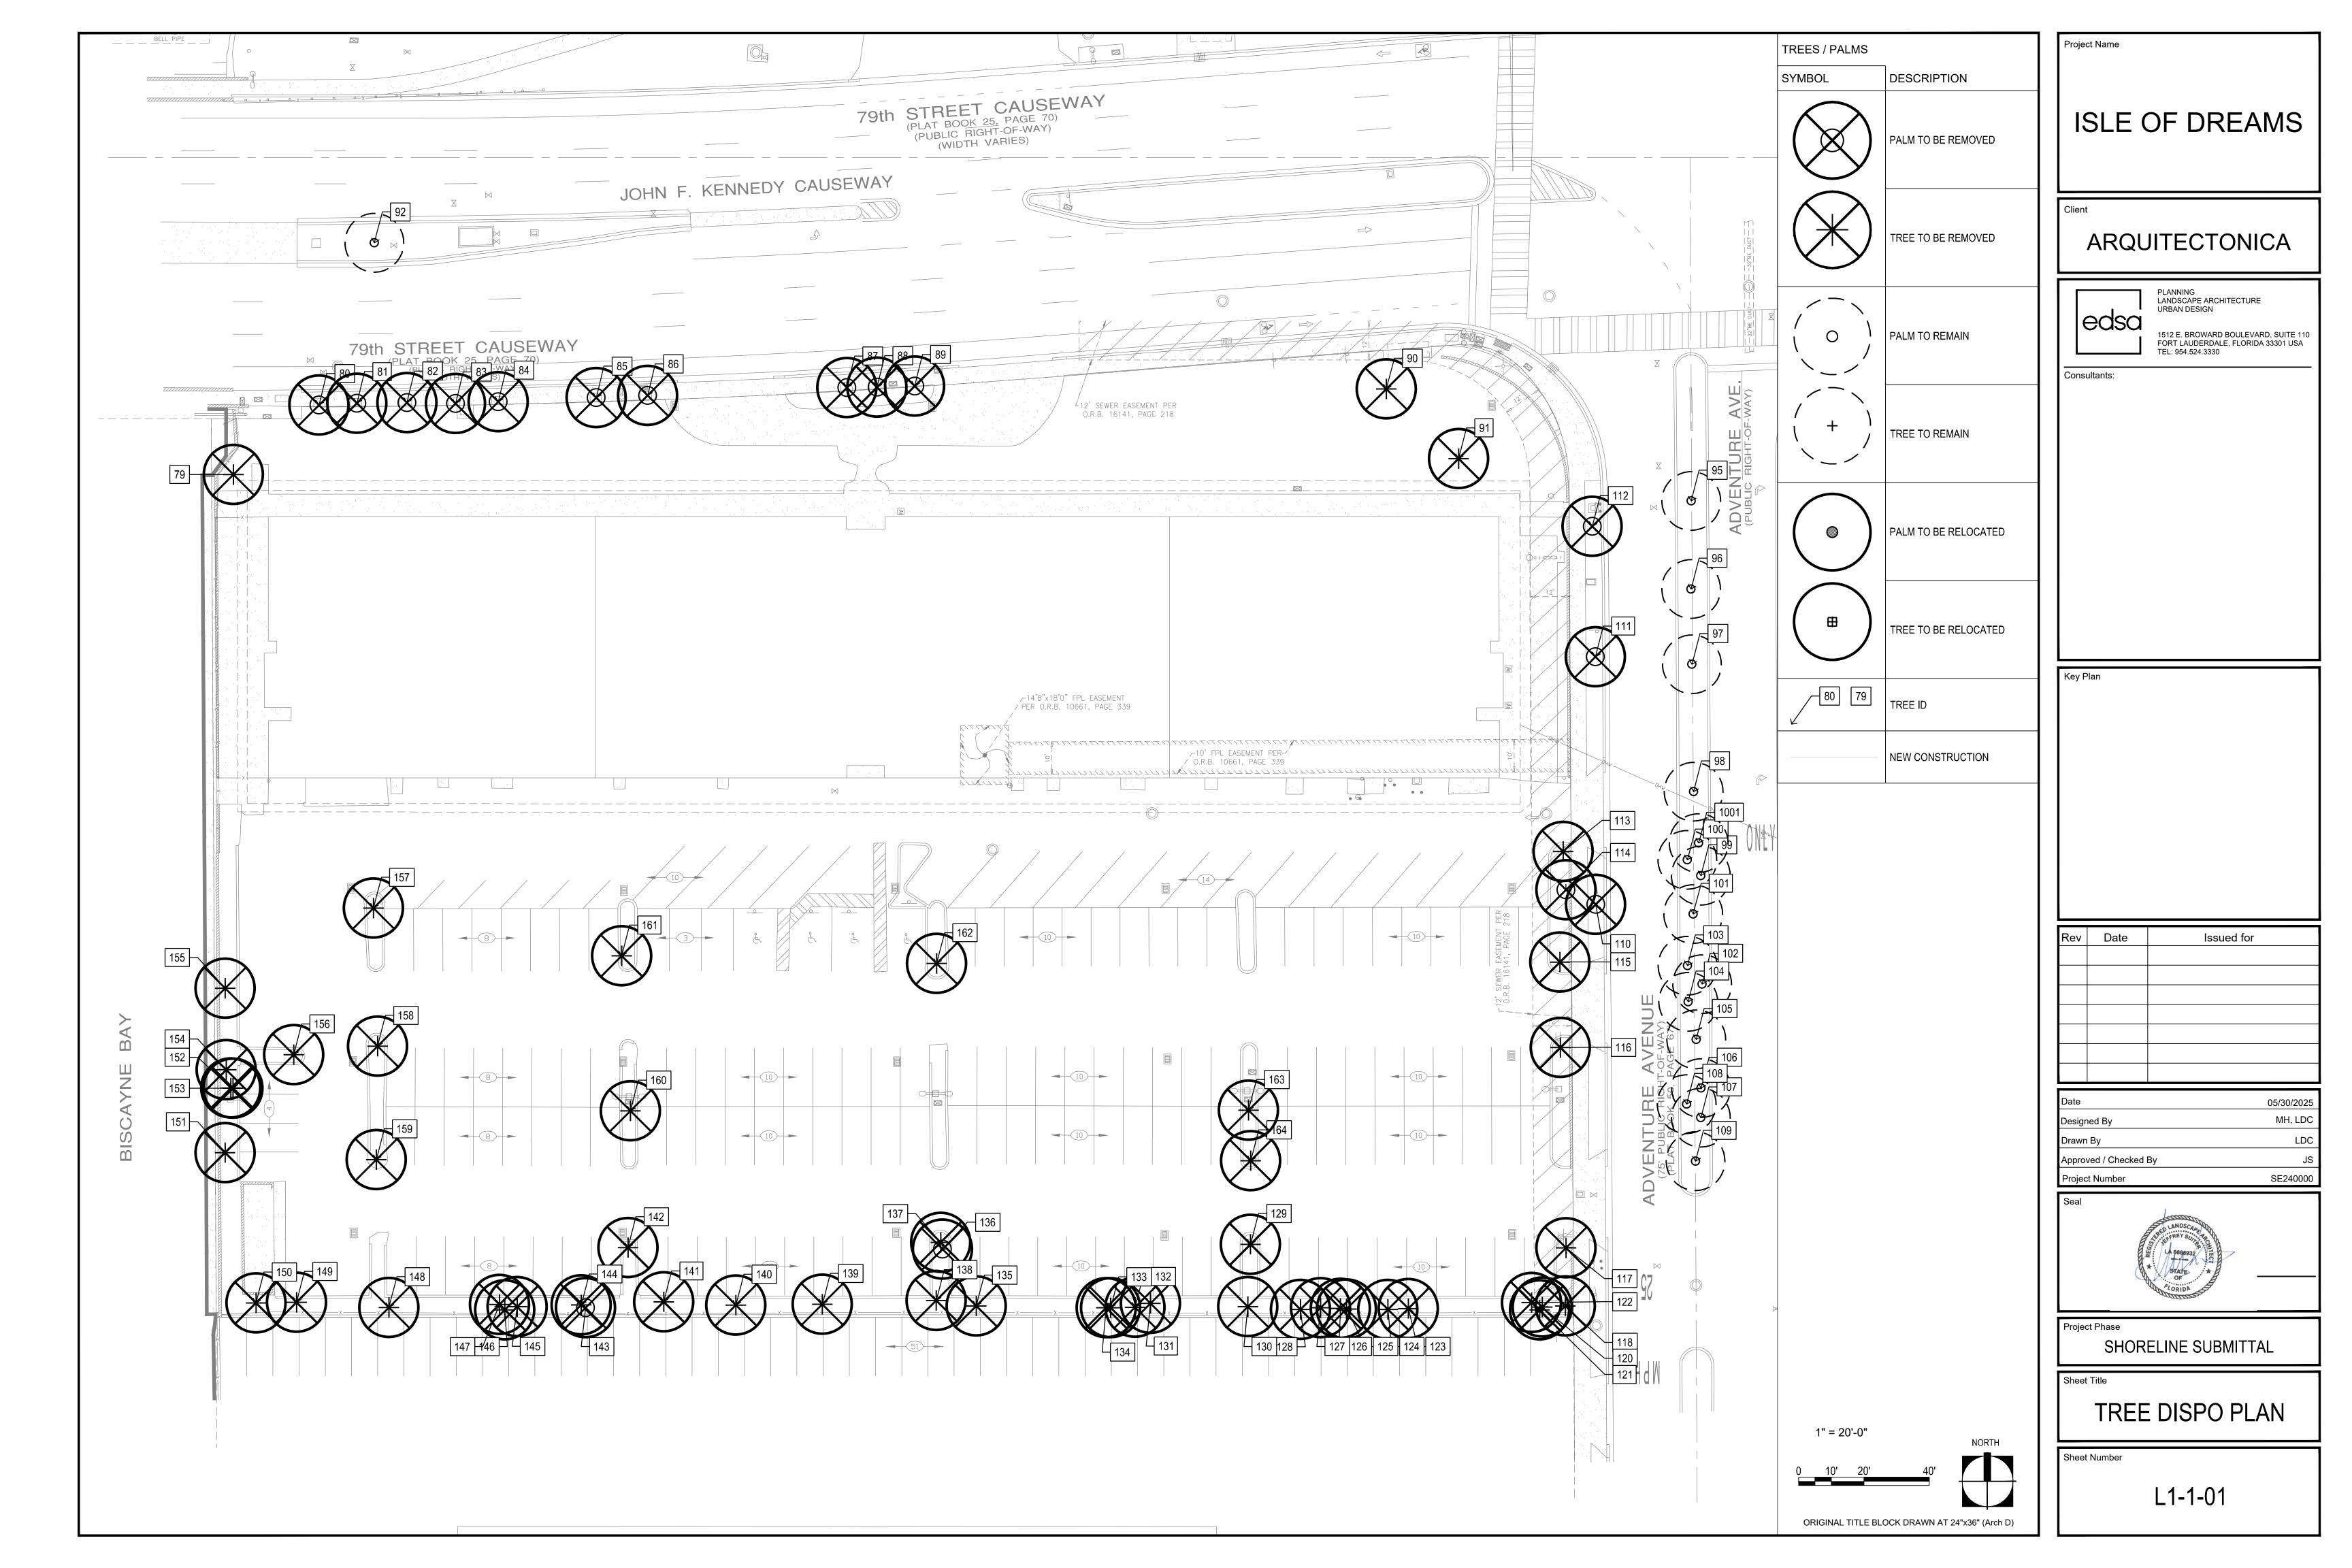
SHORELINE SUBMITTAL

Sheet Title

GENERAL NOTES

Sheet Number

L0-5-01



osition Requirem	(sq.ft.)	Condition	Action	Canopy (feet)	Height (feet)	TPZ (feet)	(inches)	Botanical Name	Conmon Name	e Number
98	490.63	30% Poor 70% Good	REMOVE REMOVE	25 14	25 17	16 5.5	32 11	Coccoloba uvifera Sabal palmetto	Sea grape Sabal palm	79
30 ⁷	153.86 153.86	70% Good	REMOVE	14	20	5.5	10	Sabal palmetto	Sabal palm	80
307	153.86	70% Good	REMOVE	14	20	5.5	11	Sabal palmetto	Sabal palm	82
307	153.86	70% Good	REMOVE	14	17	5	10	Sabal palmetto	Sabal palm	83
307	153.86	70% Good	REMOVE	14	20	5	10	Sabal palmetto	Sabal palm	84
307	153.86	70% Good	REMOVE	14	20	5.5	11	Sabal palmetto	Sabal palm	85
307	153.86	70% Good	REMOVE	14	20	6.5	13	Sabal palmetto	Sabal palm	86
307	153.86	70% Good 70% Good	REMOVE	14 14	20	6	12 12	Sabal palmetto Sabal palmetto	Sabal palm Sabal palm	87
30 ⁷	153.86 153.86	70% Good	REMOVE REMOVE	14	15	6	12	Sabal palmetto	Sabal palm	88
1	706.50	40% Poor	REMOVE	30	20	11	22	Bursera simaruba	Gumbo limbo	90
	706.50	40% Poor	REMOVE	30	20	14.75	29.5	Bursera simaruba	Gumbo limbo	91
353	176.63	70% Good	REMAIN	15	30	7.5	15	Roystonea regia	Royal palm	92
	314.00	70% Good	REMOVE	20	20	10	20	Phoenix dactylifera	Date palm	95
	314.00	70% Good	REMOVE	20	20	7	14	Phoenix dactylifera	Date palm	96
508	254.34	70% Good	REMOVE	18	18	3.5	7	Cocos nucifera	Coconut palm	97
40	200.96	70% Good	REMAIN	16	16	3	6	Cocos nucifera	Coconut palm	98
56	28.26	70% Good 70% Good	REMAIN	6 8	6 8	1.75	3.5 4	Thrinax radiata Thrinax radiata	Thatch palm Thatch palm	99
100	50.24 28.26	70% Good	REMAIN REMAIN	6	6	2	4	Thrinax radiata Thrinax radiata	Thatch palm	100 l01a
56	314.00	70% Good	REMAIN	20	20	4.75	9.5	Cocos nucifera	Coconut palm	101
56	28.26	70% Good	REMAIN	6	6	2	4	Thrinax radiata	Thatch palm	102
39	19.63	70% Good	REMAIN	5	5	2	4	Thrinax radiata	Thatch palm	103
56	28.26	70% Good	REMAIN	6	6	2	4	Thrinax radiata	Thatch palm	104
508	254.34	70% Good	REMAIN	18	18	4.25	8.5	Cocos nucifera	Coconut palm	105
39	19.63	70% Good	REMAIN	5	5	2	4	Thrinax radiata	Thatch palm	106
39	19.63	70% Good	REMAIN	5	5	2	4	Thrinax radiata	Thatch palm	107
56	28.26	70% Good	REMAIN	6	6	1.75	3.5	Thrinax radiata	Thatch palm	108
	314.00	70% Good	REMAIN	20	35	4.75	9.5	Cocos nucifera	Coconut palm	109
	314.00	70% Good 70% Good	REMOVE REMOVE	20 20	33 40	5.5 7	11 14	Cocos nucifera Cocos nucifera	Coconut palm Coconut palm	110
	314.00 314.00	70% Good	REMOVE	20	35	6.25	12.5	Cocos nucifera	Coconut palm	111 112
1	706.50	70% Good	REMOVE	30	25	11.25	22.5	Swietenia mahagoni	Mahogany	113
353	176.63	45% Fair	REMOVE	15	7	8	16	Sabal palmetto	Sabal palm	114
1	706.50	45% Fair	REMOVE	30	30	10.25	20.5	Swietenia mahagoni	 Mahogany	115
98	490.63	45% Fair	REMOVE	25	25	8.25	16.5	Swietenia mahagoni	Mahogany	116
100	50.24	25% Poor	REMOVE	8	8	3.25	6.5	Coccoloba diversifolia	Pigeon plum	117
	314.00	50% Fair	REMOVE	20	25	6.5	13	Swietenia mahagoni	Mahogany	118
508	254.34	40% Poor	REMOVE	18	18	3.25	6.5	Tabebuia rosea	Pink tabebuia	120
	78.50	50% Fair	REMOVE	10	10	6	12	Sabal palmetto	Sabal palm	121
50	28.26	40% Poor	REMOVE	6	15	2.25	4.5	Tabebuia rosea	Pink tabebuia	122
220	113.04	50% Fair 40% Poor	REMOVE	12 6	10 6	3.5 2.5		Coccoloba diversifolia Coccoloba diversifolia	Pigeon plum Pigeon plum	123
50	28.26	45% Fair	REMOVE REMOVE	20	30	5.75	11.5	Acacia auriculiformis	Earleaf acacia	124 125
	Invasive Invasive	30% Poor	REMOVE	16	25	3.75	7.5	Acacia auriculiformis	Earleaf acacia	126
192	961.63	30% Poor	REMOVE	35	33	7.75	15.5	Swietenia mahagoni	Mahogany	127
	Invasive	20% Poor	REMOVE	12	10	3	6	Acacia auriculiformis	Earleaf acacia	128
1923	961.63	50% Fair	REMOVE	35	33	8	16	Swietenia mahagoni	Mahogany	129
	Invasive	20% Poor	REMOVE	20	20	3	6	Acacia auriculiformis	Earleaf acacia	130
	78.50	50% Fair	REMOVE	10	10	3.5	7	Coccoloba diversifolia	Pigeon plum	131
	Invasive	30% Poor	REMOVE	15	25	4.5	9	Acacia auriculiformis	Earleaf acacia	132
	78.50	50% Fair	REMOVE	10	10	4.25	8.5	Coccoloba diversifolia	Pigeon plum	133
	Invasive	30% Poor	REMOVE	15	28	5.75	11.5	Acacia auriculiformis	Earleaf acacia	134
220	113.04	50% Fair 50% Fair	REMOVE	12 15	14 6	2.75	5.5 16	Tabebuia rosea Sabal palmetto	Pink tabebuia Sabal palm	135
35: 1	176.63 706.50	30% Poor	REMOVE REMOVE	30	25	10.25	20.5	Sapai paimetto Swietenia mahagoni	Mahogany	136 137
l	314.00	50% Fair	REMOVE	20	20	9.75	19.5	Coccoloba uvifera	Sea grape	138
98	490.63	45% Fair	REMOVE	25	12	7.25	14.5	Swietenia mahagoni	Mahogany	139
	314.00	30% Poor	REMOVE	20	8	6.25	12.5	Swietenia mahagoni	Mahogany	140
	Invasive	30% Poor	REMOVE	6	12	3	6	Acacia auriculiformis	Earleaf acacia	141
56	28.26	10% Poor	REMOVE	6	8	1.5	3	Tabebuia rosea	Pink tabebuia	142
30	153.86	70% Good	REMOVE	14	12	6.5	13	Sabal palmetto	Sabal palm	143
35	176.63	30% Poor	REMOVE	15	18	3.75	7.5	Swietenia mahagoni	Mahogany	144
35	176.63	50% Fair	REMOVE	15	15	11	22	Coccoloba uvifera	Sea grape	145
35	176.63	50% Fair 25% Poor	REMOVE	15 30	15 25	8.5 9.25	17 18.5	Coccoloba uvifera	Sea grape	146
1	706.50 78.50	25% Poor 50% Fair	REMOVE REMOVE	10	10	9.25	36	Swietenia mahagoni Coccoloba uvifera	Mahogany Sea grape	147 148
100	50.24	60% Fair	REMOVE	8	6	3.5	7	Coccoloba uvifera	Sea grape	148
100	314.00	30% Poor	REMOVE	20	18	6.75	13.5	Swietenia mahagoni	Mahogany	150
35	176.63	50% Fair	REMOVE	15	18	5.25	10.5	Swietenia mahagoni	Mahogany	151
	78.50	60% Fair	REMOVE	10	30	6.5	13	Washingtonia robusta	Washingtonia palm	152
	78.50	50% Fair	REMOVE	10	15	3.75	7.5	Tabebuia rosea	Pink tabebuia	153
	78.50	50% Fair	REMOVE	10	12	4	8	Tabebuia rosea	Pink tabebuia	154
1923	961.63	50% Fair	REMOVE	35	30	8.5	17	Swietenia mahagoni	Mahogany	155
226	113.04	50% Fair	REMOVE	12	15	4.5	9	Tabebuia rosea	Pink tabebuia	156
4749	2,374.63	40% Poor	REMOVE	55	35	14	28	Swietenia mahagoni	Mahagany	157
192	961.63	30% Poor	REMOVE	35 20	30	9.5	19	Swietenia mahagoni	Mahogany	158
50:	314.00	50% Fair 60% Fair	REMOVE REMOVE	20 18	25 14	6.25 4.25	12.5 8.5	Swietenia mahagoni Noronhia emarginata	Mahogany Madagascar olive	159 160
508 228	254.34 113.04	40% Poor	REMOVE	12	18	9.25	18.5	Coccoloba diversifolia	Pigeon plum	160 161
3	1,962.50	40% Poor	REMOVE	50	35	13	26	Swietenia mahagoni	Mahogany	162
35	176.63	50% Fair	REMOVE	15	14	5	10	Noronhia emarginata	Madagascar olive	163
	0.00	0% Dead	REMOVE	na	12	3	6	Noronhia emarginata	Madagascar olive	164
43,820		Total Canopy Repl								

ISLE OF DREAMS

ARQUITECTONICA



PLANNING LANDSCAPE ARCHITECTURE URBAN DESIGN

1512 E. BROWARD BOULEVARD, SUITE 110 FORT LAUDERDALE, FLORIDA 33301 USA TEL: 954.524.3330

Consultants:

Issued for Rev Date

05/30/2025 Approved / Checked By



SHORELINE SUBMITTAL

TREE MITIGATION SCHEDULE

L1-5-01

GENERAL NOTES:


- 1. LOCATIONS, ELEVATIONS AND DIMENSIONS OF EXISTING UTILITIES, STRUCTURES AND OTHER FEATURES WERE PROVIDED TO EDSA AND ARE SHOWN ACCORDING TO THE BEST INFORMATION AVAILABLE AT THE TIME OF THE PREPARATION OF THESE CONTRACT DOCUMENTS. EDSA AND ANY OF THEIR CONSULTANTS SHALL NOT BE HELD RESPONSIBLE FOR THE ACCURACY AND/OR COMPLETENESS OF THAT INFORMATION SHOWN HEREIN OR ANY ERRORS OR OMISSIONS RESULTING FROM SUCH.
- 2. THE CONTRACTOR SHALL FIELD LOCATE, VERIFY AND FURTHER IDENTIFY THE LOCATIONS, ELEVATIONS AND DIMENSIONS OF ALL EXISTING UTILITIES, STRUCTURES AND OTHER FEATURES ABOVE AND BELOW GRADE AFFECTING ANY COMPONENT OF THE WORK CONTAINED IN THE CONTRACT DOCUMENTS PRIOR TO THE START OF ANY PHASE OF CONSTRUCTION. DISCREPANCIES, CONFLICTS, OR POTENTIAL DEVIATIONS SHALL BE BROUGHT TO THE ATTENTION OF THE OWNERS REPRESENTATIVE IN WRITING WITHIN 48 HOURS OF DISCOVERY. NO CLAIM FOR EXPENSES INCURRED BY THE CONTRACTOR DUE TO SUCH CONDITIONS WILL BE AWARDED IF WRITTEN NOTIFICATION IS NOT PROVIDED PRIOR TO THE START OF ANY PHASE OF CONSTRUCTION.
- 3. DO NOT TAKE ADVANTAGE OF ANY APPARENT ERROR OR OMISSION DISCOVERED IN THE CONTRACT DOCUMENTS. IMMEDIATELY NOTIFY THE OWNERS REPRESENTATIVE OF ANY SUCH DISCOVERY. THE OWNERS REPRESENTATIVE WILL PROVIDE DIRECTION REGARDING ANY CORRECTION OR INTERPRETATION NECESSARY TO REFLECT THE DESIGN INTENT OF THE CONTRACT DOCUMENTS.
- 4. ALL EXISTING SITE FACILITIES TO REMAIN SHALL BE PROTECTED FROM ANY DAMAGE THROUGHOUT ALL CONSTRUCTION PHASES. THE CONTRACTOR SHALL REPAIR ANY DAMAGE TO SAID FACILITIES THAT OCCURS DUE TO WORK PREFORMED BY THE CONTRACTOR CALLED FOR IN THE CONTRACT DOCUMENTS.
- 5. ALL WORK SHALL COMPLY WITH THE CODES, STANDARDS, REGULATIONS, REQUIREMENTS AND ORDINANCES OF ANY GOVERNMENTAL AGENCY HAVING JURISDICTION OVER THE WORK. THE CONTRACTOR SHALL OBTAIN ALL NECESSARY PERMITS PRIOR TO THE START OF CONSTRUCTION AND SCHEDULE ALL INSPECTIONS AND TESTING ACCORDING TO THE REQUIREMENTS OF SAID AGENCIES AND THE CONTRACT DOCUMENTS.
- 6. THE CONTRACTOR SHALL COORDINATE ALL WORK WITH RELATED CONTRACTORS AND WITH THE GENERAL CONSTRUCTION OF THE PROJECT SO AS NOT TO IMPEDE THE PROGRESS OF THE WORK OF OTHERS.
- 7. THE CONTRACTOR SHALL BE RESPONSIBLE FOR THE SAFETY OF THE PUBLIC AND ALL PERSONNEL ASSOCIATED WITH THE CONSTRUCTION OF THIS PROJECT. ALL SAFETY REGULATIONS REQUIRED BY APPLICABLE CODES, REGULATIONS AND RECOGNIZED LOCAL PRACTICES SHALL BE ENFORCED DURING THE CONSTRUCTION AND/OR MAINTENANCE OF THIS PROJECT.
- 8. THE OWNERS REPRESENTATIVE SHALL HAVE THE RIGHT AT ANY STAGE OF THE OPERATION TO REJECT ALL WORK OR MATERIALS WHICH IN THEIR OPINION DO NOT MEET THE WITH THE REQUIREMENTS OF THE CONTRACT DOCUMENTS.
- 9. ALL REQUIRED SEDIMENT AND EROSION CONTROL MEASURES INSTALLED AS PART OF THIS PROJECT SHALL REMAIN IN PLACE AND SHALL BE MAINTAINED IN GOOD CONDITION UNTIL CONSTRUCTION IS COMPLETE. SEE THE CIVIL ENGINEERING CONTRACT DOCUMENTS FOR ADDITIONAL REQUIREMENTS.
- 10. THE CONTRACTOR SHALL REFER TO THE LANDSCAPE NOTES, SPECIFICATIONS AND THE CONTRACT DOCUMENTS PREPARED BY BUT NOT LIMITED TO ARCHITECTURAL, MEP, IRRIGATION, STRUCTURAL AND CIVIL ENGINEERING CONSULTANTS FOR ADDITIONAL REQUIREMENTS.

HARDSCAPE NOTES:(cont.)

PURCHASE/INSTALLATION.

- 17. HARDSCAPE ON-STRUCTURE: SITE HARDSCAPE ELEMENTS FOR ALL PODIUM, ROOF LEVEL AND BUILDING RELATED SURFACES ARE SHOWN FOR MATERIAL RELATIONSHIP ONLY. REFER TO CONTRACT DOCUMENTS PREPARED BY BUT NOT LIMITED TO ARCHITECTURAL. MEP AND STRUCTURAL ENGINEERING CONSULTANTS FOR ACTUAL CONSTRUCTION DOCUMENTATION FOR ALL ANCHORS, REINFORCING, WATERPROOFING, DRAINAGE FIXTURES, MATERIAL ATTACHMENTS, SETTING METHODS AND SLAB PENETRATIONS FOR PAVING, IRRIGATION, DRAINAGE AND ELECTRICAL FIXTURES.
- 18. WATER FEATURES: SITE HARDSCAPE ELEMENTS SHOWN FOR FOUNTAINS, POOLS, SPA WATERFALLS AND OTHER WATER FEATURES ARE SHOWN FOR MATERIAL RELATIONSHIP ONLY. REFER TO CONTRACT DOCUMENTS PREPARED BY BUT NOT LIMITED TO ARCHITECTURAL, MEP, STRUCTURAL AND FOUNTAIN/POOL ENGINEERS FOR ACTUAL CONSTRUCTION DOCUMENTATION.
- 19. LIGHT FIXTURES: LIGHT FIXTURES ARE SHOWN FOR MATERIAL RELATIONSHIP AND ORIENTATION WITH HARDSCAPE/LANDSCAPE ELEMENTS ONLY. REFER TO CONTRACT DOCUMENTS PREPARED BY BUT NOT LIMITED TO ELECTRICAL ENGINEER FOR ACTUAL CONSTRUCTION DOCUMENTATION.

STANDARD DRAWING SYMBOLS:

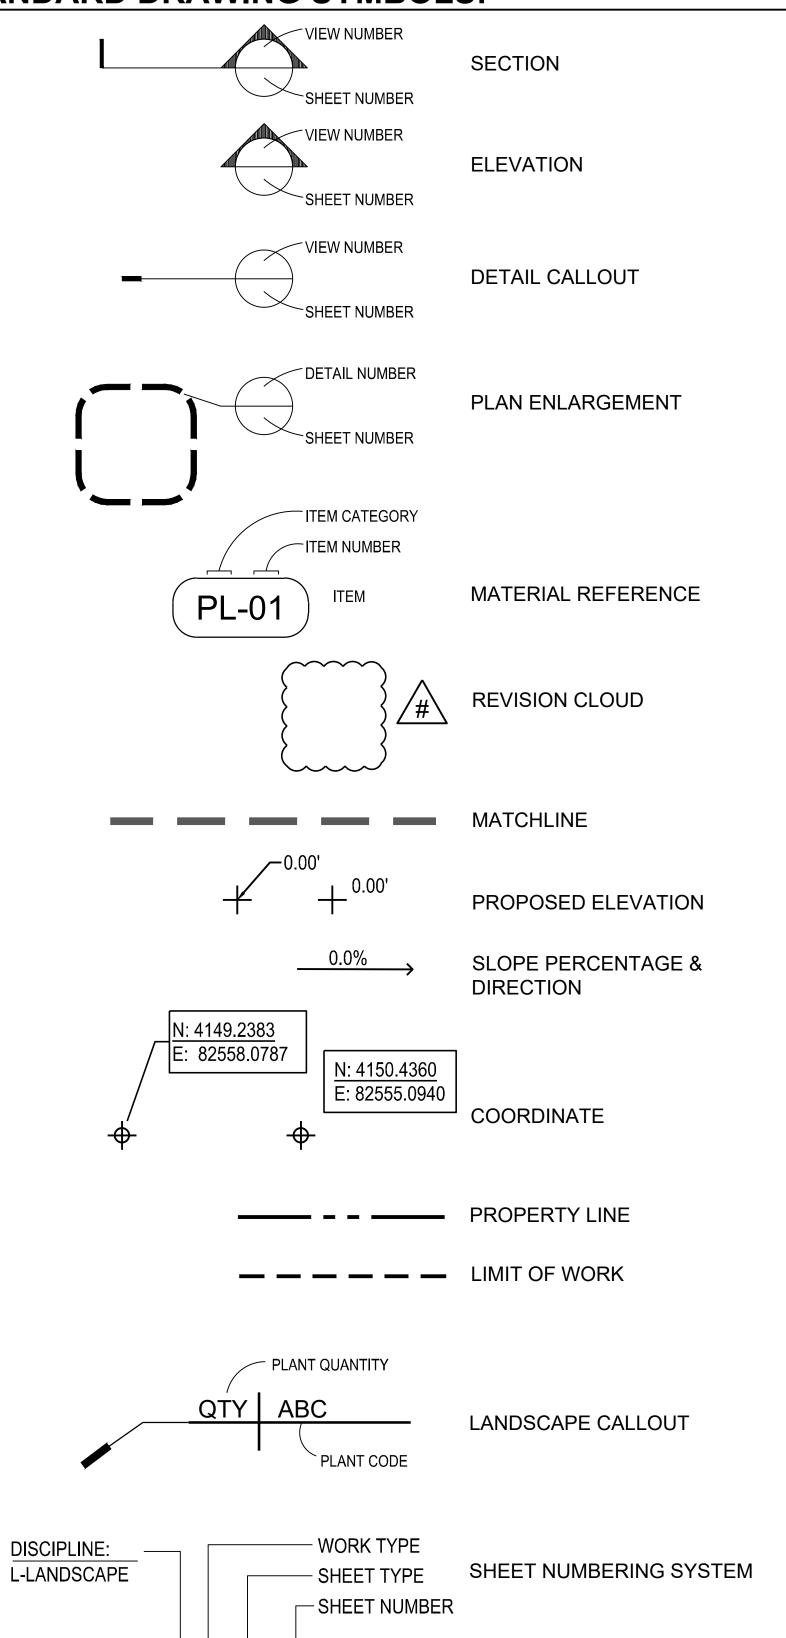

STANDARD ABBREVIATIONS:

LX-X-XX


ADA	AMERICANS WITH	ESMT	EASEMENT	NTS	NOT TO SCALE
	DISABILITIES ACT	EW	EACH WAY	OC	ON CENTER
B&B	BALLED AND BURLAPPED	FFE	FINISHED FLOOR ELEVATION	PL	PROPERTY LINE
BFP	BACKFLOW PREVENTER	GALV	GALVINIZED	PT	PAINT
CIP	CAST-IN-PLACE	GA	GUAGE	R	RADIUS
CJ	CONSTRUCTION JOINT	HP	HIGH POINT	REBAR	REINFORCING STEEL BARS
CL	CENTER LINE	HWL	HIGH WATER LINE	RIM	RIM ELEVATION
CMU	CONCRETE MASONRY UNIT	INV	INVERT ELEVATION	ROW	RIGHT-OF-WAY
COORD	COORDINATE	LF	LINEAR FEET (FOOT)	SIM	SIMILAR
CONT	CONTINUOUS	LP	LOW POINT	SST	STAINLESS STEEL
DEMO	DEMOLITION	MAX	MAXIMUM	TOC	TOP OF COLUMN
DIA	DIAMETER	MHW	MEAN HIGH WATER	T.W.	TOP OF WALL
DI	DRAIN INLET	MIN.	MINIMUM	T.S.	TOP OF STEP
EA	EACH	NWL	NATURAL WATER LINE	T.C.	TOP OF CURB
EJ	EXPANSION JOINT	NIC	NOT IN CONTRACT	WWF	WELDED WIRE FABRIC
EQ	EQUAL			YD	YARD DRA I N


ORIGINAL TITLE BLOCK DRAWN AT 24"x36" (Arch D)

ISLE OF DREAMS

Project Name


ARQUITECTONICA

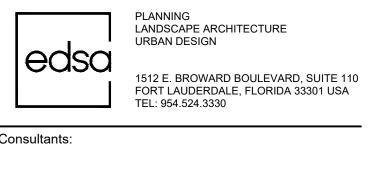

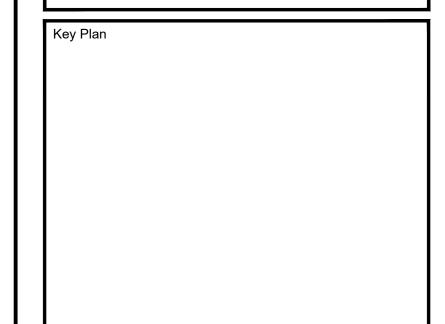

	Rev	Date	Issued for

Date	05/30/2025
Designed By	MH, LDC
Drawn By	LDC
Approved / Checked By	JS
Project Number	SE240000

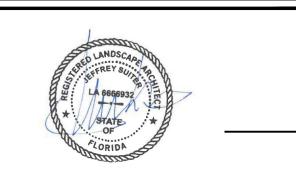

oject Phase
SHORELINE SUBMITTAL

Sheet Title

HARDSCAPE NOTES

Sheet Number

L3-0-01

HARDSCAPE NOTES:

- 1. PRIOR TO THE COMMENCEMENT OF HARDSCAPE CONSTRUCTION, THE CONTRACTOR SHALL VERIFY THE CONDITION AND COMPLETENESS OF ALL WORK PERFORMED BY OTHER CONTRACTORS WORKING ON THIS PROJECT IN RELATION TO THE WORK RESPONSIBILITIES DEPICTED IN THE CONTRACT DOCUMENTS. THE CONTRACTOR SHALL NOTIFY THE OWNERS REPRESENTATIVE IN WRITING OF ANY POTENTIAL DEVIATIONS WITHIN 48 HRS OF DISCOVERY. NO CLAIM FOR EXPENSES INCURRED BY THE CONTRACTOR DUE TO SUCH CONDITIONS WILL BE AWARDED IF WRITTEN NOTIFICATION IS NOT PROVIDED PRIOR TO THE START OF HARDSCAPE CONSTRUCTION.
- 2. THE CONTRACTOR SHALL SURVEY, LAYOUT AND STAKE THE LOCATION OF ALL FOOTINGS, PIERS, WALLS, COLUMNS AND PAVEMENT FOR REVIEW BY THE OWNERS REPRESENTATIVE PRIOR TO COMMENCEMENT OF HARDSCAPE CONSTRUCTION. THE CONTRACTOR SHALL ASSUME ALL RESPONSIBILITY FOR ANY RECONSTRUCTION OF HARDSCAPE CONSTRUCTION RESULTING FROM UNAUTHORIZED CONSTRUCTION.
- 3. THE CONTRACTOR SHALL PROVIDE SHOP DRAWINGS AND/OR FIELD MOCKUPS FOR ALL ITEMS LISTED ON THE FINISH SCHEDULE UNLESS SPECIFICALLY NOTED OTHERWISE. MOCKUPS SHALL BE SET UP IN A SECURED LOCATION ON THE SITE FOR REFERENCE AS DIRECTED BY THE OWNERS REPRESENTATIVE. MOCKUPS WILL REMAIN ON SITE UNTIL THE COMPLETION OF HARDSCAPE CONSTRUCTION.
- 4. ANY REFERENCE IN THE HARDSCAPE CONSTRUCTION DOCUMENTS TO BRANDED PRODUCTS, PROCEDURES OR PATENTED PROCESSES ARE ASSUMED TO CARRY AN IMPLIED STATEMENT OF "OR APPROVED EQUAL" UNLESS SPECIFICALLY NOTED OTHERWISE WITH "NO SUBSTITUTIONS PERMITTED"
- 5. THE CONTRACTOR SHALL BE SOLELY RESPONSIBLE FOR ALL CONSTRUCTION MEANS, METHODS, TECHNIQUES, SEQUENCES AND PROCEDURES REQUIRED FOR THE SAFE EXECUTION AND COMPLETION OF THE WORK.
- 6. THE CONTRACTOR SHALL VERIFY ALL MEASUREMENTS AT THIS SITE AND BE RESPONSIBLE FOR THE ACCURACY AND CORRECTNESS OF SAME.
- 7. THE CONTRACTOR SHALL EMPLOY AS REQUIRED BY THE CONSTRUCTION DOCUMENTS AND/OR GOVERNING AUTHORITIES, A TESTING LABORATORY APPROVED BY THE OWNERS REPRESENTATIVE TO CONDUCT ALL TESTS NECESSARY TO ENSURE COMPLIANCE WITH THE CONTRACT DOCUMENTS, APPLICABLE STANDARDS AND CODES.
- 8. WRITTEN DIMENSIONS, COORDINATES AND/OR ELECTRONIC FILES PREVAIL OVER SCALED DIMENSIONS. DO NOT SCALE FROM THE CONTRACT DOCUMENTS.
- 9. REFER TO ARCHITECTURAL PLANS FOR ALL BUILDING DIMENSIONS.
- 10. REFER TO CIVIL PLANS FOR OVERALL SITE LAYOUT/DIMENSIONS.
- 11. HARDSCAPE DIMENSIONS ARE FROM THE FACE AND/OR CENTERLINE OF THE OBJECT AT 90 DEGREE ANGLES UNLESS NOTED OTHERWISE. ALL RADII AND CURVES ARE TO HAVE SMOOTH AND CONTINUOUS TRANSITIONS WITHOUT ABRUPT CHANGES OR BENDS
- 12. PAVER DIMENSIONS ARE NOMINAL. VERIFY ACTUAL PAVER DIMENSIONS PRIOR TO LAYOUT OF PAVER FIELDS.
- 13. ALL REFERENCES TO "GRAY CONCRETE" SHALL MEAN NATURAL CONCRETE WITH NO COLOR ADDITIVE.
- 14. INFORMATION ON STRUCTURAL REINFORCEMENT, ANCHORS, FASTENERS, FOUNDATIONS OR OTHER STRUCTURAL ELEMENTS SHOWN ON THE SITE HARDSCAPE DOCUMENTS RELATED TO WALLS, SLABS, STRUCTURES AND ALL CAST IN PLACE CONCRETE IS SHOWN FOR MATERIAL RELATIONSHIPS ONLY. REFER TO CONTRACT DOCUMENTS PREPARED BY BUT NOT LIMITED TO ARCHITECTURAL, MEP, STRUCTURAL AND CIVIL ENGINEERING CONSULTANTS FOR ACTUAL CONSTRUCTION DOCUMENTATION.
- 15. CROSS SLOPE ON HARDSCAPE PAVEMENT SHALL NOT EXCEED 2%. RUNNING SLOPE SHALL NOT EXCEED 5% UNLESS NOTED OTHERWISE, SEE LANDSCAPE GRADING FOR ADDITIONAL REQUIREMENTS.
- 16. SITE FURNISHINGS SHALL BE INSTALLED AS DETAILED IN THE CONSTRUCTION DOCUMENTS UNLESS NOTED OTHERWISE. CONTRACTOR SHALL BE RESPONSIBLE FOR COORDINATING ANCHORING DETAILS WITH THE ITEM'S MANUFACTURER PRIOR TO

FINE GRADING NOTES:

- 1. CIVIL AND LANDSCAPE GRADES ARE COMPLEMENTARY. REFER TO THE CIVIL ENGINEERING CONTRACT DOCUMENTS FOR ROUGH GRADING OF THE SITE, FINISH GRADES FOR ALL VEHICULAR PAVEMENT, BUILDINGS, DRAINAGE AND UTILITY STRUCTURES.
- 2. PRIOR TO INITIATING FINE GRADING THE CONTRACTOR SHALL INSPECT THE SITE TO CONFIRM THAT ROUGH GRADING AND DRAINAGE STRUCTURES HAVE BEEN COMPLETED IN ACCORDANCE WITH THE CIVIL ENGINEERING CONTRACT DOCUMENTS. THE CONTRACTOR SHALL SUBMIT IN WRITING TO THE OWNERS REPRESENTATIVE ANY DISCREPANCIES BETWEEN THE CONTRACT DOCUMENTS AND FIELD CONDITIONS. THE OWNERS REPRESENTATIVE WILL PROVIDE DIRECTION REGARDING ANY CORRECTION OR INTERPRETATION NECESSARY TO RESOLVE ANY DISCREPANCIES.
- 3. NUMEROUS UNDERGROUND UTILITIES, CONDUITS, SLEEVES AND UTILITY STRUCTURES ABOVE AND BELOW GRADE HAVE BEEN PREVIOUSLY INSTALLED. THE CONTRACTOR SHALL CONDUCT FINE GRADING TO AVOID DAMAGE TO THESE ELEMENTS.
- 4. ALL PEDESTRIAN PAVEMENT AND LANDSCAPE AREAS SHALL BE GRADED TO POSITIVELY DRAIN AWAY FROM VERTICAL ELEMENTS INCLUDING BUT NOT LIMITED TO BUILDINGS, WALLS AND COLUMNS TOWARD AND INTO DRAINAGE STRUCTURES. LANDSCAPE AREAS SHALL BE SMOOTH AND EVEN IN TRANSITION AND VOID OF WATER HOLDING DEPRESSIONS.
- 5. PROPOSED SPOT ELEVATIONS REPRESENT FINISHED PAVEMENT OR GROUND SURFACE GRADES UNLESS OTHERWISE NOTED. MAKE ALLOWANCES FOR PAVEMENT THICKNESS AND THE DEPTH OF PREPARED PLANTING SOIL WHERE APPLICABLE.
- 6. THE CONTRACTOR SHALL NOT SUBSTANTIALLY VARY FINE GRADING FROM THE GRADING PLAN WITHOUT APPROVAL FROM THE OWNERS REPRESENTATIVE. THE OWNERS REPRESENTATIVE MAY ADJUST FINE GRADING SHOWN ON THE PLANS TO ACCOMMODATE UNFORESEEN FIELD CONDITIONS OR TO ACCOMPLISH DESIGN INTENT.
- 7. PROTECT SITE FEATURES TO REMAIN, INCLUDING BUT NOT LIMITED TO BENCH MARKS, SURVEY CONTROL POINTS, EXISTING STRUCTURES AND PAVING FROM DAMAGE BY GRADING EQUIPMENT.
- 8. MATCH PROPOSED PAVEMENT GRADES WITH EXISTING CONDITIONS TO REMAIN TO PROVIDE FLUSH INTERFACES WITH ABUTTING SURFACES.
- 9. GRADES FOR SOD AREAS SHALL BE HELD ONE INCH (1") BELOW ADJACENT PAVEMENT GRADES TO ALLOW FOR INSTALLATION OF SOD.
- 10. GRADES FOR PLANTING AREAS SHALL BE HELD TWO INCHES (2") BELOW ADJACENT PAVEMENT TO ALLOW FOR THE INSTALLATION OF PREPARED PLANTING SOIL, MULCH AND PLANT MATERIAL.11. FILL REQUIRED TO BRING THE SITE TO THE REQUIRED LINES AND FINISHED GRADES CONTAINED IN THE CONTRACT DOCUMENTS


12. FILL SHALL BE COMPACTED AS FOLLOWS:


A. UNDER PEDESTRIAN PAVEMENT: AS RECOMMENDED BY CIVIL/GEOTECHINCAL ENGINEER.


SHALL BE AS RECOMMENDED BY THE GEOTECHNICAL ENGINEER.

- B. LANDSCAPE AREAS: COMPACT TOP TWELVE INCHES (12") BELOW SUBGRADE AND EACH LAYER OF BACKFILL OR FILL MATERIAL TO 80% MAXIMUM DRY DENSITY ACCORDING TO ASTM D698.
- 13. CONTOURS FOR LANDSCAPE BERMS, MOUNDS AND SWALES SHALL BE SMOOTH CONTINUOUS ARCS VOID OF SURFACE IRREGULARITIES AND SHALL BLEND INTO SURROUNDING TERRAIN IN A NATURAL MANOR.
- 14. ALL LANDSCAPE AREAS SHALL BE DRAGGED WITH A DRAG MAT TO BLEND IN SMALL IMPERFECTIONS AND ROUND OFF AND SHARP EDGES.
- 15. FINE GRADE TOLERANCES FOR LANDSCAPE AREAS...PLUS OR MINUS (+/-) 0.04 FOOT (').

 16. FINE GRADE TOLERANCES FOR HARDSCAPE AREAS...PLUS OR MINUS (+/-) 0.02 FOOT(').
- 17. THE CONTRACTOR SHALL BE RESPONSIBLE FOR STABILIZING GRADES AND TO REPAIR AND CLEAN UP AREAS WHERE SETTLEMENT, WASHOUTS, EROSION OR OTHER GRADE CHANGES OCCUR UNTIL FINAL ACCEPTANCE.

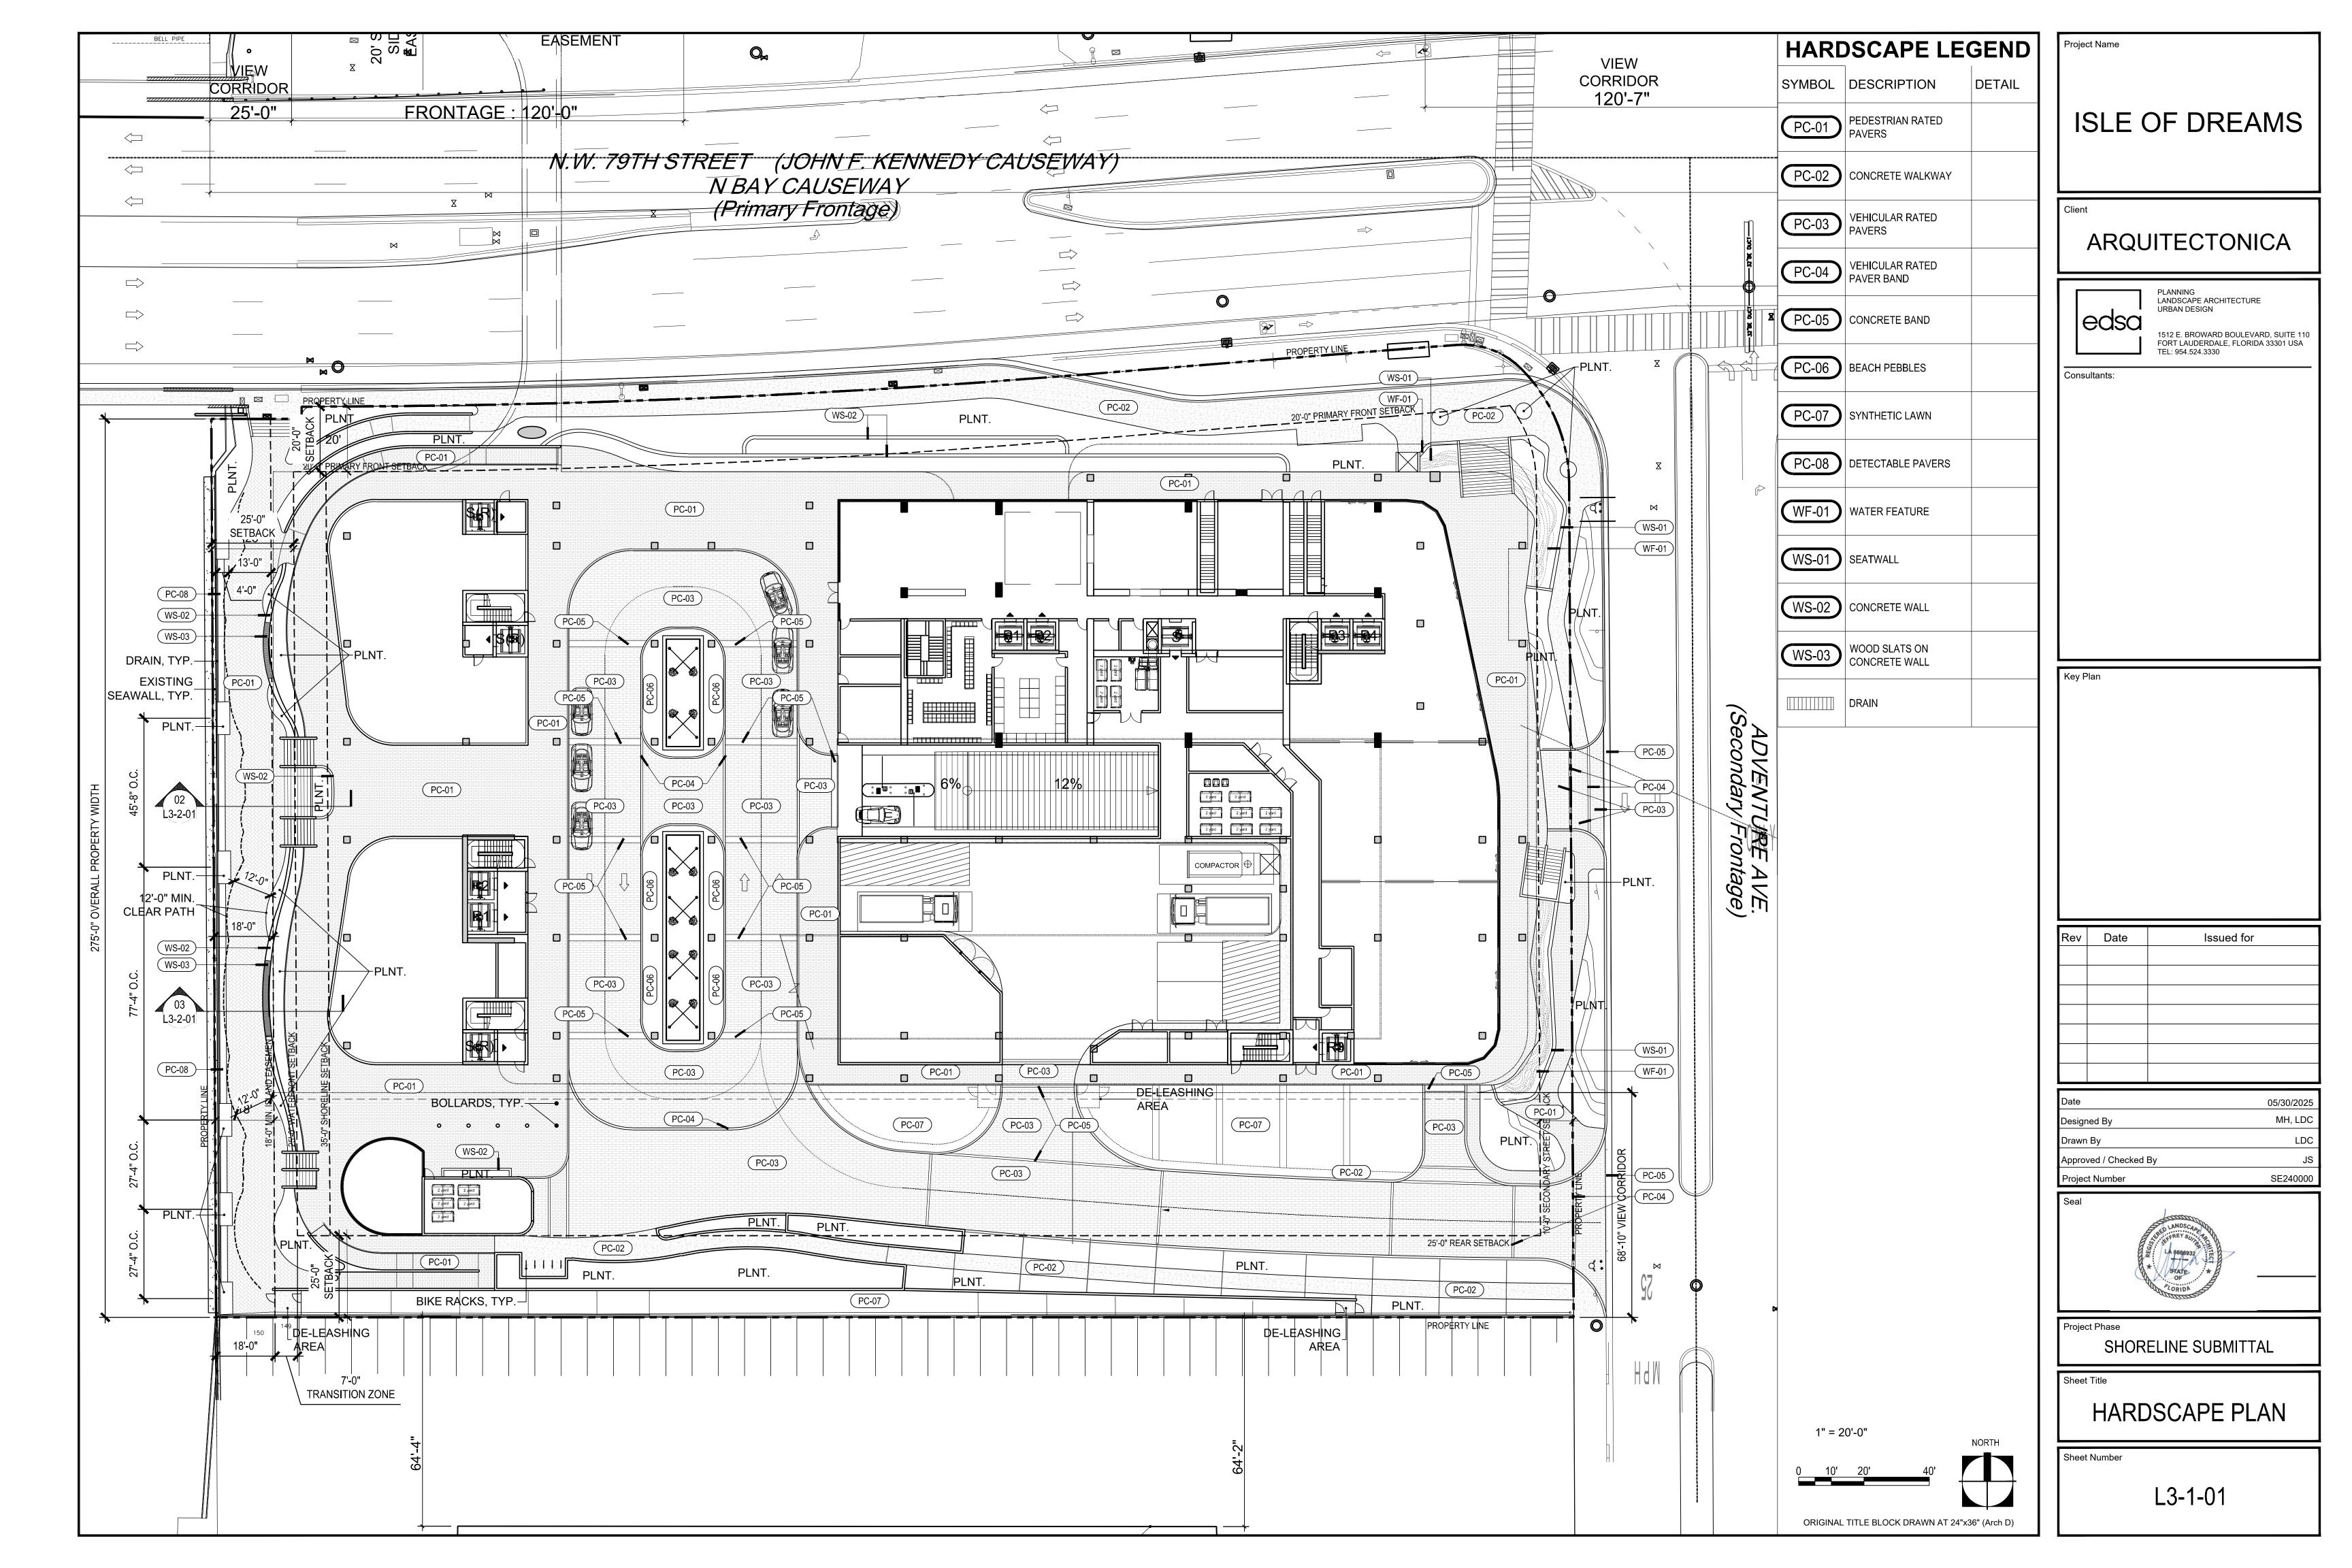

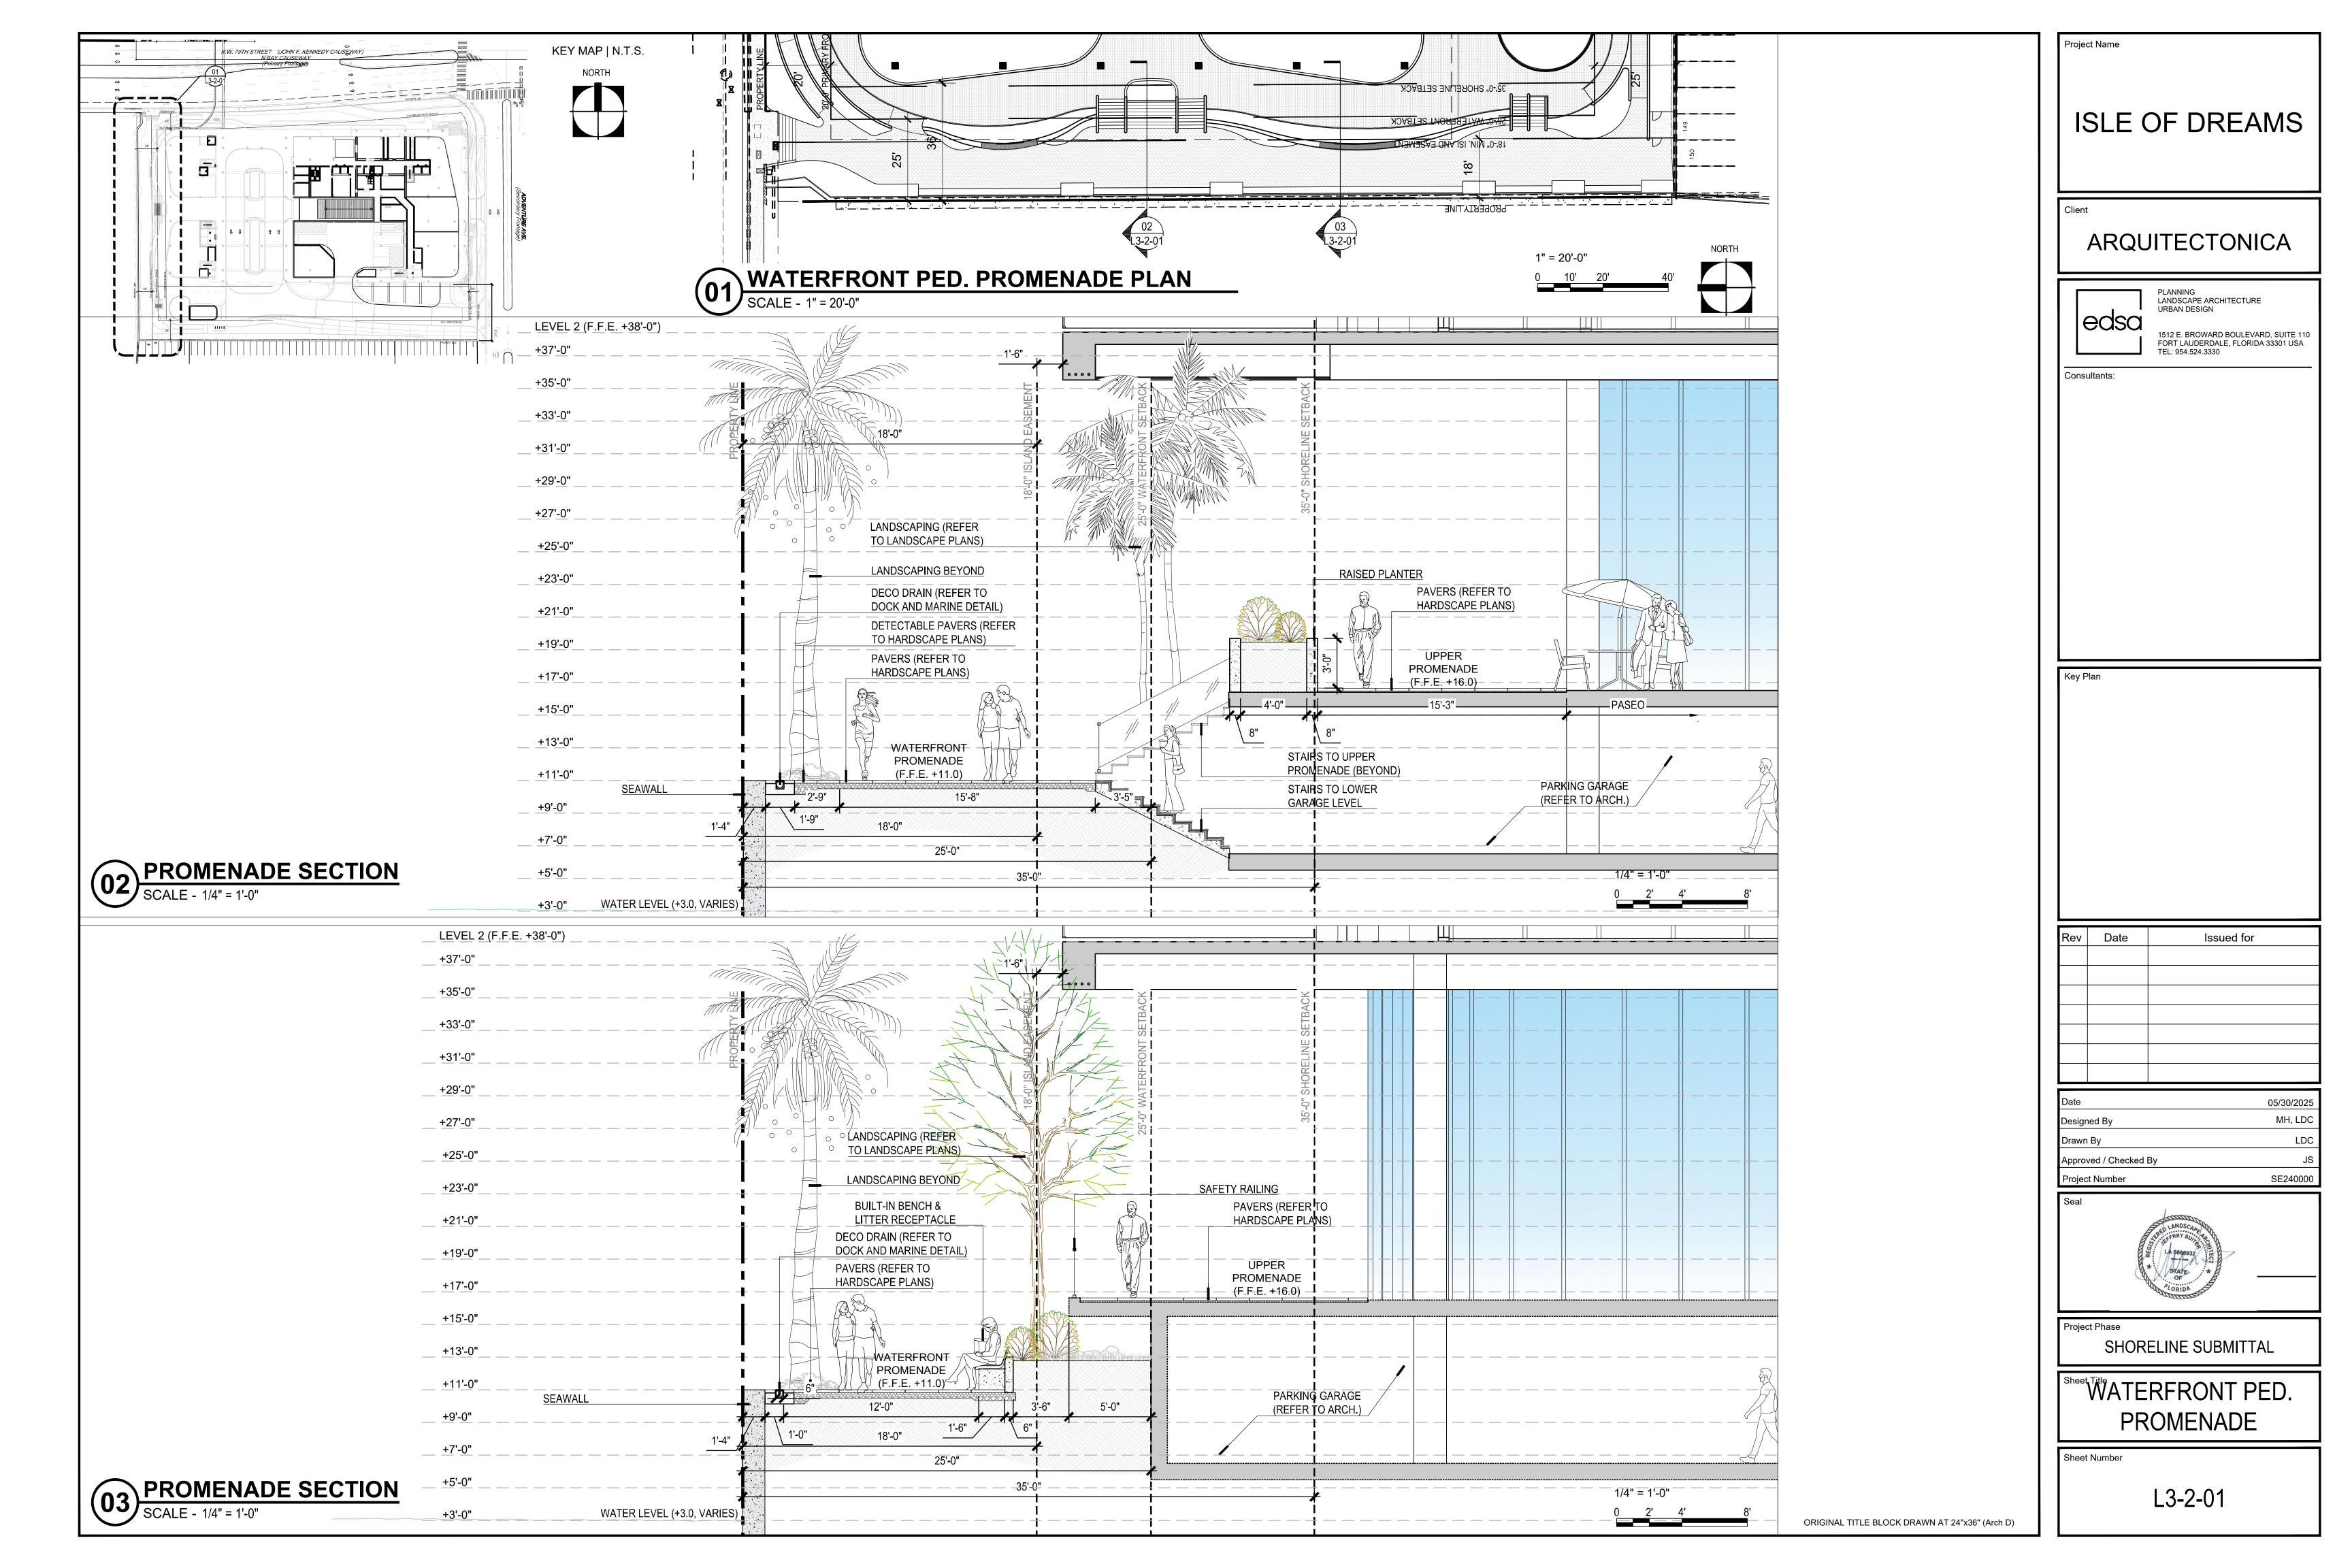

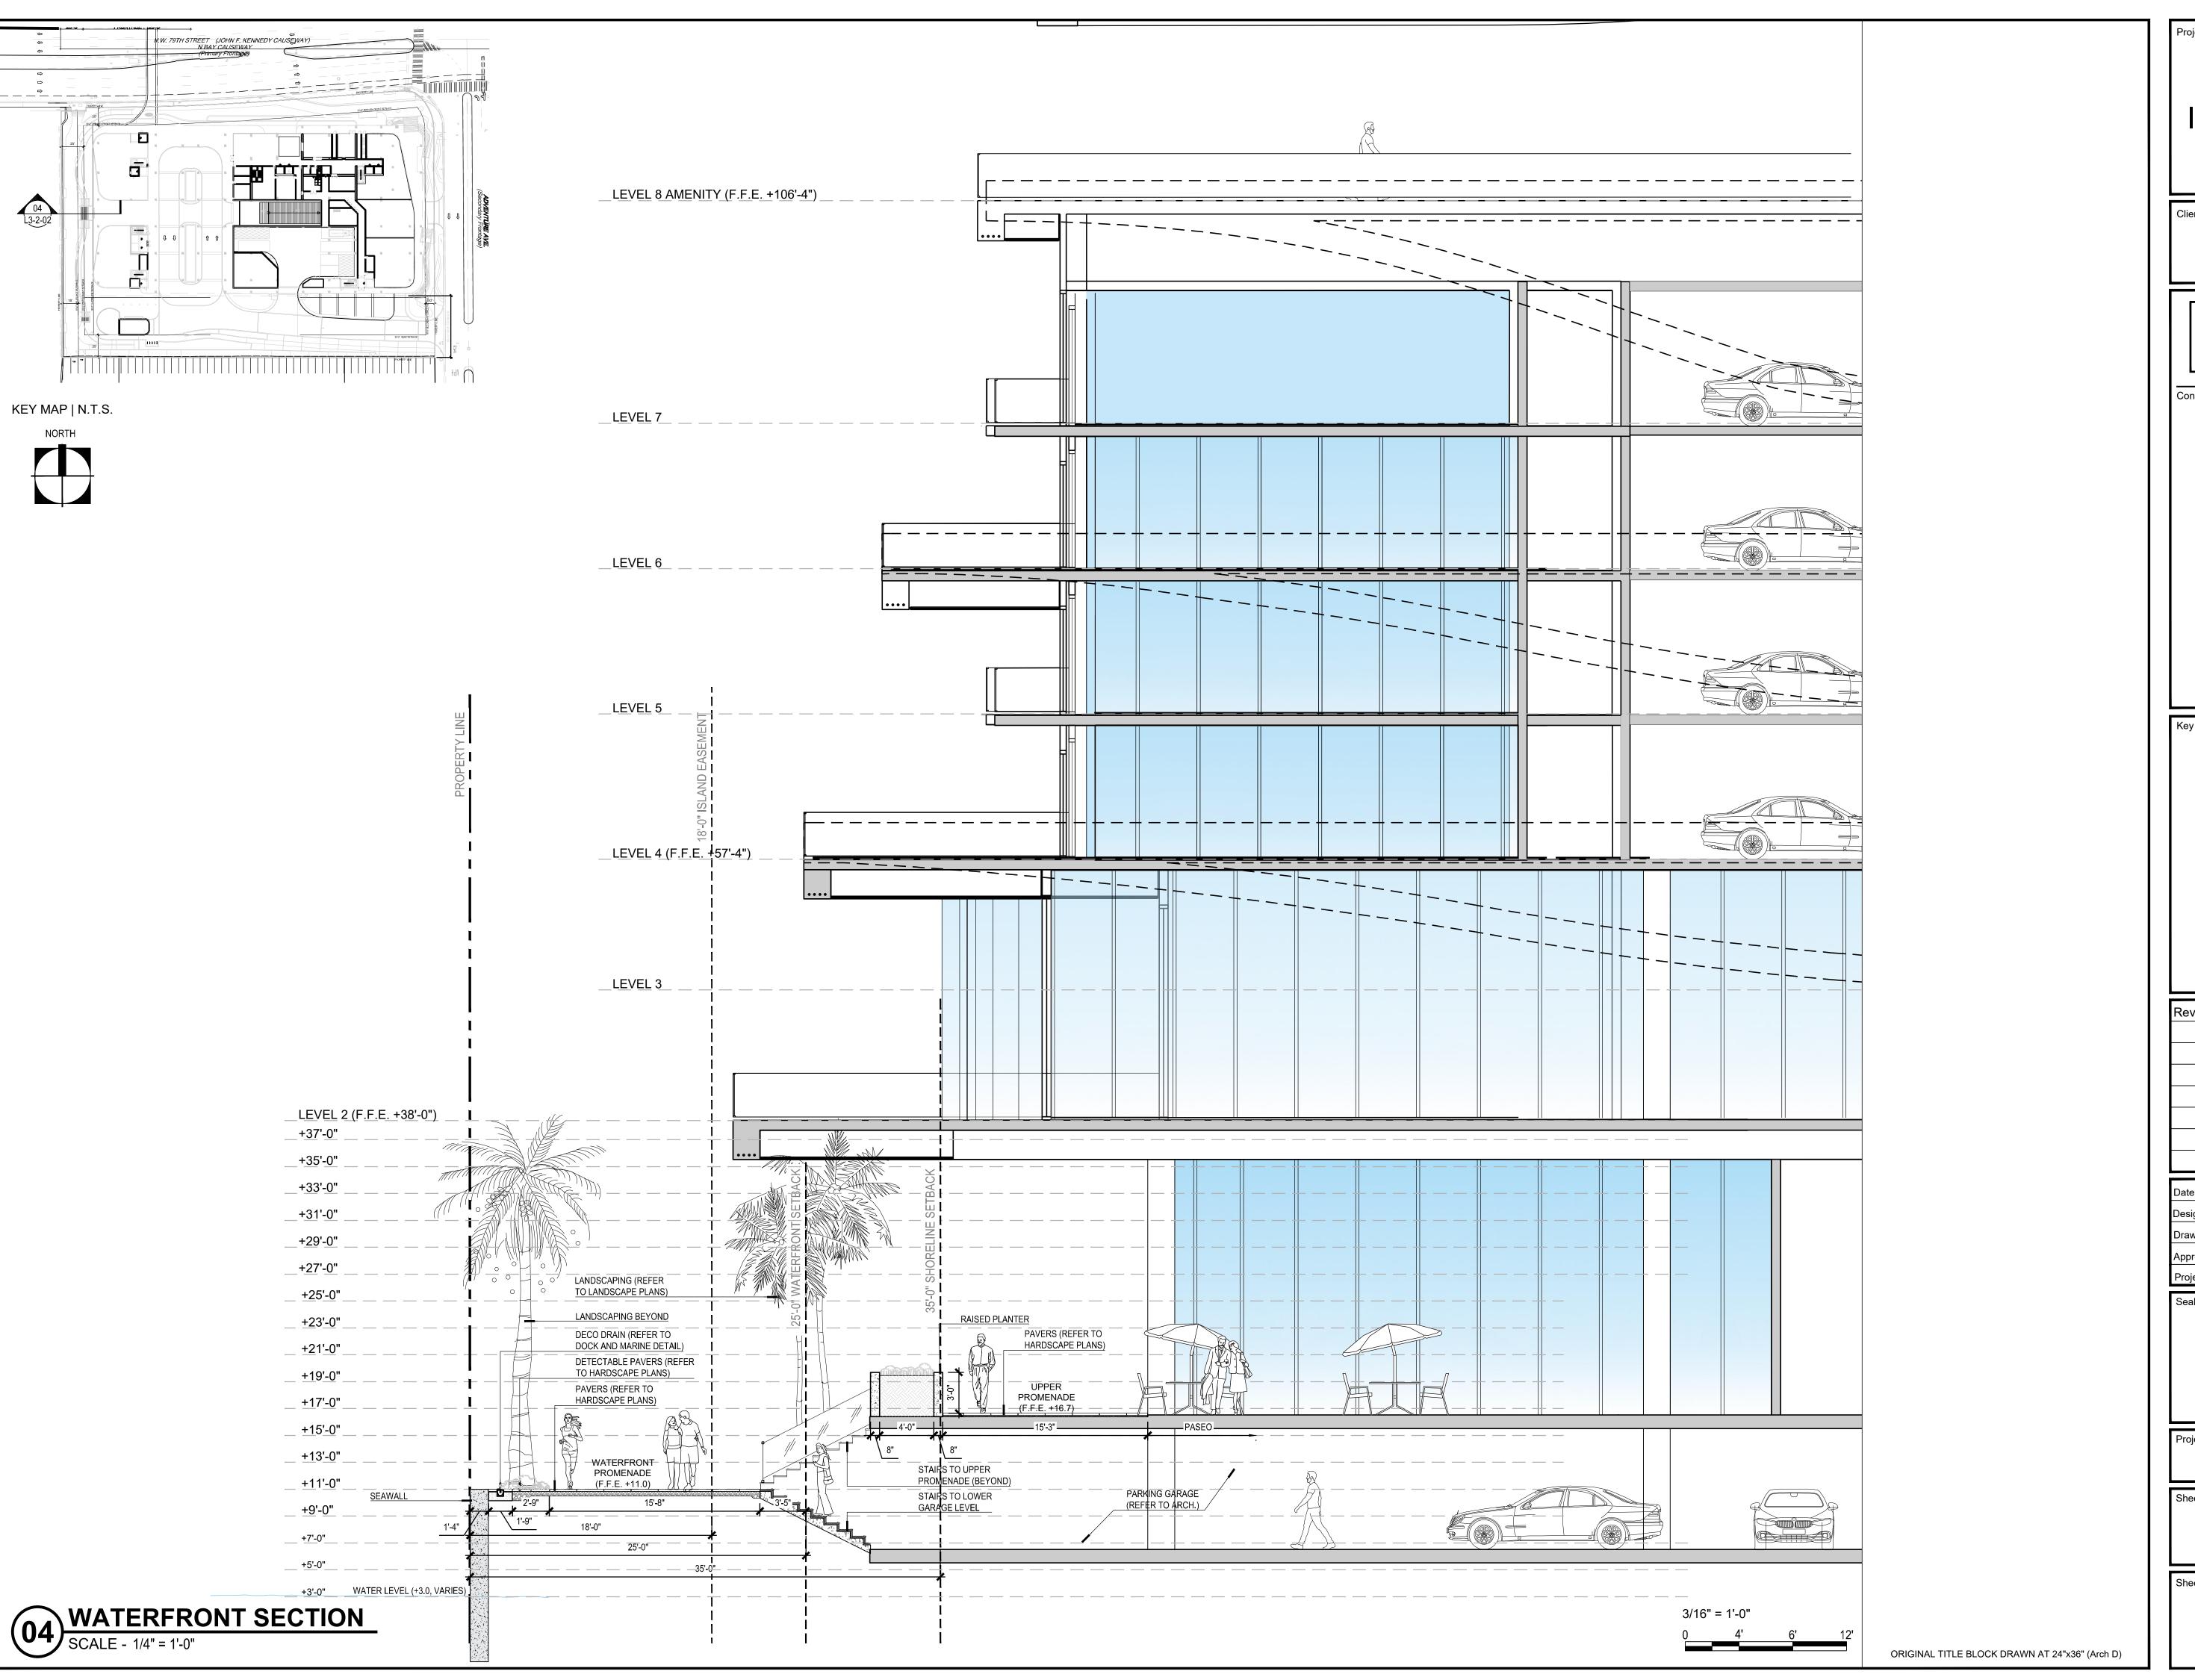

ISLE OF DREAMS

ARQUITECTONICA



PLANNING LANDSCAPE ARCHITECTURE URBAN DESIGN

1512 E. BROWARD BOULEVARD, SUITE 110 FORT LAUDERDALE, FLORIDA 33301 USA TEL: 954.524.3330

Consultants:

Issued for

Date	05/30/2025		
Designed By	MH, LDC		
Drawn By	LDC		
Approved / Checked By	JS		
Project Number	SF240000		



SHORELINE SUBMITTAL


Sheet Title WATERFRONT PROMENADE - POOL

Sheet Number

L3-2-02

PAVING

PC-01 PEDESTRIAN PAVERS AT BOARDWALK PORCELAIN PAVERS - TILE AND MARBLE COLLECTION

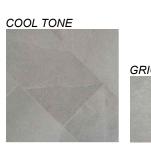







IKON WHITE

PC-05 POURED IN PLACE CONCRETE BAND POURED IN PLACE CONCRETE





PC-08 **DETECTABLE PAVERS**





WALL SURFACES

PC-02

PC-06

BEACH PEBBLES

BLACK BEACH PEBBLES



WS-01

SEATWALL









POURED IN PLACE CONCRETE BENCHES POURED IN PLACE BENCHES





PC-03 & PC-04 **VEHICULAR PAVER & PAVER BAND** PLANK CONCRETE PAVERS



CHARCOAL 60%
TUDOR 40%

PC-07 SYNTHETIC LAWN DOG PARK & LINEAR DOG RUN





WS-02

POURED IN PLACE CONCRETE WALKWAY

COLOR CONCRETE W/ SHELL OR GLASS AGGREGATES





WS-03 WOOD SLATS SEATING WOOD SLATS OVER CONCRETE BENCH





WATER FEATURE

WF-01 **WATER FEATURE** WATER FEATURE & SIGNAGE






ADDT'L DOG PARK AMENITIES





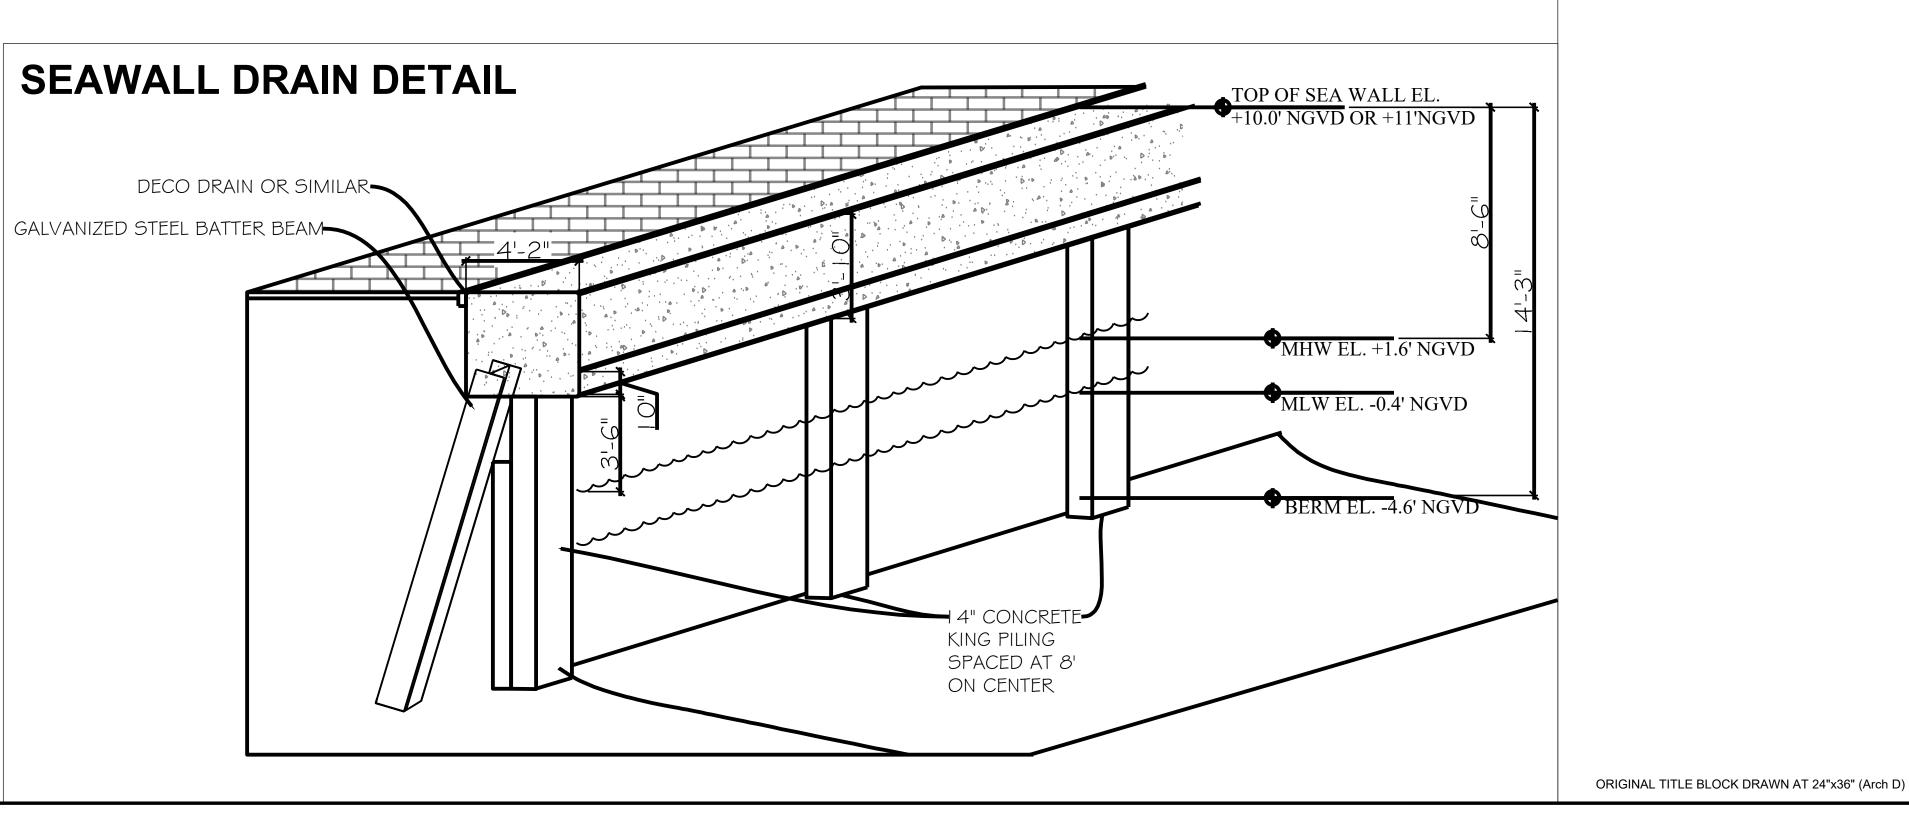


HARDSCAPE LEGEND SYMBOL DESCRIPTION PEDESTRIAN RATED PAVERS PC-01 PC-02 CONCRETE WALKWAY PC-03 VEHICULAR RATED PAVERS PC-04 VEHICULAR RATED PAVER BAND PC-05 CONCRETE BAND PC-06 BEACH PEBBLES PC-07 SYNTHETIC LAWN PC-08 DETECTABLE PAVERS WF-01 WATER FEATURE WS-01 SEATWALL WS-02 CONCRETE WALL WOOD SLATS ON WS-03

CONCRETE WALL

DRAIN



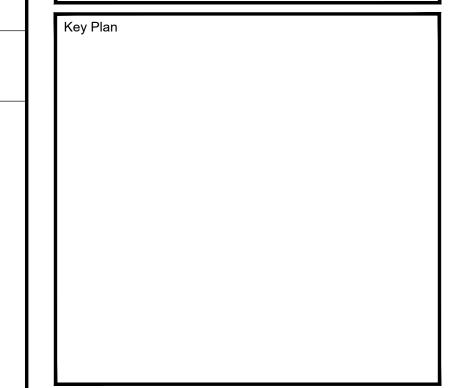

	Rev	Date	Issued for

Date	05/30/2025
Designed By	MH, LDC
Drawn By	LDC
Approved / Checked By	JS
Project Number	SE240000



SHORELINE SUBMITTAL

HARDSCAPE IMAGE BOARD

Sheet Number

L3-5-01

GENERAL NOTES:

- PRIOR TO PLANTING INSTALLATION. THE CONTRACTOR SHALL CONFIRM THE AVAILABILITY OF ALL THE SPECIFIED PLANT MATERIALS. THE CONTRACTOR SHALL SUBMIT DATED PHOTOGRAPHS OF ALL PLANT MATERIAL NOT TAGGED BY THE OWNERS REPRESENTATIVE TO THE OWNERS REPRESENTATIVE FOR REVIEW PRIOR TO DELIVERY OF MATERIALS TO THE PROJECT. ALI PHOTOGRAPHS OF TREES AND PALMS SHALL HAVE A MEASURING DEVICE AND PERSON IN THE PHOTO FOR SCALE. NURSERY SOURCE, HEIGHT, WIDTH AND CALIPER OF PLANT MATERIAL SHALL BE INCLUDED WITH THE PHOTOGRAPH.
- THE PLANT MATERIAL QUANTITIES SHOWN IN THE CONTRACT DOCUMENTS ARE FOR THE CONVENIENCE OF THE CONTRACTOR. THE CONTRACTOR IS RESPONSIBLE FOR VERIFYING ALL PLANT MATERIAL QUANTITIES AND NOTIFYING THE OWNERS REPRESENTATIVE OF ANY DISCREPANCIES FOR CLARIFICATION PRIOR TO THE AWARD OF CONTRACT AND COMMENCEMENT OF
- THE OWNERS REPRESENTATIVE SHALL HAVE THE RIGHT AT ANY STAGE OF THE OPERATION TO REJECT ANY PLANT MATERIALS THAT DO NOT COMPLY WITH THE REQUIREMENTS AS SPECIFIED HEREIN AND REQUIRE THE CONTRACTOR TO REPLACE THE REJECTED MATERIAL WITH MATERIAL MEETING THE SPECIFICATIONS. MAINTENANCE OF REPLACED MATERIAL SHALL CONTINUE UNTIL FINAL ACCEPTANCE.
- 4. THE OWNERS REPRESENTATIVE MAY ADJUST THE LOCATIONS OF THE PLANT MATERIAL SHOWN ON THE PLANS TO ACCOMMODATE UNFORESEEN FIELD CONDITIONS OR TO ACCOMPLISH DESIGN INTENT.
- 5. NO PLANT MATERIAL SUBSTITUTIONS SHALL BE MADE WITHOUT THE WRITTEN CONSENT OF THE OWNERS REPRESENTATIVE.
- 6. THE INSTALLATION OF ALL PLANT MATERIALS SHALL COMPLY WITH THE CODES, STANDARDS, REGULATIONS REQUIREMENTS AND ORDINANCES OF ANY GOVERNMENTAL AGENCY HAVING JURISDICTION OVER THE WORK.
- THE CONTRACTOR SHALL BE RESPONSIBLE FOR OBTAINING ALL PERMITS REQUIRED FOR THIS WORK PRIOR TO THE START OF CONSTRUCTION,
- . THE CONTRACTOR SHALL BE RESPONSIBLE FOR AND BEAR ALL COSTS RELATED TO THE TESTING OF EXISTING SOILS, PREPARED PLANTING MIXES AND AMENDMENTS.
- 9. THE CONTRACTOR SHALL PROTECT ALL PLANT MATERIAL TO REMAIN. THE CONTRACTOR SHALL INSTALL AND/OR MAINTAIN BARRICADES AS DETAILED ON THE DRAWINGS AND AS OUTLINED IN THE DEMOLITION/SITE CLEARING NOTES.
- 10. THE CONTRACTOR SHALL REFER TO THE GENERAL. FINE GRADING AND HARDSCAPE NOTES. SPECIFICATIONS AND THE CONTRACT DOCUMENTS PREPARED BY BUT NOT LIMITED TO ARCHITECTURAL, MEP, IRRIGATION, STRUCTURAL AND CIVIL ENGINEERING CONSULTANTS FOR ADDITIONAL REQUIREMENTS.
- 11. ALL PLANT MATERIAL SHALL MEET OR EXCEED THE FOLLOWING:
- A. AMERICAN STANDARDS FOR NURSERY STOCK, ASNI Z60.1
- B, FLORIDA GRADE NO. 1. FLORIDA DEPARTMENT OF AGRICULTURE GRADES AND STANDARDS FOR NURSERY PLANTS LATEST ADDITION.
- 12. PLANTS SHALL BE SYMMETRICAL AS IS TYPICAL FOR THEIR VARIETY AND SPECIES. THEY SHALL BE FREE FROM PLANT DISEASE, INSECTS OR THEIR EGGS.
- 13. NURSERY GROWN STOCK SHALL BE GROWN UNDER CLIMATIC CONDITIONS SIMILAR TO THOSE IN THE LOCALITY OF THE PROJECT.
- 14. ALL PLANT MATERIAL SIZES SPECIFIED ARE MINIMUM SIZES. HEIGHT AND SPREAD TAKE PRECEDENCE OVER CALIPER AND CONTAINER SIZES.
- 15. CONTAINER PLANTS SHALL HAVE BEEN GROWN IN A RIGID CONTAINER FOR A MINIMUM TIME AS FOLLOWS:
- A. TREES.....2 YEARS.
- B. SHRUBS....1 YEAR.
- C. GROUNDCOVERS....6 MONTHS.
- 16. ALL CONTAINER PLANTS SHALL HAVE ROOTS SUFFICIENTLY DEVELOPED TO HOLD THE SOIL TOGETHER WHEN REMOVED FROM ITS CONTAINER. NO PLANT MATERIAL SHALL BE BOUND TO THE CONTAINER NOR HAVE CIRCULAR ROOTS.
- 17. BALLED AND BURLAPPED PLANTS WILL NOT BE ACCEPTED WHEN THE ROOT BALL HAS BEEN CRACKED OR BROKEN.
- 18. PLANTS GROWN IN GROW BAGS ARE PROHIBITED.
- 19. SOD SHALL BE THE SPECIES AS CALLED FOR ON THE DRAWINGS. SOD SHALL BE WELL MATTED WITH HEAVY ROOT DEVELOPMENT AND FREE OF WEEDS, FUNGUS AND OTHER DISEASES.
- 20. SOD SHALL BE MACHINE CUT TO A COMMERCIAL SIZE WITH A UNIFORM THICKNESS OF 1-1/4 TO 1-1/2 INCH THICKNESS.

SOIL PREPARATION AND SOIL MIX NOTES: (cont.)

- C. SHRUBS/GROUNDCOVERS......8-10-10 PLUS MINOR ELEMENTS-SLOW RELEASE. 1/2 LB. FERTILIZER PER 100 SQ. FT.
- D. LAWNS..... ...16-4-8 PLUS MINOR ELEMENTS-SLOW RELEASE. 1LB. FERTILIZER PER 1,000 SQ. FT.
- E. ENDO AND ECTOMYCORRIZAL INOCULANTS......DIE HARD OR OWNERS REPRESENTATIVE APPROVED EQUAL
- F. ANTI-DESICCANT......WILT-PRUF OR OWNERS REPRESENTATIVE APPROVED EQUAL
- 10. ALL FERTILIZERS SHALL BE MANUFACTURED FROM QUALITY MATERIALS. FREE FROM IMPURITIES AND SHALL MEET RECOGNIZED STANDARDS FOR EFFECTIVENESS.
- 11. ALL FERTILIZERS SHALL BE FREE FLOWING AND SUITABLE FOR APPLICATION WITH APPROVED EQUIPMENT.
- 12. ALL FERTILIZER SHALL BE DELIVERED TO THE SITE IN CONTAINERS. EACH FULLY LABELED CONFORMING TO APPLICABLE STATE FERTILIZER LAWS AND BEARING THE GRADE AND TRADE NAME OF THE PRODUCER.
- 13. AFTER ROUGH GRADING HAS BEEN COMPLETED ONE SAMPLE OF EXISTING SOIL PER 5,000 SQ. FT. OF LANDSCAPE AREAS SHALL BE SUBMITTED TO A CERTIFIED SOILS TESTING LABORATORY FOR ANALYSIS AS TO THE SUITABILITY OF THE EXISTING SOIL TO MEET THE REQUIREMENT OF THE PREPARED PLANTING MIX.
- 14. SOIL SAMPLES SHALL BE TAKEN TO A DEPTH OF TWENTY-FOUR INCHES (24").
- 15. SHOULD TEST RESULTS INDICATE THAT THE EXISTING SOILS DO NOT FALL WITHIN THE REQUIREMENS FOR PREPARED PLANTING MIX THE CONTRACTOR SHALL:
- A. SUBMIT TO THE OWNERS REPRESENTATIVE FOR APPROVAL AN AMENDED PLANTING MIX ALONG WITH RECOMMENDATION FOR ORGANIC MATERIALS, FERTILIZERS AND/OR OTHER MATERIALS FOUND NECESSARY TO ASSURE OPTIMUM PLANT GROWTH. PROPOSED REVISIONS SHALL INCLUDE METHODOLOGY FOR INCORPORATING THE AMENDMENTS TO A DEPTH OF TWENTY-FOUR INCHES (24"). ANY RECOMMENDED REVISIONS SHALL BE APPROVED BY THE OWNERS REPRESENTATIVE PRIOR TO INSTALLATION OF THE AMENDED PLANTING MIX.....OR
- B. EXCAVATE LANDSCAPE BEDS CONTAINING NONCOMPLIANT EXISTING SOILS TO A DEPTH OF 24 INCHES (24") AND BACKFILL WITH PREPARED PLANTING MIX AS SPECIFIED. PREPARED PLANTING MIX SHALL BE PLACED AND COMPACTED TO 80% STANDARD PROCTOR IN TWELVE INCH (12") LIFTS.
- 16. EXISTING SOILS MAY BE USED IN EITHER THE PREPARED OR AMENDED PLANTING MIXES AS DETERMINED BY THE SOIL TEST RECOMMENDATIONS.
- 17. EXCAVATED SOIL MAY BE USED FOR ONSITE FILL IF IT COMPLIES WITH GEOTECHNICAL REQUIREMENTS.
- 18. SUBMITTALS:
- RESULTS OF SOILS TESTS INCLUDING CONTENT/MIX ANALYSIS AND AMENDMENT RECOMMENDATIONS.
- B. CERTIFICATION THAT PREPARED AND/OR AMENDED PLANTING MIX MEETS REQUIREMENTS
- C. LITERATURE AND PROPOSED APPLICATION RATES FOR SOIL AMENDMENTS, HERBICIDES AND STERILIZERS.

PLANTING NOTES: (cont.)

- 12. ALL PLANT PITS SHALL BE EXCAVATED TO A WIDTH AND DEPTH AS INDICATED ON THE DRAWINGS.
- 13. PLANT MATERIALS SHALL BE CENTERED IN THEIR PITS, FACED FOR BEST EFFECT AND SET PLUMB FOR BACKFILLING.
- 14. SHRUB/GROUNDCOVER PLANTINGS SHOWN IN MASS PLANTING BEDS SHALL BE PLACED ON A TRIANGULAR SPACING CONFIGURATION. SEE DRAWINGS FOR TRIANGULAR SPACING DETAIL AND PLANT MATERIAL LIST FOR ON-CENTER PLANT SPACING.
- 15. BALLED AND BURLAPPED PLANTS SHALL HAVE THE BURLAP, STRINGS, STRAPS AND WIRE CAGES REMOVED FROM THE TOP 1/3 OF THE ROOT BALL.
- 16. PLACE BACKFILL IN PLANT PITS IN LAYERS NOT TO EXCEED 1/3 THE DEPTH OF THE ROOT BALL AND TAMP FIRMLY IN PLACE. PRIOR TO PLACING THE FINAL LAYER, THE PIT SHALL BE FILLED WITH WATER AND THE SOIL ALLOWED TO SETTLE.
- 17. AFTER SETTLEMENT THE CROWN OF THE ROOT BALL SHALL BE ABOVE FINISHED GRADE AS INDICATED ON THE DRAWINGS. PLANTS WITH ROOT BALLS SET BELOW INDICATED HEIGHTS WILL BE REQUIRED TO BE REMOVED AND REPLANTED.
- 18. TREES/PALMS SHALL BE STAKED ACCORDING TO THE DETAILS ON THE DRAWINGS.
- 19. MULCH AS DESIGNATED ON THE DRAWINGS SHALL BE PLACED THROUGHOUT ALL PLANTING AREAS.
- 20, NO MULCH SHALL BE PLACED OVER SHRUB/GROUNDCOVER ROOT BALLS OR WITHIN 4" OF TREE OR PALM TRUNKS.
- 21, SOD SHALL BE PLACED WITH STAGGERED BUTT TIGHT JOINTS. THERE SHALL BE NO VOIDS OR OVERLAPPING OF EDGES BETWEEN SOD PIECES.
- 22. SOD SHALL BE ROLLED IMMEDIATELY AFTER BEING PLACED. CLEAN BUILDERS' SAND SHALL BE USED TO FILL ANY RESULTING VOIDS OR UNEVENNESS IN THE SOD SURFACE. ANY AREAS REQUIRING EXCESSIVE TOP-DRESSING SHALL HAVE THE SOD REMOVED, THE AREA REGRADED AND RE-SODDED.
- 23. THE CONTRACTOR SHALL REFER TO THE LANDSCAPE PLANTING DETAILS AND/OR SPECIFICATIONS FOR ADDITIONAL PLANTING INSTRUCTIONS.

Project Name

ISLE OF DREAMS

ARQUITECTONICA

LANDSCAPE ARCHITECTURE **URBAN DESIGN**

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Consultants:

Key Plan

	Rev	Date	Issued for

Date	05/30/2025
Designed By	MH, LDC
Drawn By	LDC
Approved / Checked By	JS
Project Number	SE240000



Project Phase

SHORELINE SUBMITTAL

PLANTING NOTES

Sheet Number

ORIGINAL TITLE BLOCK DRAWN AT 24"x36" (Arch D)

L5-0-01


SOIL PREPARATION AND SOIL MIX NOTES: PLANTING NOTES:


- PREPARED PLANTING MIX SHALL CONSIST OF THE FOLLOWING:
- A. TREES/SHRUBS/GROUNDCOVER.....70% CLEAN BUILDERS SAND, 30% TOPSOIL/PEAT MIX.
- B. PALMS...90% CLEAN BUILDERS SAND, 10% TOPSOIL/PEAT MIX.
- C. ANNUALS.....50% CLEAN BUILDERS SAND, 25% PEAT, 25% VERMICULITE.
- 2. PREPARED PLANTING MIX FOR LANDSCAPE ON STRUCTURE SHALL CONSIST OF THE FOLLOWING:
- A. 20% CLEAN BUILDERS SAND, 30% PEAT, 30% RICE ROCK, 20% PERLITE.
- 3. THE COMPOSITION OF THE PREPARED PLANTING MIX MAY BE MODIFIED BASED ON RECOMMENDATIONS FROM THE SOIL TEST(S).
- 4. TOPSOIL SHALL BE NATURAL SURFACE SOIL, FERTILE, FRIABLE AGRICULTURAL SOIL FREE OF WEEDS WITH 4-6% ORGANIC MATTER, A PH OF 5.5 TO 6.5 AND CAPABLE OF SUSTAINING VIGOROUS PLANT GROWTH.
- 5. EXISTING SOIL MAY BE SUBSTITUTED FOR TOPSOIL AND/OR SAND BASED ON THE RESULTS OF THE SOIL TEST(S).
- 6. PEAT SHALL BE ORGANIC PEAT SUITABLE FOR HORTICULTURAL PURPOSES. PEAT SHALL BE SHREDDED WITH PIECES NO LARGER THAN ONE-HALF INCH (1/2") IN DIAMETER. PEAT SHALL HAVE A PH OF 4.5 TO 6.5 AND SHALL BE STERILIZED TO MAKE IT FREE OF WEEDS AND NEMATODES.
- COMPOSTED ORGANICS SHALL BE WOOD SHAVINGS, PINE BARK, GREEN WASTES OR CLEAN AGRICULTURAL WASTES, WELL-ROTTED AND SCREENED THROUGH A ONE-HALF INCH (1/2") SCREEN.
- 8. COMPONENTS OF THE PREPARED PLANTING MIX SHALL BE BLENDED OUTSIDE OF THE PLANTING BEDS. THE CONTRACTOR SHALL SUBMIT A 2-GALLON SAMPLE TO A CERTIFIED SOILS TEST LABORATORY FOR ANALYSIS. BASED ON THE LABORATORY ANALYSIS THE CONTRACTOR SHALL APPLY SOIL AMENDMENTS AS NECESSARY TO ADJUST THE PREPARED PLANTING MIX TO MEET THE FOLLOWING REQUIREMENTS:
- A. PH VALUE BETWEEN 5.5 AND 6.6.
- B. ORGANIC MATTER CONTENT BETWEEN 5% AND 10% OF TOTAL DRY WEIGHT.
- C. NITROGEN 5% AVERAGE OF OF ORGANIC MATTER.
- D. PHOSPHORUS 0.05% AVERAGE OF TOTAL SOIL CONTENT.
- E. POTASSIUM 1.2% AVERAGE OF TOTAL SOIL CONTENT.
- 9. FERTILIZER FOR PLANT MATERIALS SHALL BE AS FOLLOWS:
- A. PALMS..........13-3-13 PLUS MINOR ELEMENTS-SLOW RELEASE, 1/2 LB, FERTILIZER PER 1/2 CALIPER INCH.
- B. TREES........ 8-6-6 PLUS MINOR ELEMENTS-SLOW RELEASE. 1/2 LB. FERTILIZER PER 1/2 CALIPER INCH.


- 1. PRIOR TO THE INSTALLATION OF PLANT MATERIALS, THE CONTRACTOR SHALL CONFIRM IN WRITING TO THE OWNERS REPRESENTATIVE THAT THE FINISHED GRADES IN ALL AREAS WHERE PLANT MATERIALS ARE TO BE INSTALLED CONFORM TO THE PROPOSED GRADES NOTED ON THE GRADING PLANS.
- 2. PLANTING SHALL NOT COMMENCE UNTIL IRRIGATION HAS BEEN INSTALLED AND IS OPERATIONAL. TREES MAY BE INSTALLED PRIOR TO THE INSTALLATION OF IRRIGATION PROVIDED THAT A HAND WATERING SCHEDULE IS SUBMITTED TO AND APPROVED BY THE OWNERS REPRESENTATIVE.
- THE CONTRACTOR SHALL SUBMIT WEED CONTROL PRODUCTS THAT DO NOT INCLUDE GLYPHOSATE. PROTECT EXISTING PLANTS TO REMAIN FROM OVERSPRAY. DO NOT APPLY WITHIN ROOT ZONES OF EXISTING PLANT MATERIAL TO REMAIN. CONTRACTOR TO ENSURE TOTAL WEED ERADICATION PRIOR TO INSTALLATION OF PLANT MATERIAL
- 4. CONTRACTOR SHALL CONFIRM THAT ALL ORGANICS, SOD, WEEDS, ROOTS AND DEBRIS HAVE BEEN REMOVED TO A DEPTH OF 12 INCHES FROM ALL AREAS WHERE PLANT MATERIALS ARE TO BE INSTALLED. ALL PAVEMENT AND PAVEMENT BASE MATERIAL SHALL BE REMOVED COMPLETELY IN ALL AREAS WHERE PLANT MATERIALS ARE TO BE INSTALLED.
- 5. ANY DEPRESSIONS OR EXCAVATIONS BELOW THE APPROVED FINISHED GRADES CREATED FOR OR BY THE REMOVAL OF SUCH OBJECTS SHALL BE REFILLED WITH CLEAN COARSE SAND AND COMPACTED TO A DENSITY CONFORMING TO THE SURROUNDING GROUND.
- 6. THE CONTRACTOR SHALL PAINT THE OUTLINE OF EACH SHRUB AND GROUNDCOVER BED AND STAKE THE LOCATION OF ALL TREES/PALMS FOR APPROVAL OF THE OWNERS REPRESENTATIVE PRIOR TO INSTALLATION.
- 7. TREE/PALM PITS SHALL BE TESTED FOR VERTICAL DRAINAGE BY FILLING WITH WATER TWICE IN SUCCESSION. CONDITIONS PERMITTING THE RETENTION OF MORE THAN 6 INCHES OF WATER IN 1 HOUR SHALL BE BROUGHT TO THE ATTENTION OF THE OWNERS REPRESENTATIVE. THE CONTRACTOR SHALL SUBMIT A WRITTEN PROPOSAL FOR CORRECTION OF SUCH CONDITIONS BEFORE PROCEEDING WITH INSTALLATION.
- 8. UNIFORMLY APPLY REQUIRED AMENDMENTS TO AREAS TO RECEIVE SOD AND CULTIVATE BY MECHANICAL TILLING INTO THE TOP 6 INCHES OF SOIL.
- 9. AREAS TO RECEIVE SOD SHALL BE GRADED TO LEVEL OUT ALL UNDULATIONS OR IRREGULARITIES IN THE SURFACE RESULTING FROM TILLAGE, FERTILIZING OR OTHER OPERATIONS. THE RESULTING SURFACE SHALL BE ROLLED WITH THE RESULTING GRADE TO BE NO HIGHER THAN THE ADJACENT PAVING OR OTHER GRADE ELEMENTS AFTER SOD HAS BEEN INSTALLED.
- 10. PLANTING BEDS SHALL THEN BE FINE GRADED TO A SMOOTH AND EVEN SURFACE ASSURING POSITIVE DRAINAGE AWAY FROM STRUCTURES AND ELIMINATING ANY DEPRESSIONS WHICH MAY COLLECT WATER.
- 11. "SURFLAN" OR OWNER REPRESENTATIVE APPROVED EQUAL PRE-EMERGENT HERBICIDE SHALL BE APPLIED TO ALL PLANTING BEDS IN ACCORDANCE WITH THE MANUFACTURES RECOMMENDED RATE.

POST PLANTING NOTES:

- 1. MAINTENANCE:
- A. DURING THE PROJECT WORK PERIOD PRIOR TO SUBSTANTIAL COMPLETION ACCEPTANCE, THE CONTRACTOR SHALL MAINTAIN ALL PLANT MATERIAL
- B. MAINTENANCE DURING THE WORK PERIOD PRIOR TO THE SUBSTANTIAL COMPLETION ACCEPTANCE SHALL CONSIST OF WATERING, CULTIVATING, WEEDING, MULCHING, REMOVAL OF DEAD MATERIAL, REPAIRING/TIGHTENING OF STAKES AND GUYS, RESETTING PLANTS TO PROPER GRADES AND UPRIGHT POSITION AND FURNISHING AND APPLYING SUCH SPRAYS AS NECESSARY TO KEEP PLANT MATERIAL REASONABLY FREE OF DAMAGING INSECTS AND DISEASE.
- C. THE CONTRACTOR SHALL BE RESPONSIBLE FOR HAND WATERING ALL PLANT MATERIAL AS REQUIRED TO SUPPLEMENT IRRIGATION AND RAINFALL IN ORDER TO ENSURE PLANT MATERIAL ESTABLISHMENT.
- 2. SUBSTANTIAL COMPLETION ACCEPTANCE:
- A. UPON WRITTEN NOTICE FROM THE CONTRACTOR, THE OWNERS REPRESENTATIVE SHALL REVIEW THE WORK AND DETERMINE IF THE WORK IS SUBSTANTIALLY COMPLETE.
- B. FOR THE PURPOSE OF ACCEPTANCE ALL PLANT MATERIAL SHALL BE HEALTHY, VIGOROUS, UNDAMAGED, FREE OF WEEDS AND DISEASE, AND EXHIBITING EVIDENCE OF ESTABLISHING NEW ROOTS. PLANT MATERIAL DEEMED UNACCEPTABLE SHALL BE REMOVED AND REPLACED.
- C. THE DATE OF SUBSTANTIAL COMPLETION OF THE PLANTING SHALL BE THE DATE WHEN THE OWNERS REPRESENTATIVE ACCEPTS IN WRITING THAT ALL WORK RELATED TO PLANTING IS COMPLETE.
- 3. WARRANTY:
- A. ALL PLANT MATERIAL SHALL BE WARRANTED IN WRITING BY THE CONTRACTOR FOR A PERIOD OF ONE (1) YEAR FROM THE DATE OF WRITTEN NOTIFICATION OF SUBSTANTIAL COMPLETION . REPLACEMENT OF PLANT MATERIAL DURING THE WARRANTY PERIOD SHALL BE THE RESPONSIBILITY OF THE CONTRACTOR AND SHALL HAVE THE SAME WARRANTY PERIOD OF ONE (1) YEAR FROM DATE OF REPLACEMENT.

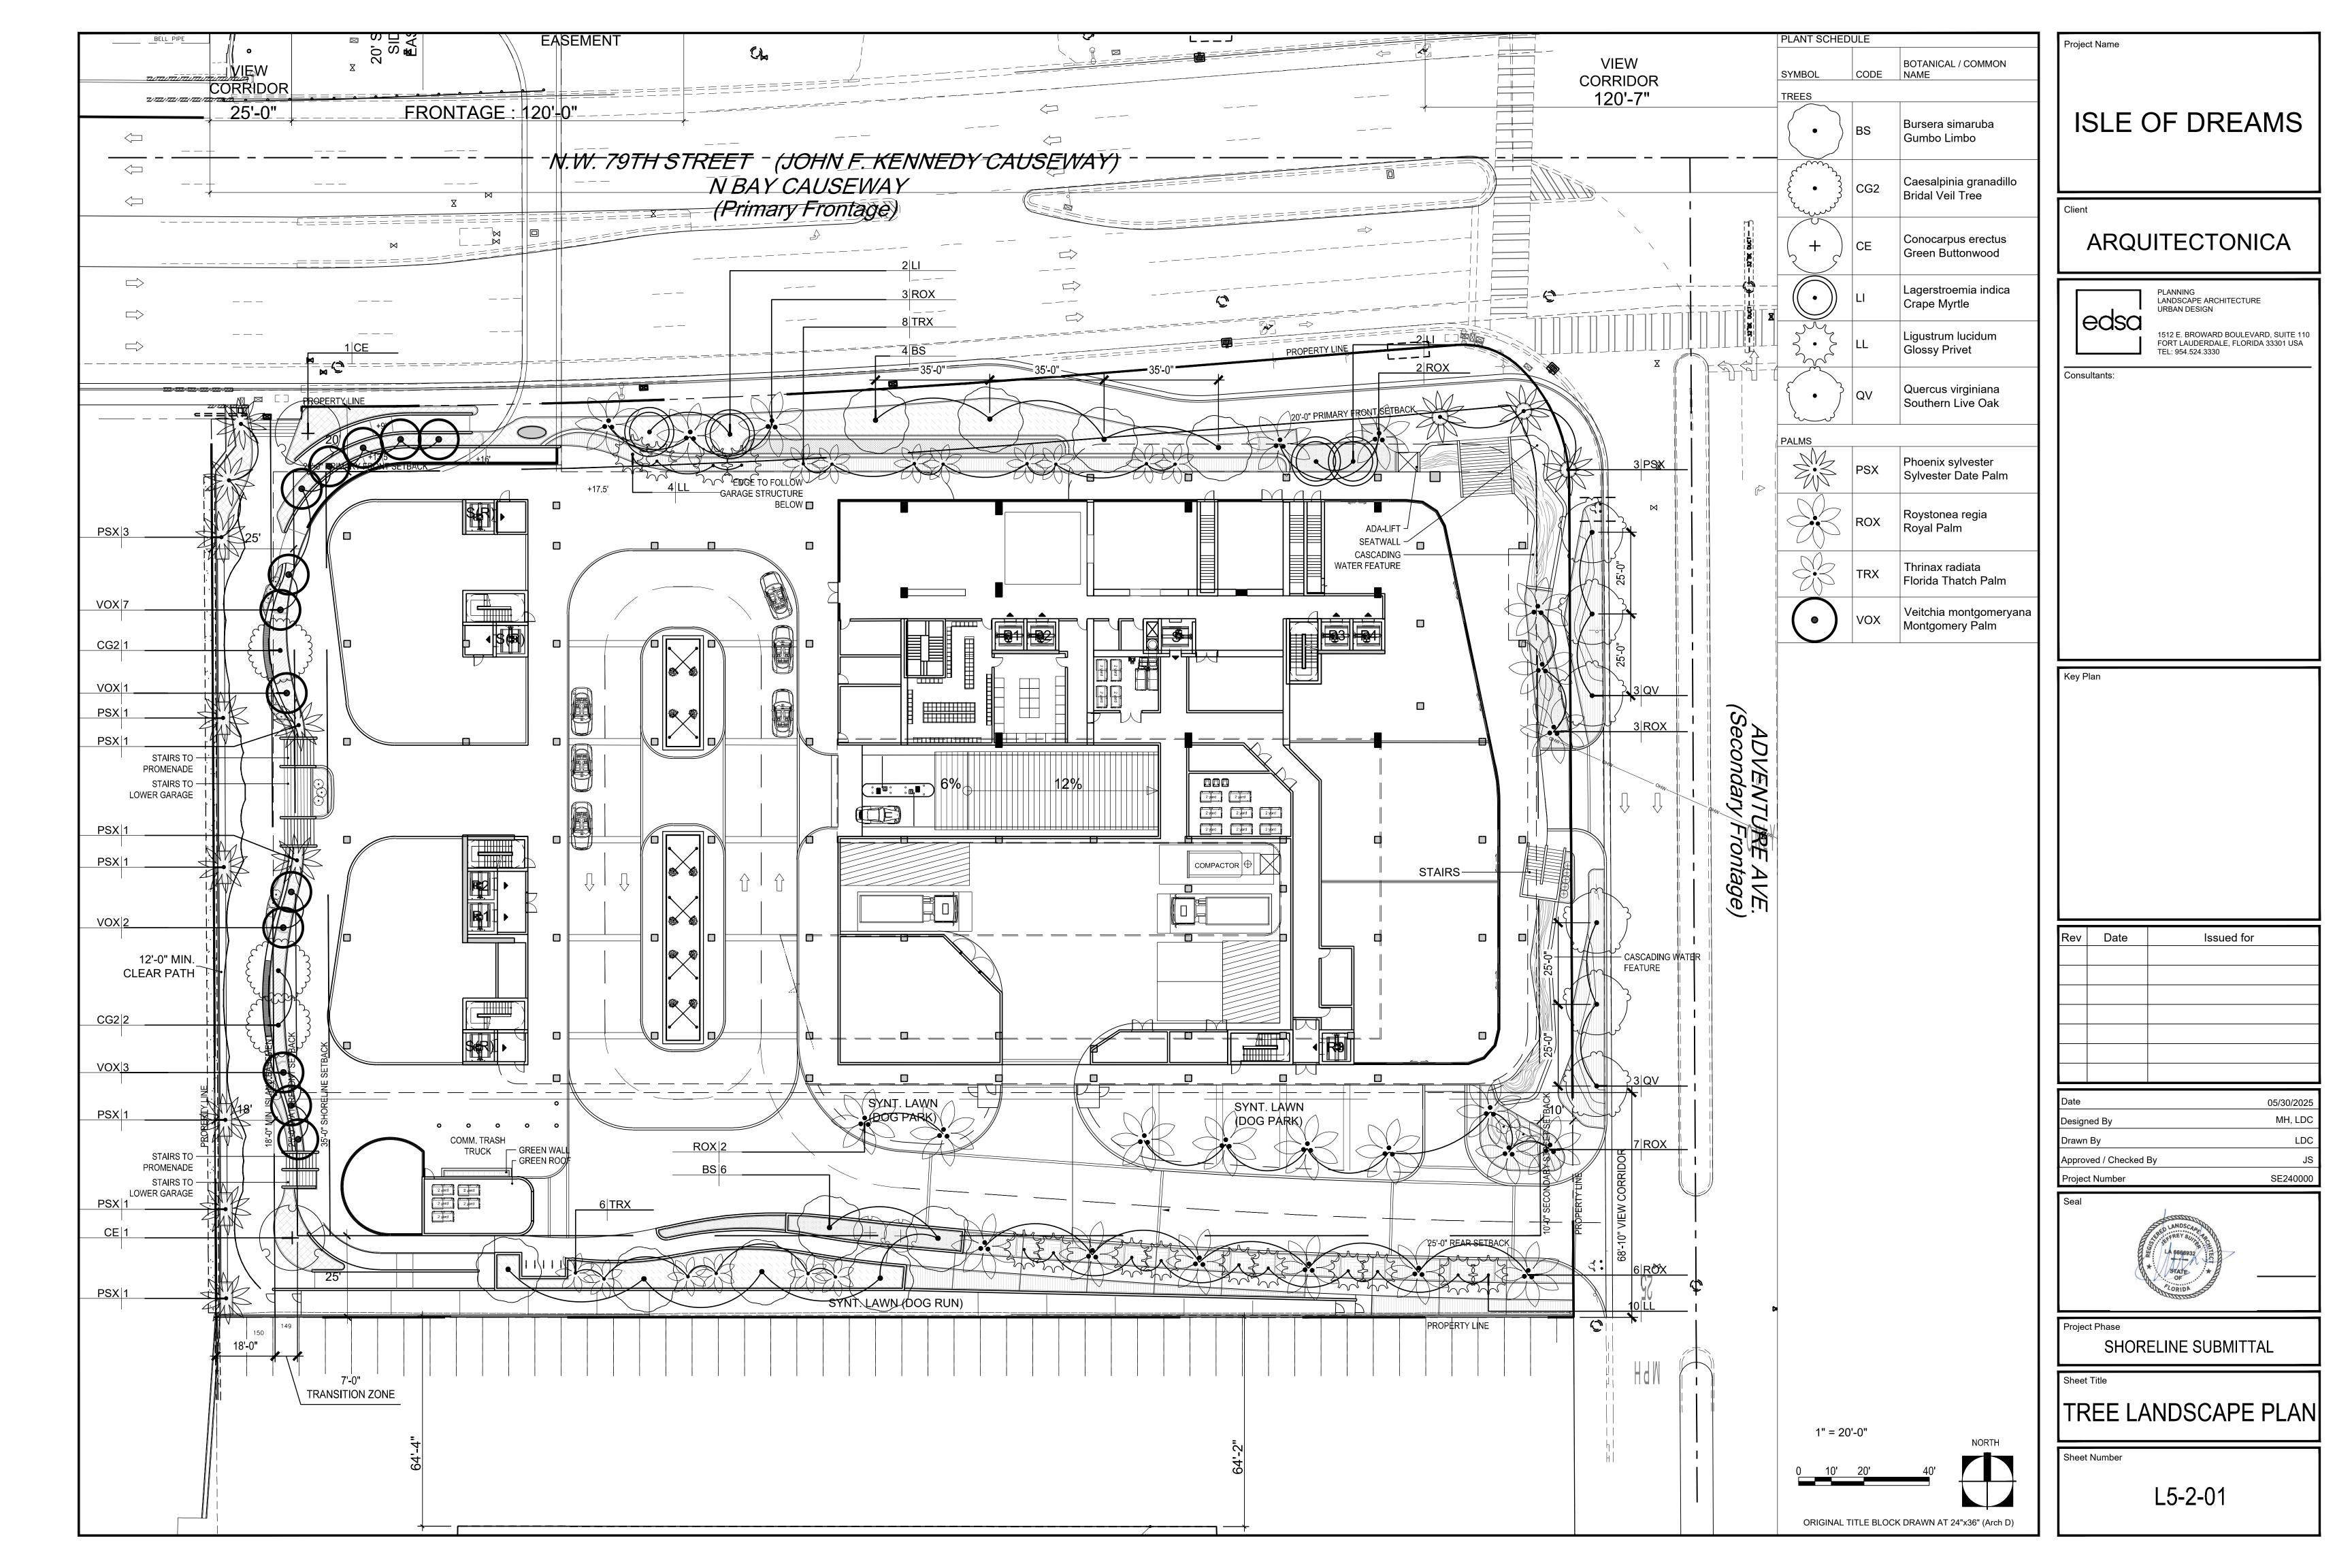

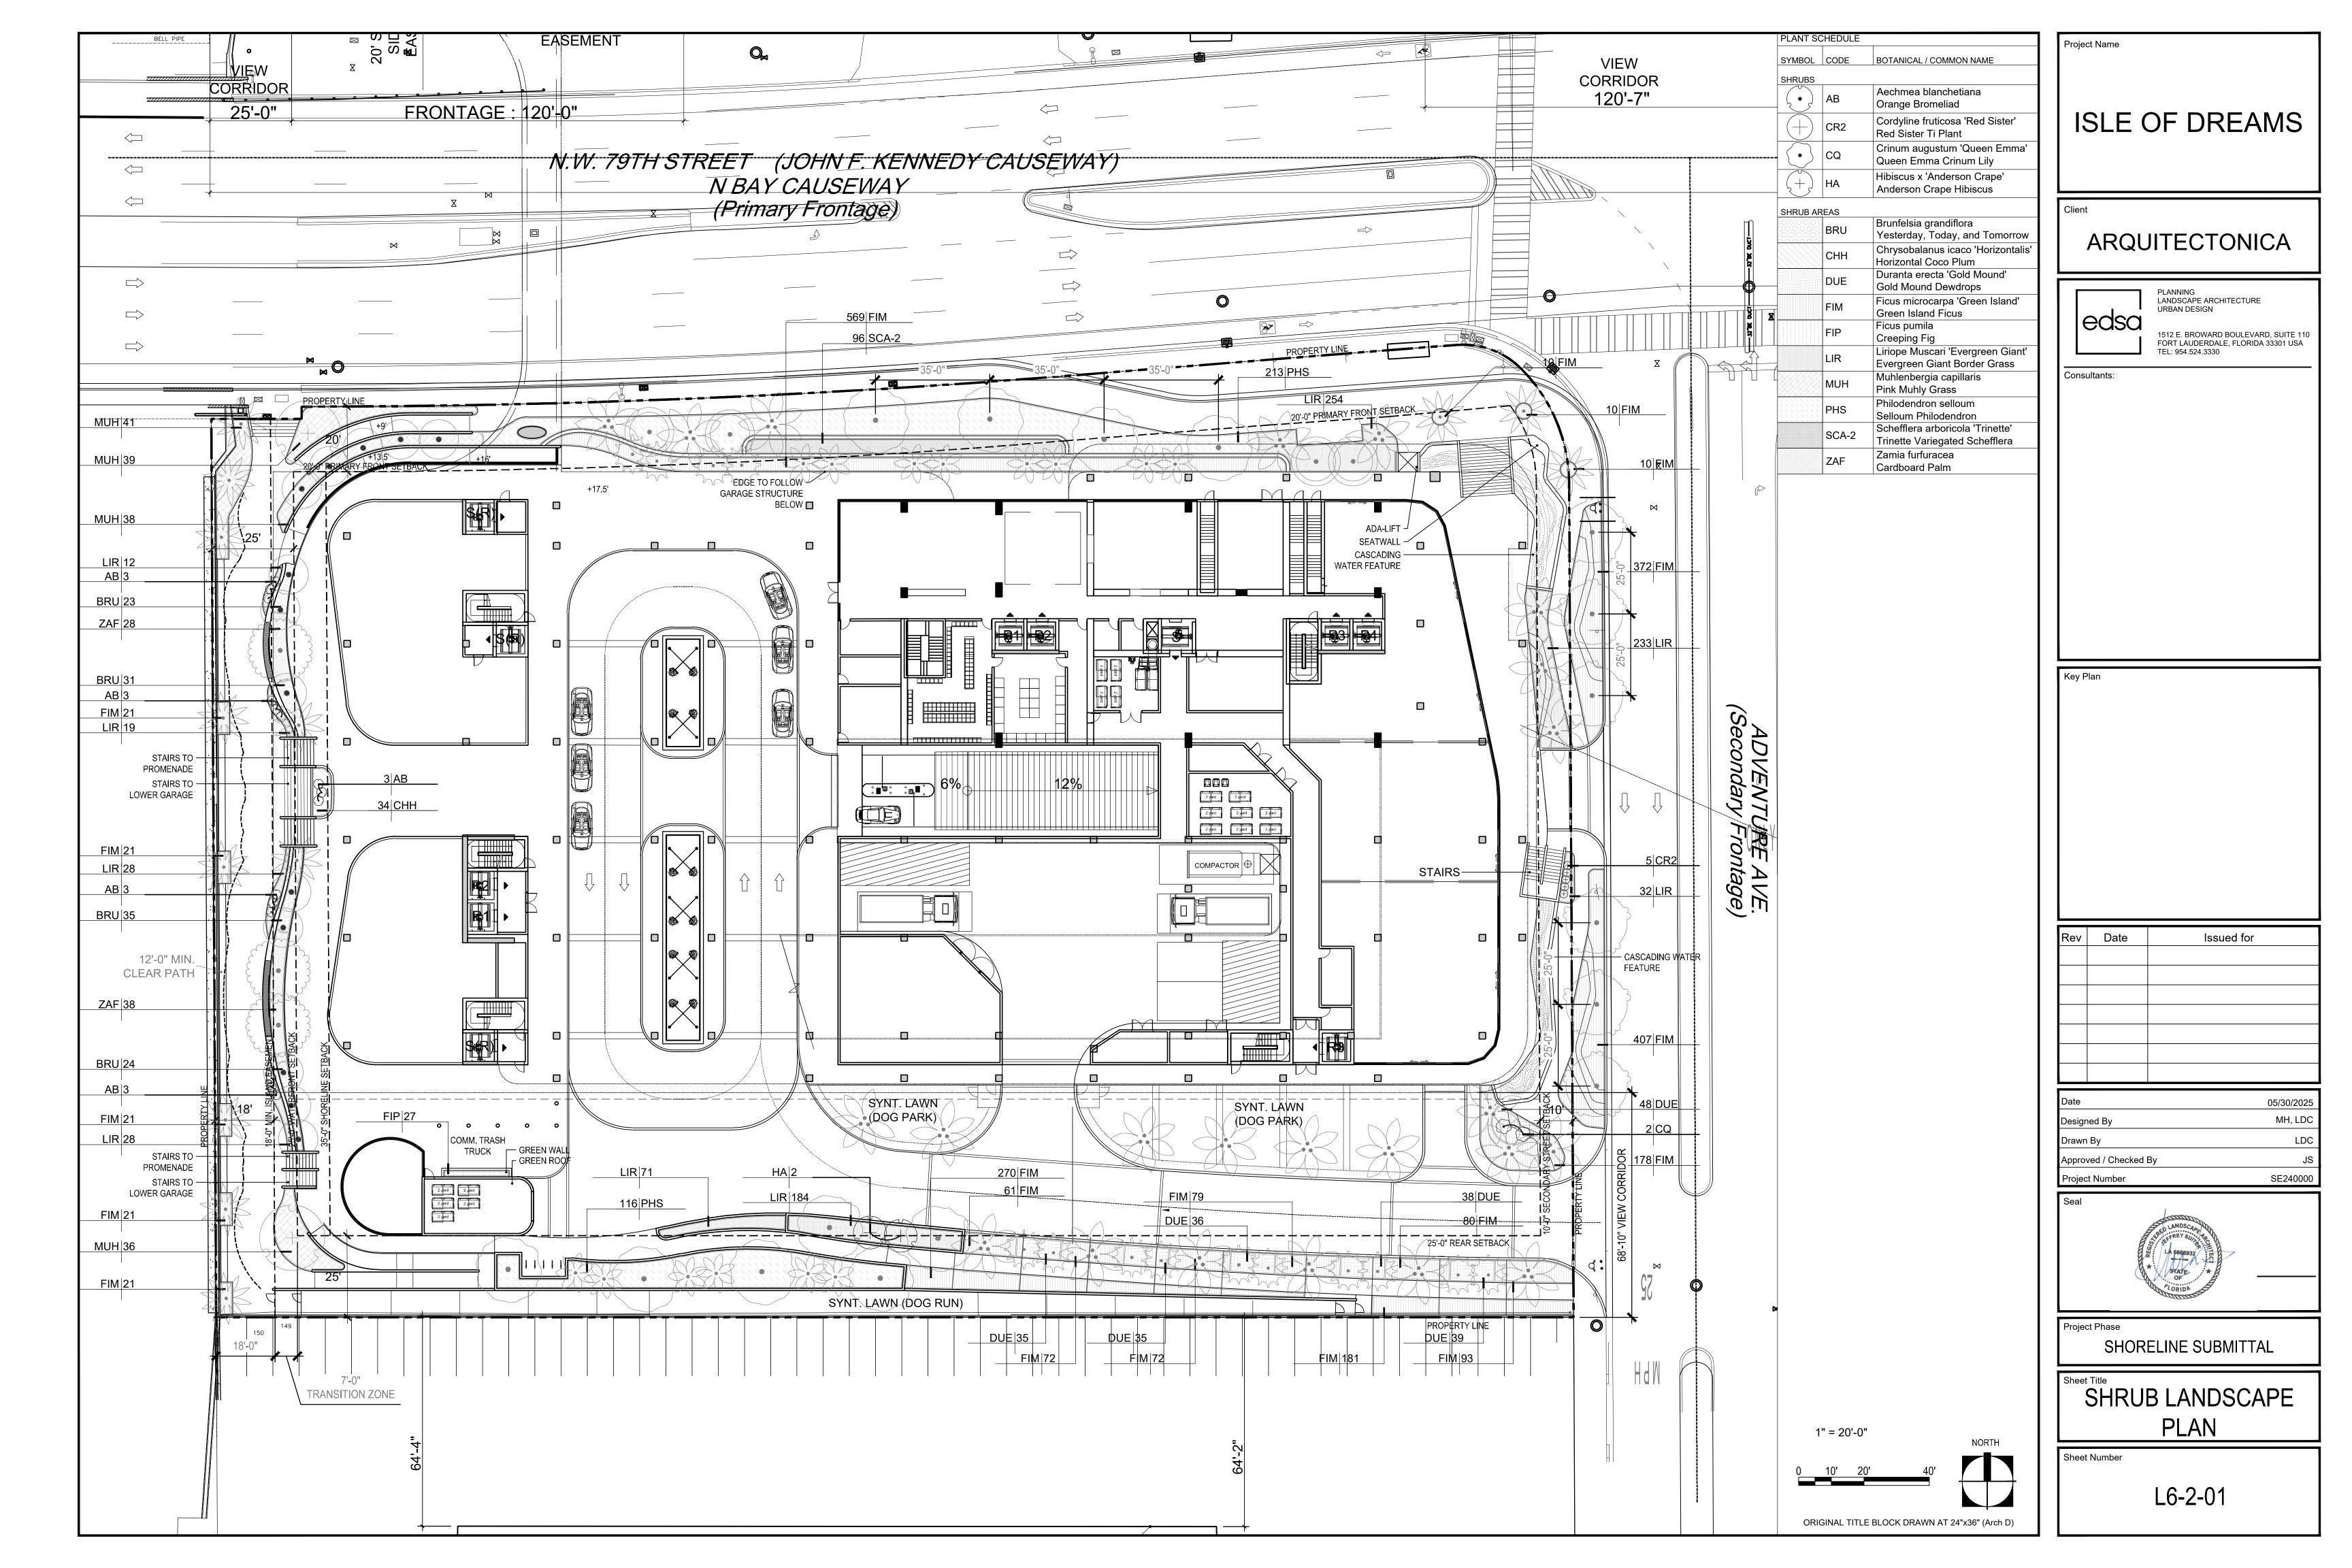

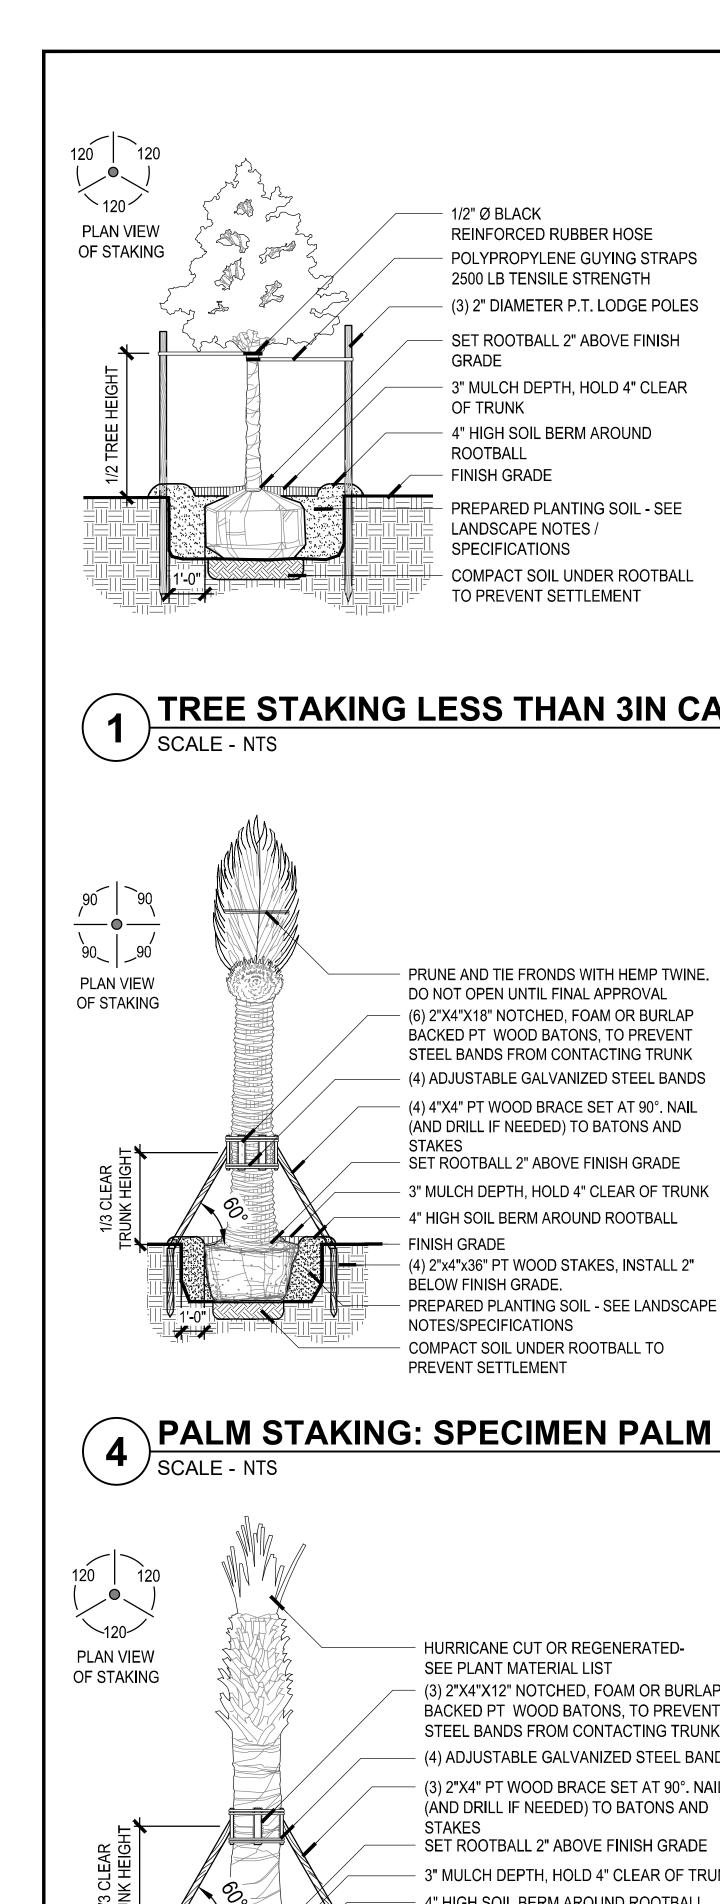


NOTE:

- CONTRACTOR TO STAKE LOCATION OF TREES FOR APPROVAL BY OWNER'S REPRESENTATIVE PRIOR TO INSTALLATION

- CONTRACTOR TO ASSURE PERCOLATION IN ALL PLANTING PITS PRIOR TO INSTALLATION (SEE LANDSCAPE NOTES / SPECIFICATIONS)

- ALL TREES TO BE SET PLUMB IN PLANTING PIT

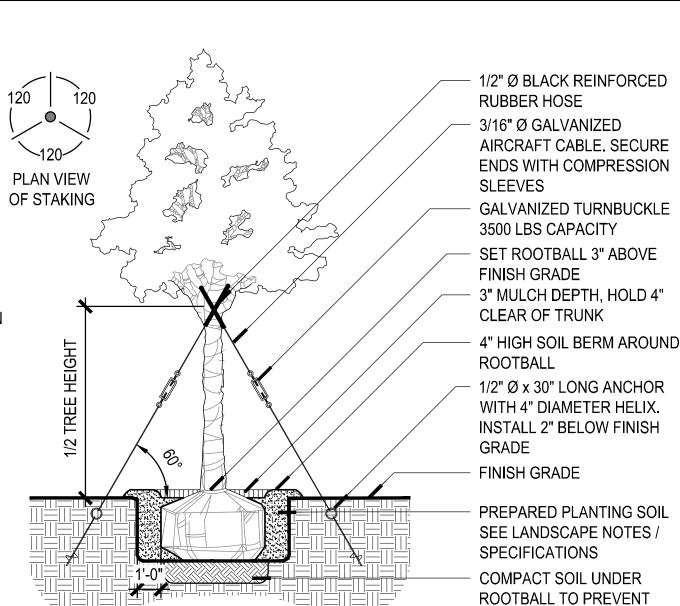


SCALE - NTS

- CONTRACTOR TO STAKE LOCATION OF TREES FOR APPROVAL BY OWNER'S REPRESENTATIVE PRIOR TO INSTALLATION

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ISLE OF DREAMS

ARQUITECTONICA

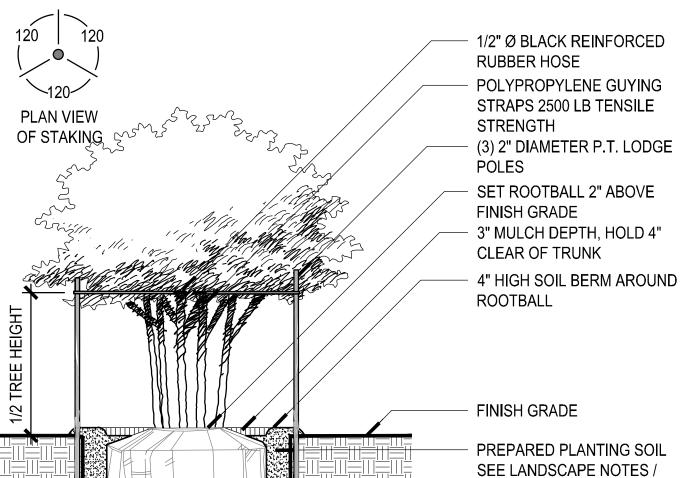LANDSCAPE ARCHITECTURE **URBAN DESIGN**

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Consultants:

Key Plan

Date

Issued for

05/30/202

SE240000

MH, LDC

Project Name


TREE STAKING LESS THAN 3IN CALIPER

NOTE: - CONTRACTOR TO STAKE LOCATION OF PALMS FOR APPROVAL BY OWNER'S REPRESENTATIVE PRIOR TO

INSTALLATION

- CONTRACTOR TO ASSURE PERCOLATION IN ALL PLANTING PITS PRIOR TO INSTALLATION (SEE LANDSCAPE NOTES / SPECIFICATIONS)

- ALL PALMS TO BE SET PLUMB IN PLANTING PIT

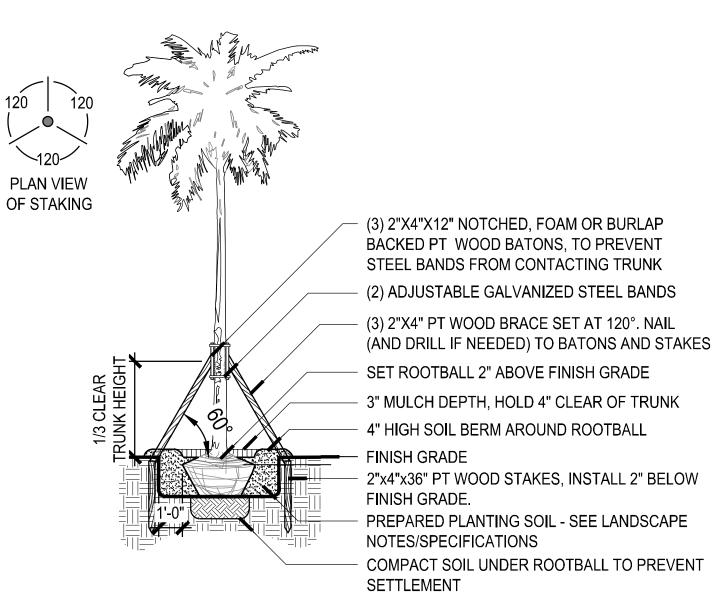

PALM STAKING SMALL

NOTE:

SETTLEMENT

PLANT MATERIAL - SEE LANDSCAPE


PLANS

TREE STAKING 3-7 IN CALIPER-CABLE

- CONTRACTOR TO STAKE LOCATION OF PALMS FOR APPROVAL BY OWNER'S REPRESENTATIVE PRIOR TO INSTALLATION

 CONTRACTOR TO ASSURE PERCOLATION IN ALL PLANTING PITS PRIOR TO INSTALLATION (SEE LANDSCAPE NOTES / SPECIFICATIONS)

- ALL PALMS TO BE SET PLUMB IN PLANTING PIT

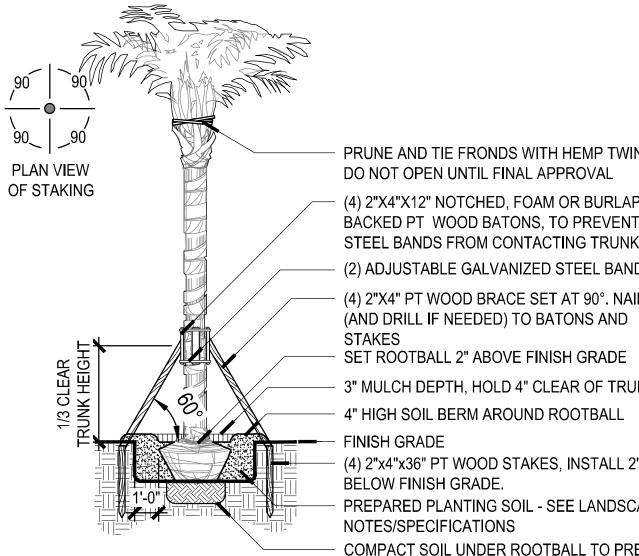

PRUNE AND TIE FRONDS WITH HEMP TWINE. DO NOT OPEN UNTIL FINAL APPROVAL (4) 2"X4"X12" NOTCHED, FOAM OR BURLAP

SPECIFICATIONS

SETTLEMENT

TREE STAKING MULTI-STEM TREE

COMPACT SOIL UNDER

ROOTBALL TO PREVENT

STEEL BANDS FROM CONTACTING TRUNK (2) ADJUSTABLE GALVANIZED STEEL BANDS (4) 2"X4" PT WOOD BRACE SET AT 90°. NAIL (AND DRILL IF NEEDED) TO BATONS AND

SET ROOTBALL 2" ABOVE FINISH GRADE

3" MULCH DEPTH, HOLD 4" CLEAR OF TRUNK 4" HIGH SOIL BERM AROUND ROOTBALL

FINISH GRADE (4) 2"x4"x36" PT WOOD STAKES, INSTALL 2" BELOW FINISH GRADE.

PREPARED PLANTING SOIL - SEE LANDSCAPE NOTES/SPECIFICATIONS COMPACT SOIL UNDER ROOTBALL TO PREVENT


SETTLEMENT

NOTE: - CONTRACTOR TO STAKE LOCATION OF PALMS FOR APPROVAL BY OWNER'S REPRESENTATIVE PRIOR TO INSTALLATION

- CONTRACTOR TO ASSURE PERCOLATION IN ALL PLANTING PITS PRIOR TO INSTALLATION (SEE LANDSCAPE NOTES / SPECIFICATIONS)

- ALL PALMS TO BE SET PLUMB IN PLANTING PIT

PALM STAKING: SPECIMEN PALM

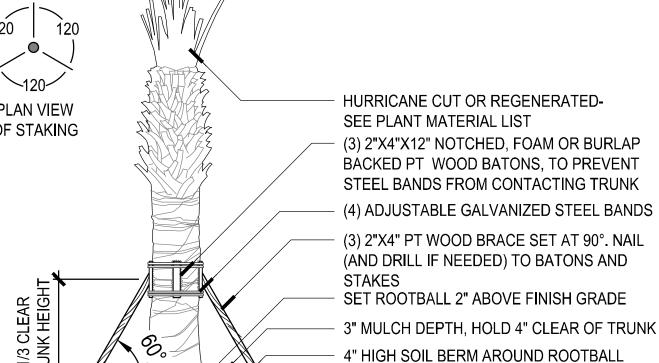


NOTE:

- CONTRACTOR TO STAKE LOCATION OF PALMS FOR APPROVAL BY OWNER'S REPRESENTATIVE PRIOR TO INSTALLATION

- CONTRACTOR TO ASSURE PERCOLATION IN ALL PLANTING PITS PRIOR TO INSTALLATION (SEE LANDSCAPE NOTES / SPECIFICATIONS)

- ALL PALMS TO BE SET PLUMB IN PLANTING PIT

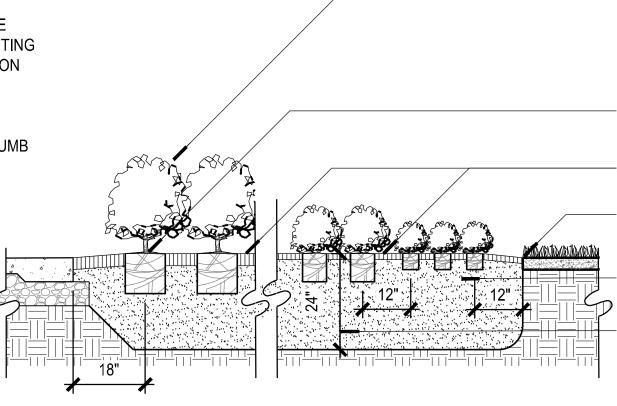

NOTE:

- CONTRACTOR TO DELINEATE OUTLINE OF PLANTING BEDS FOR REVIEW AND APPROVAL BY OWNER'S REPRESENTATIVE.

- CONTRACTOR TO ASSURE PERCOLATION IN ALL PLANTING BEDS PRIOR TO INSTALLATION (SEE LANDSCAPE NOTES / SPECIFICATIONS)

SET ROOTBALL 1" ABOVE FINISH GRADE MULCH-3" DEPTH FOR SHRUBS

1-1/2" DEPTH FOR GROUNDCOVER FINISH GRADE


PREPARED PLANTING SOIL - SEE

LANDSCAPE NOTES / SPECIFICATIONS EXCAVATE / AMEND ENTIRE PLANTING BED TO A MINIMUM DEPTH OF 24" - SEE LANDSCAPE NOTES / SPECIFICATIONS.



USE O.C. SPACING SETBACK FOR LANDSCAPE FROM ALL BUILDING FACES NOTE: **BUILDING FACE** 18" SETBACK FOR SHRUBS AND 12" SETBACK FOR GROUNDCOVERS

FROM CURB, EDGE OF PAVEMENT OR ADJACENT BED LINES CURB OR EDGE OF PAVEMENT

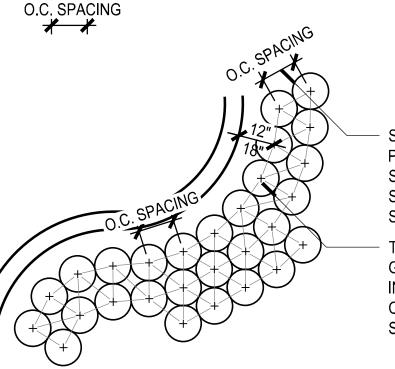

SHRUBS / GROUNDCOVER TO BE PLANTED BASED ON TRIANGULAR SPACING. SEE PLANT SCHEDULE FOR SPECIFIC PLANT ON CENTER (O.C.) SPACING

THE PERIMETER OF SHRUB / GROUNDCOVER BEDS SHALL BE PLANTED IN A ROW AS SHOWN. INTERIOR PORTIONS OF BEDS SHALL BE PLANTED AT THE SPECIFIED O.C. TRIANGULAR SPACING.

- CONTRACTOR TO DELINEATE OUTLINE OF PLANTING BEDS FOR REVIEW AND APPROVAL BY OWNER'S REPRESENTATIVE.

- CONTRACTOR TO ASSURE PERCOLATION IN ALL PLANTING BEDS PRIOR TO INSTALLATION (SEE LANDSCAPE NOTES / SPECIFICATIONS)



Project Phase

າesigned By

Project Number

Approved / Checked By

Drawn By

SHORELINE SUBMITTAL

PLANTING DETAILS

Sheet Number

L6-2-02

SABAL PALM STAKING

SHRUB GROUNDCOVER SPACING SCALE - NTS

SHRUB GROUNDCOVER SPACING PLAN

SCALE - NTS

(3) 2"x4"x36" PT WOOD STAKES, INSTALL 2"

COMPACT SOIL UNDER ROOTBALL TO

PREPARED PLANTING SOIL - SEE LANDSCAPE

FINISH GRADE

BELOW FINISH GRADE.

NOTES/SPECIFICATIONS

PREVENT SETTLEMENT

SCALE - NTS

ORIGINAL TITLE BLOCK DRAWN AT 24"x36" (Arch D)

TREES



GUMBO LIMBO

Bursera simaruba





BRIDAL VEIL TREE Caesalpinia granadilo

GREEN BUTTONWOOD Conocarpus erectus





Ligustrum lucidum



SOUTHER LIVE OAK Quercus virginiana

Lagerstroemia indica

PALMS



Roystonea regia



Thrinax radiata



SHRUBS


SYLVESTER DATE

Phoenix sylvester







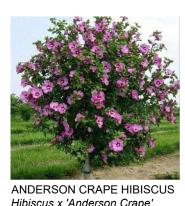



Brunfelsia grandiflora



Chrysobalanus icaco 'Horizontalis' Duranta erecta 'Gold Mound'





Ficus microcarpa













PLANT SCHEDULE								
SYMBOL	CODE	QTY	BOTANICAL NAME	COMMON NAME	CONT	SIZE	ORIGIN	CAL
TREES								
•	BS	10	Bursera simaruba	Gumbo Limbo	F.G.	14` HT. X 5` SPR. SINGLE TRUNK, FULL	Native	4"-5"
£	CG2	3	Caesalpinia granadillo	Bridal Veil Tree	F.G.	14` Ht. x 6` Sprd.	Non-native	
+	CE	2	Conocarpus erectus	Green Buttonwood	F.G.	16` HT, 6` SPR. SINGLE	Native	6"-8"
	LI	4	Lagerstroemia indica	Crape Myrtle	Triple Trunk	12` Hgt. x 5` Spd.	Non-native	3"-4"
3.0	LL	14	Ligustrum lucidum	Glossy Privet	Triple Trunk	12` Hgt. x 5` Spd.	Non-native	3"-4"
•	QV	6	Quercus virginiana	Southern Live Oak	F.G.	16` HT, 6` SPR. SINGLE	Native	6"-8"
PALMS		1	1					1
	PSX	13	Phoenix sylvester	Sylvester Date Palm	F.G.	25` HT, 7` GW MIN.	Non-native	
	ROX	23	Roystonea regia	Royal Palm	F.G.	25`-28` O.A.	Native	
2	TRX	14	Thrinax radiata	Florida Thatch Palm	Triple Trunk	10` Hgt. x 5` Spd.	Native	
•	VOX	13	Veitchia montgomeryana	Montgomery Palm	FG	14`-16` O.A. HT	Non-native	

PLANT SC	HEDULE							
YMBOL	CODE	QTY	BOTANICAL NAME	COMMON NAME	CONT	SIZE	SPACE	ORIGIN
HRUBS	Γ				T			
•	AB	15	Aechmea blanchetiana	Orange Bromeliad	7 gal	3` Ht. / full	30" O.C.	Non-Native
\bigcirc	CR2	5	Cordyline fruticosa 'Red Sister'	Red Sister Ti Plant	7 gal	4` O.A.	30" O.C.	Non-Native
•	CQ	2	Crinum augustum 'Queen Emma'	Queen Emma Crinum Lily	7 gal	3` Ht. / full	36" O.C.	Non-Native
+	НА	2	Hibiscus x 'Anderson Crape'	Anderson Crape Hibiscus	15 gal	6` Ht		Non-Native
SYMBOL	CODE	QTY	BOTANICAL NAME	COMMON NAME	CONT.	SIZE	SPACE	ORIGIN
HRUB AR	REAS	<u> </u>		I				
	BRU	113	Brunfelsia grandiflora	Yesterday, Today, and Tomorrow	3 gal	18" HT X 18" SPD	18" O.C.	Non-Native
	СНН	34	Chrysobalanus icaco 'Horizontalis'	Horizontal Coco Plum	3 gal	18" HT, 18" SPR	18" O.C.	Native
	DUE	231	Duranta erecta 'Gold Mound'	Gold Mound Dewdrops	3 gal	18" HT X 18" SPD	18" O.C.	Non-Native
	FIM	2 569	Ficus microcarpa 'Green Island'	Green Island Ficus	3 gal	16" HT	15" O.C.	Non-Native
	FIP	27	Ficus pumila	Creeping Fig	1 gal	24" Ht/Support	12" O.C.	Non-Native
	LIR	861	Liriope Muscari 'Evergreen Giant'	Evergreen Giant Border Grass	3 gal	16" HT	15" O.C.	Non-Native
	MUH	154	Muhlenbergia capillaris	Pink Muhly Grass	7 gal	36"HT x 30"SPRD	30" O.C.	Native
	PHS	329	Philodendron selloum	Selloum Philodendron	3 gal	3` Ht x 30" Spr	36 " O.C.	Non-Native
	SCA-2	96	Schefflera arboricola 'Trinette'	Trinette Variegated Schefflera	3 gal	24" HT, 24" SPR	24" O.C.	Non-Native
	ZAF	66	Zamia furfuracea	Cardboard Palm	7 gal	30" HT x 24" SP - FULL	24" O.C.	Native

ISLE OF DREAMS

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PLANNING LANDSCAPE ARCHITECTURE URBAN DESIGN

1512 E. BROWARD BOULEVARD, SUITE 110 FORT LAUDERDALE, FLORIDA 33301 USA TEL: 954.524.3330

Consultants:

Rev Date Issued for

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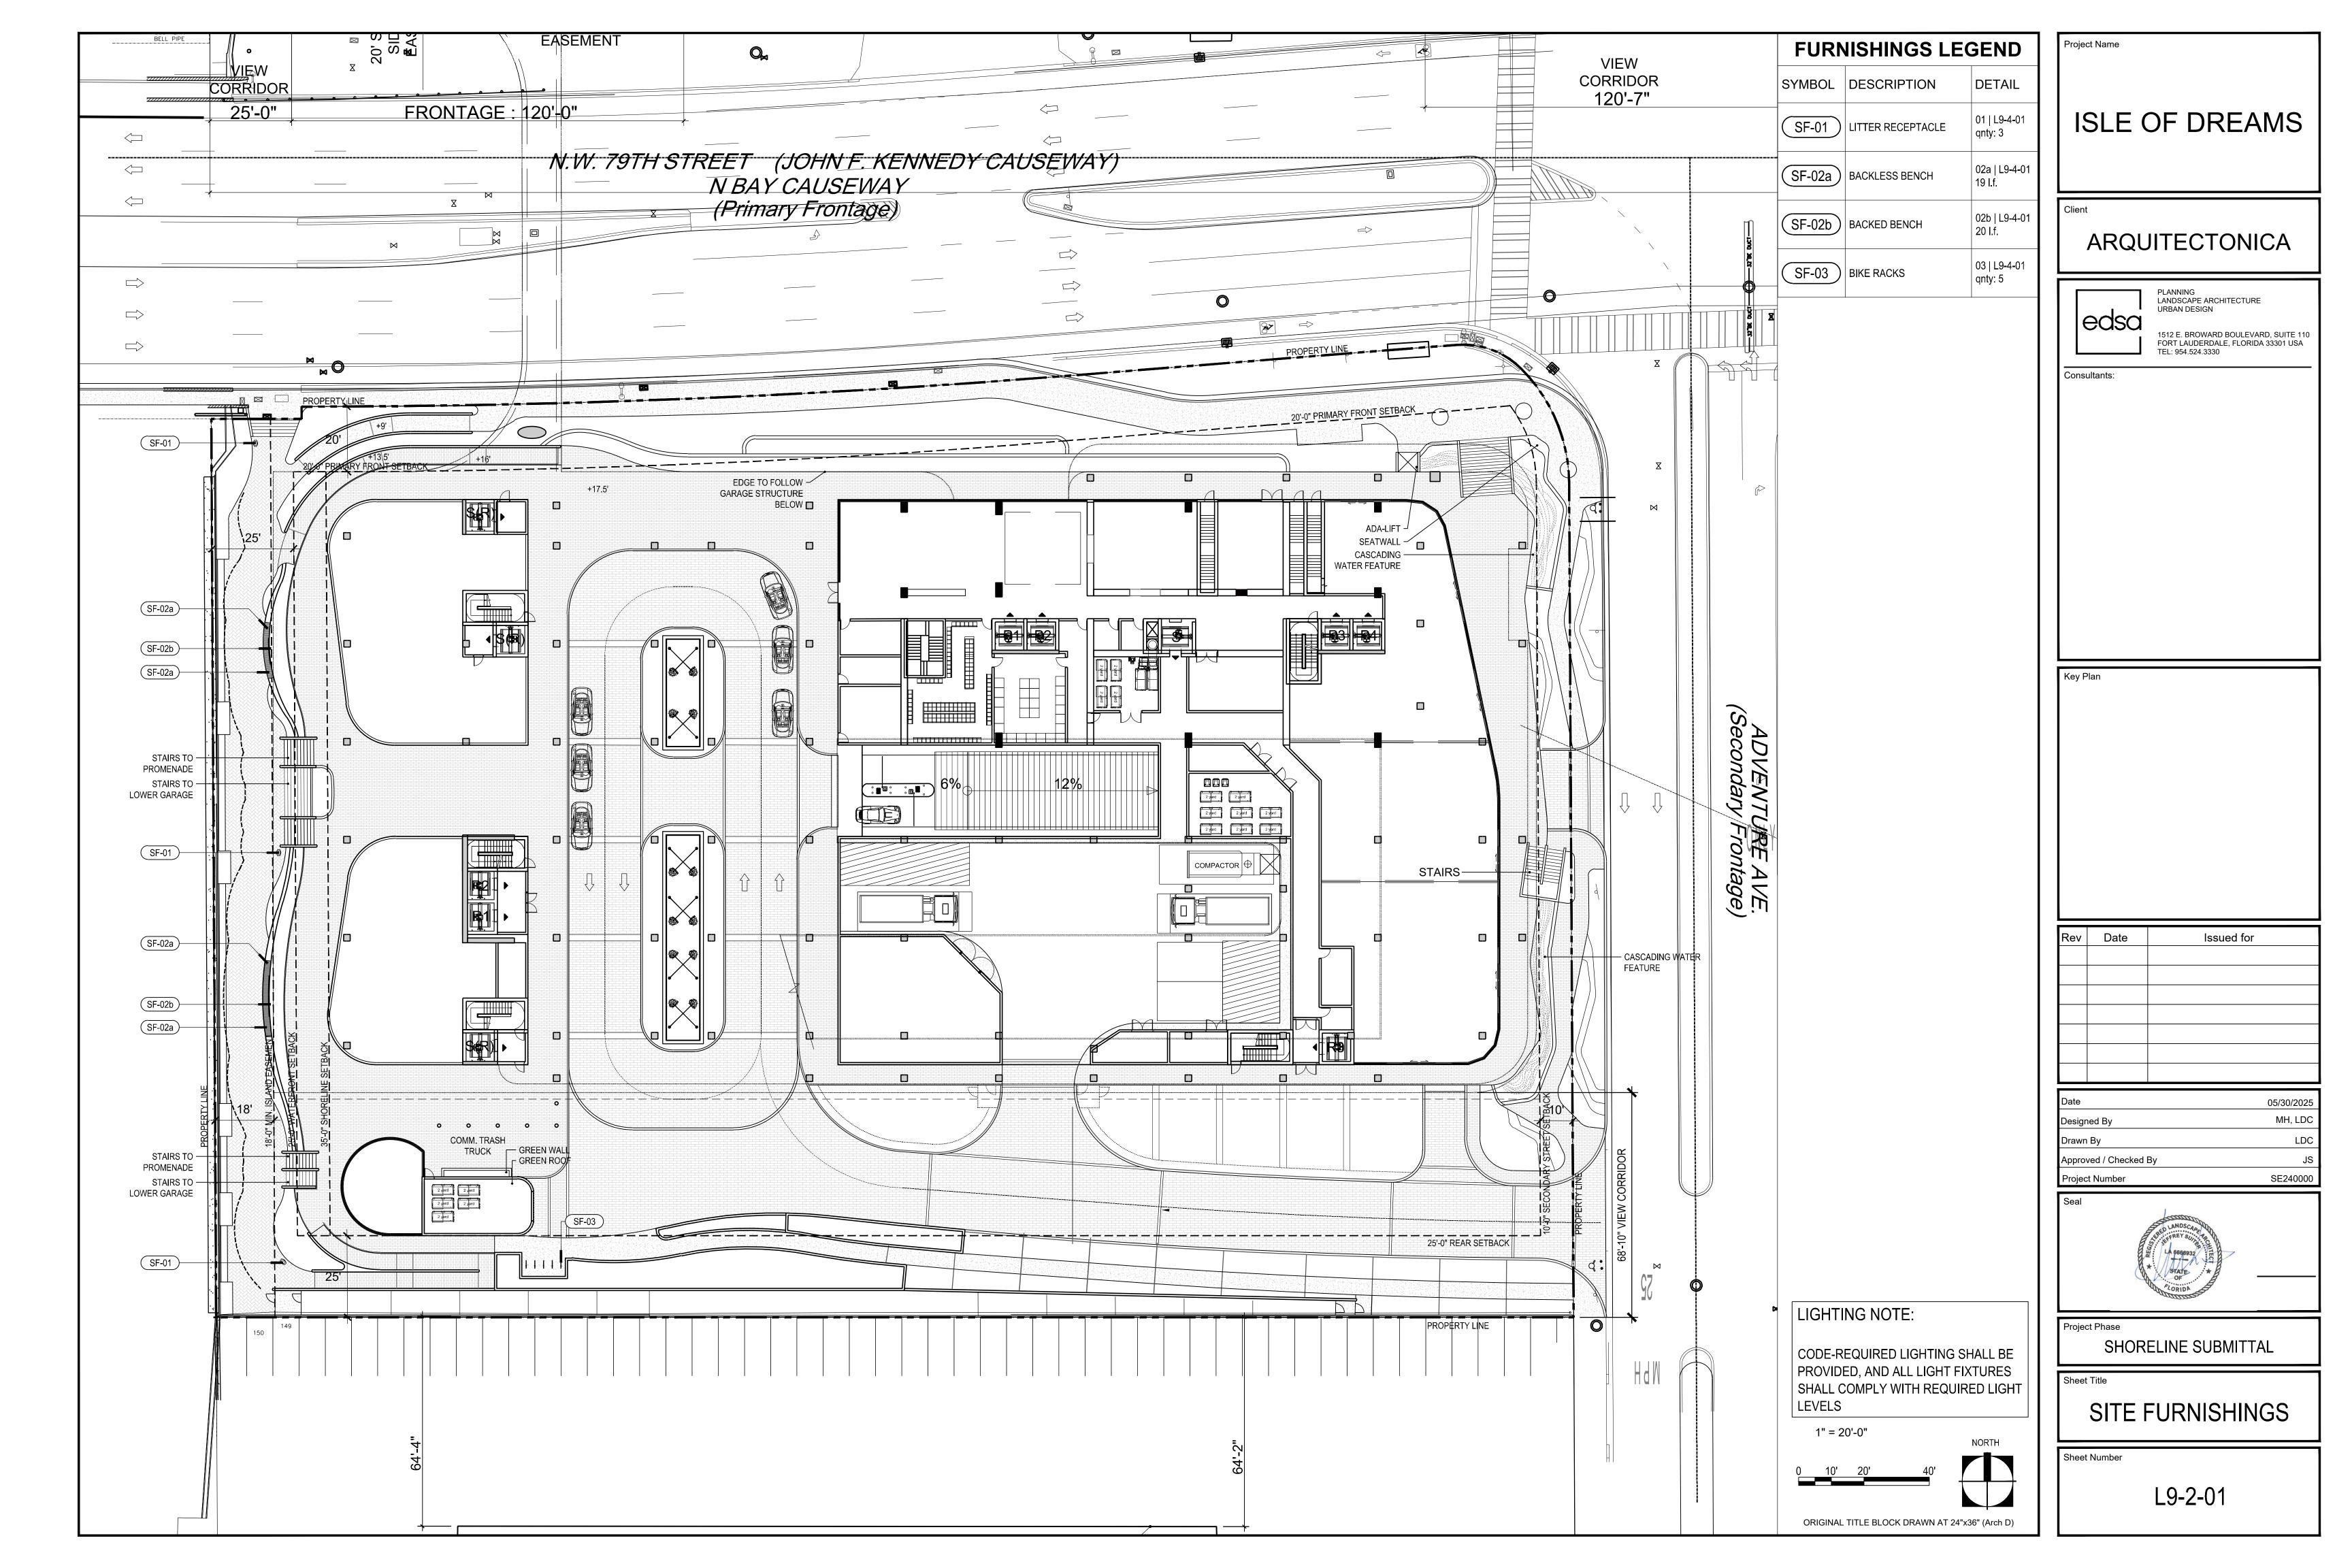



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LANDSCAPE IMAGE BOARD

Sheet Number

L6-3-01



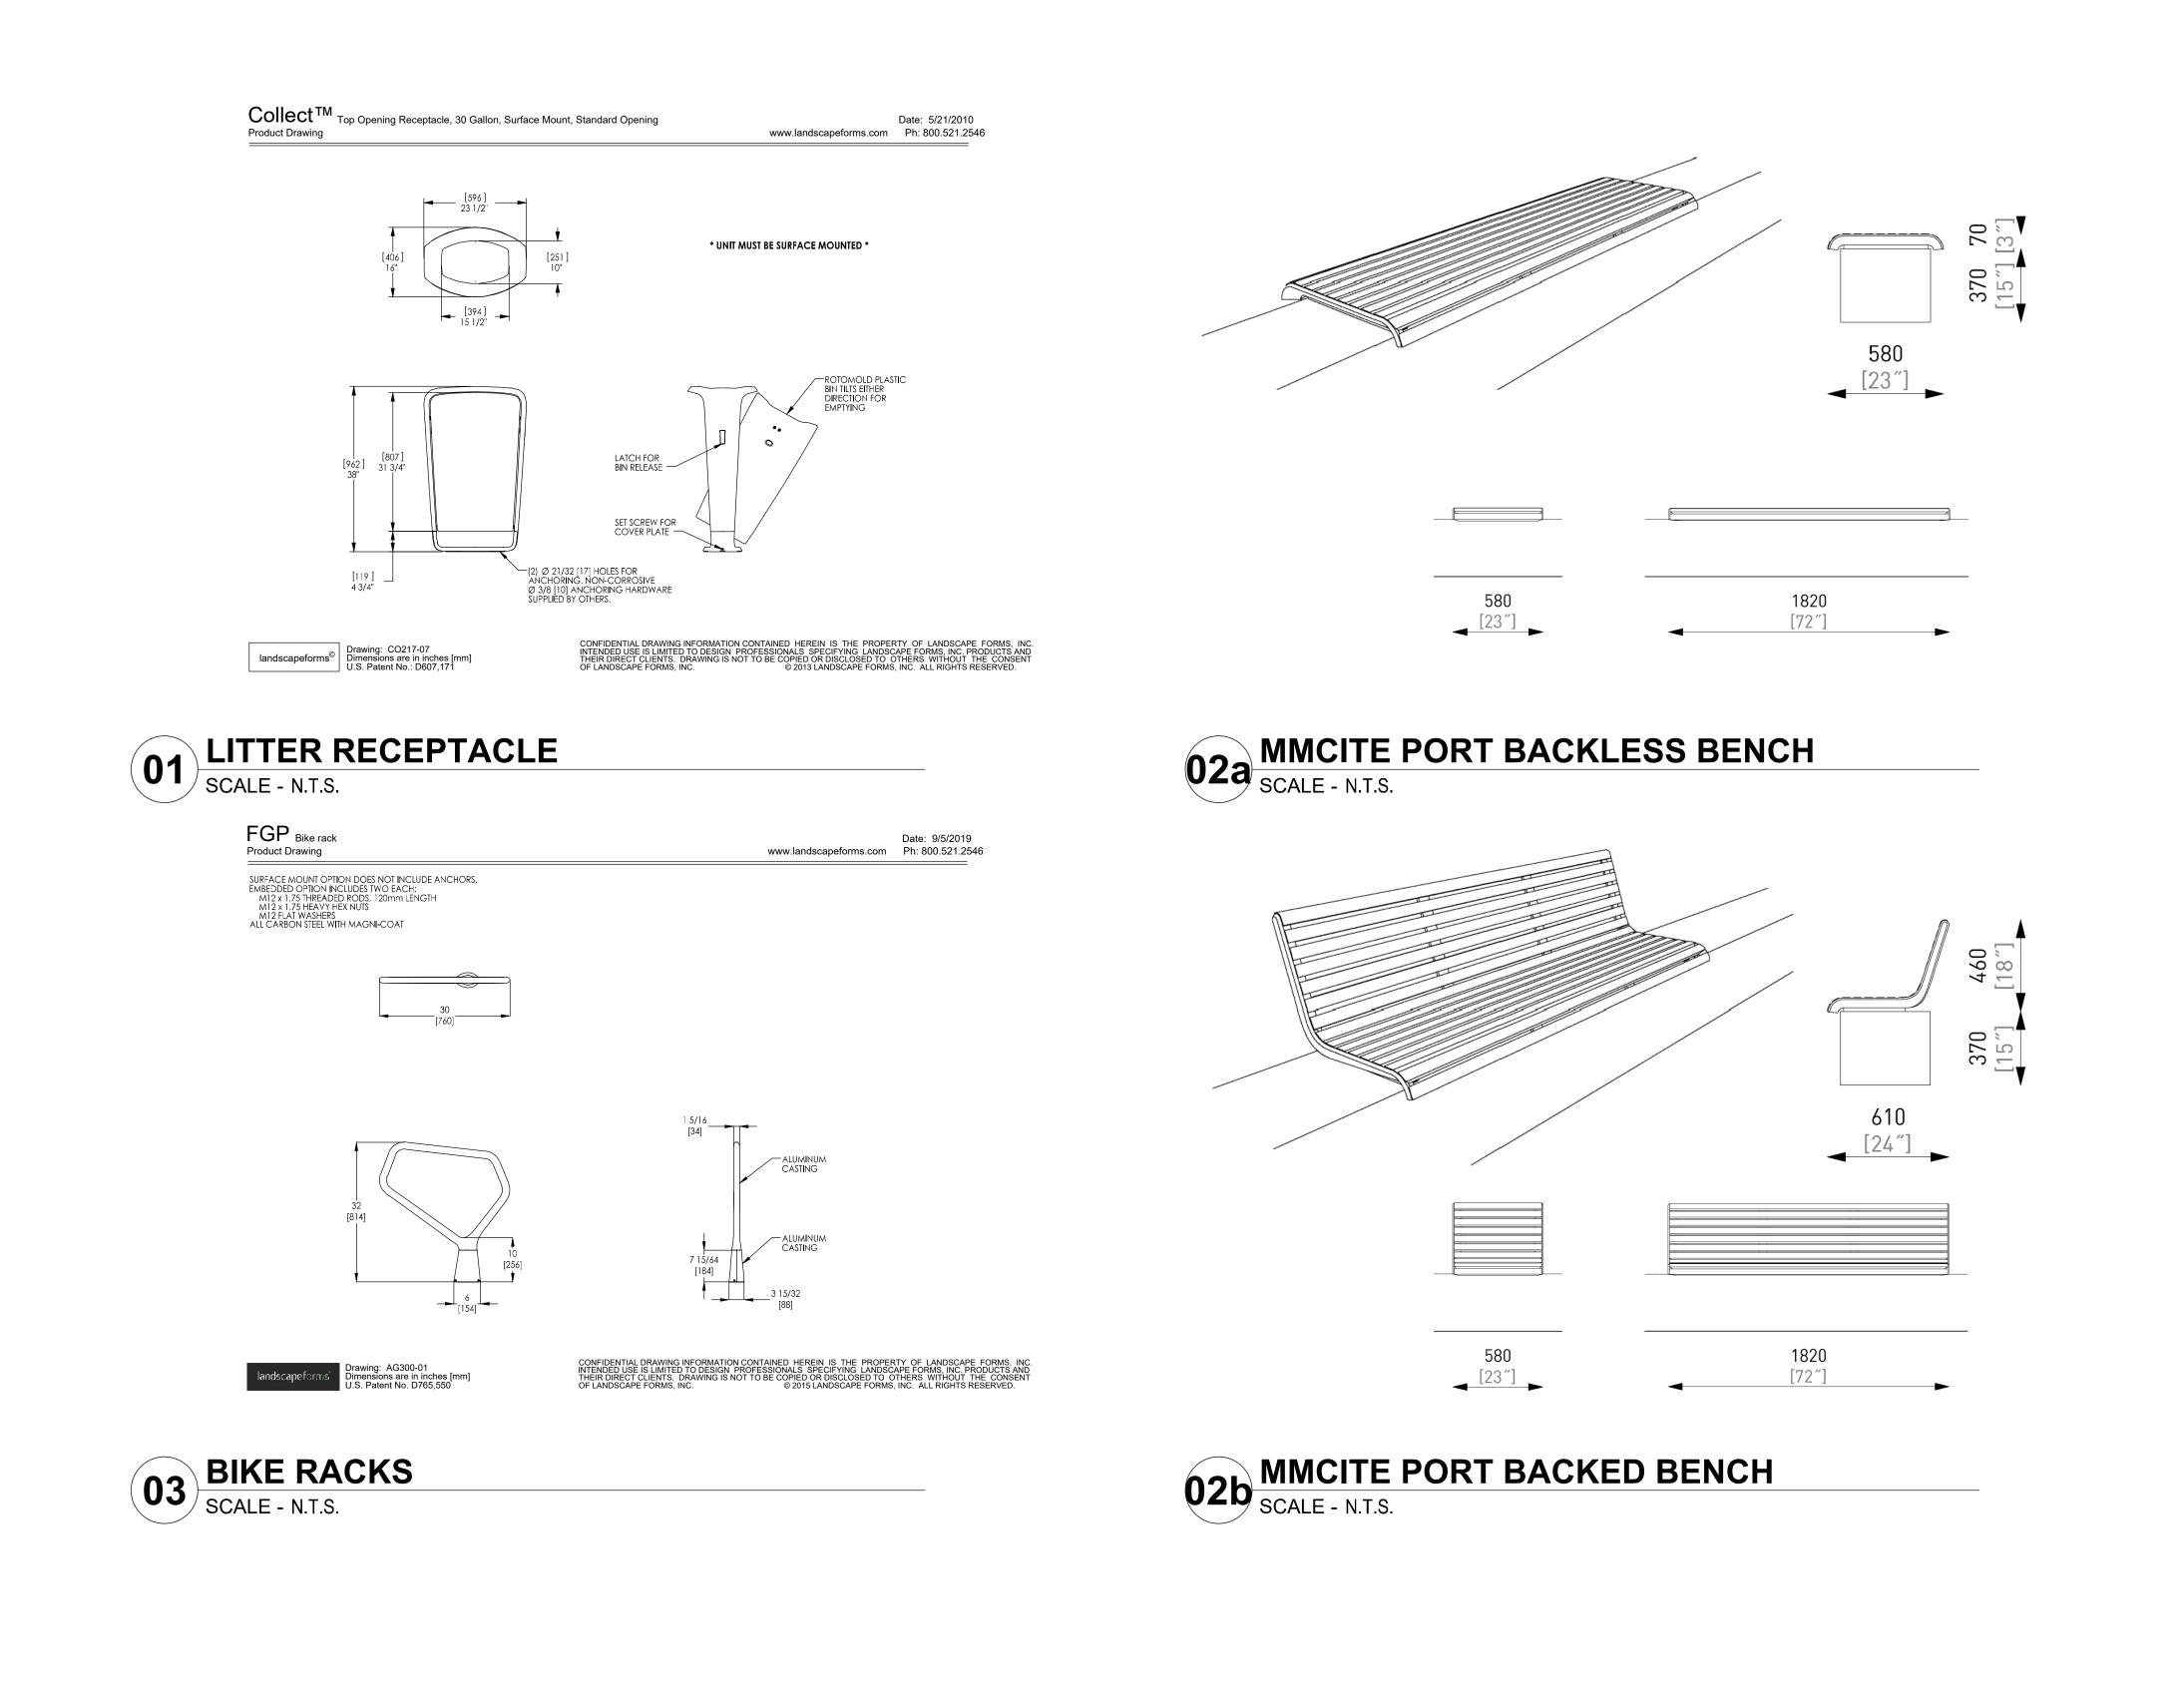

FURN	SEND	
SYMBOL	DESCRIPTION	DETAIL
SF-01	LITTER RECEPTACLE	01 L9-4-01 qnty: 3
SF-02a	BACKLESS BENCH	02a L9-4-01 19 l.f.
SF-02b	BACKED BENCH	02b L9-4-01 20 l.f.
SF-03	BIKE RACKS	03 L9-4-01 qnty: 5

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SITE FURNITURE CUTSHEETS

Sheet Number

L9-4-01

ORIGINAL TITLE BLOCK DRAWN AT 24"x36" (Arch D)

CODE-REQUIRED LIGHTING SHALL BE PROVIDED, AND ALL LIGHT FIXTURES

SHALL COMPLY WITH REQUIRED LIGHT

LIGHTING NOTE:

LEVELS

		·
PROJECT DESIGN INFORMATION		
Length of Primary Bay Frontage	(ft.)	275'
Length of Any Secondary Bay Frontage(s)	(ft.)	N/A
Width (Depth) of Property	(ft.)	415'-6"
Number of Stories	(no.)	39
Total Height (MHWL to top of parapet)	(ft.)	494'-3"
Maximum Density Allowed by Zoning	(Units per Acre)	150 du/acre
Density Proposed	(Units per Acre)	90 du/acre
Number of Residential Units	(no.)	246
Leasable Commercial Space	(sq.ft.)	23,043 sf
Number of Parking Floors	(no.)	7
Does garage have liner units along shoreline?	(Y/N)	Yes
Lot Coverage	(%)	118,490 sq.ft.
Paved Area	(%)	52,685 sq.ft. (44%)
Landscaped Area	(%)	18,720 sq.ft. (16%)

Mia	ami-Dade County Code Sec. 33-D Compliance:		
(re	quired for Site Plan Review applications only)	Provided	Required
•	Shoreline Setback (setback from wet face of seawall to nearest edge of building)	35'	25' to 75' Min.
•	North Setback (setback from nearest edge of building to property line)	29'-39'	25' Min.
•	South Setback (setback from nearest edge of building to property line)	68'	25' Min.
•	East Setback (setback from nearest edge of building to property line)	13'	N/A
•	Visual Corridor (to be provided on one side of development)	68' width	25% of site width

Podium Setbacks:

WEST: 25' Waterfront Setback | Island Walk NORTH: 20' Primary Front Setback EAST: 10' Secondary Street Setback SOUTH: 25' Rear Setback

Project Na

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PLANNING LANDSCAPE ARCHITECTURE URBAN DESIGN

1512 E. BROWARD BOULEVARD, SUITE 110 FORT LAUDERDALE, FLORIDA 33301 USA TEL: 954.524.3330

Consultants:

Key Plan

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Drawn By LDC

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Project Number SE240000

STATE OF LORIDA

Project Phase


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Sheet Title

PROJECT DATA TABLE

Sheet Number

L10-0-00

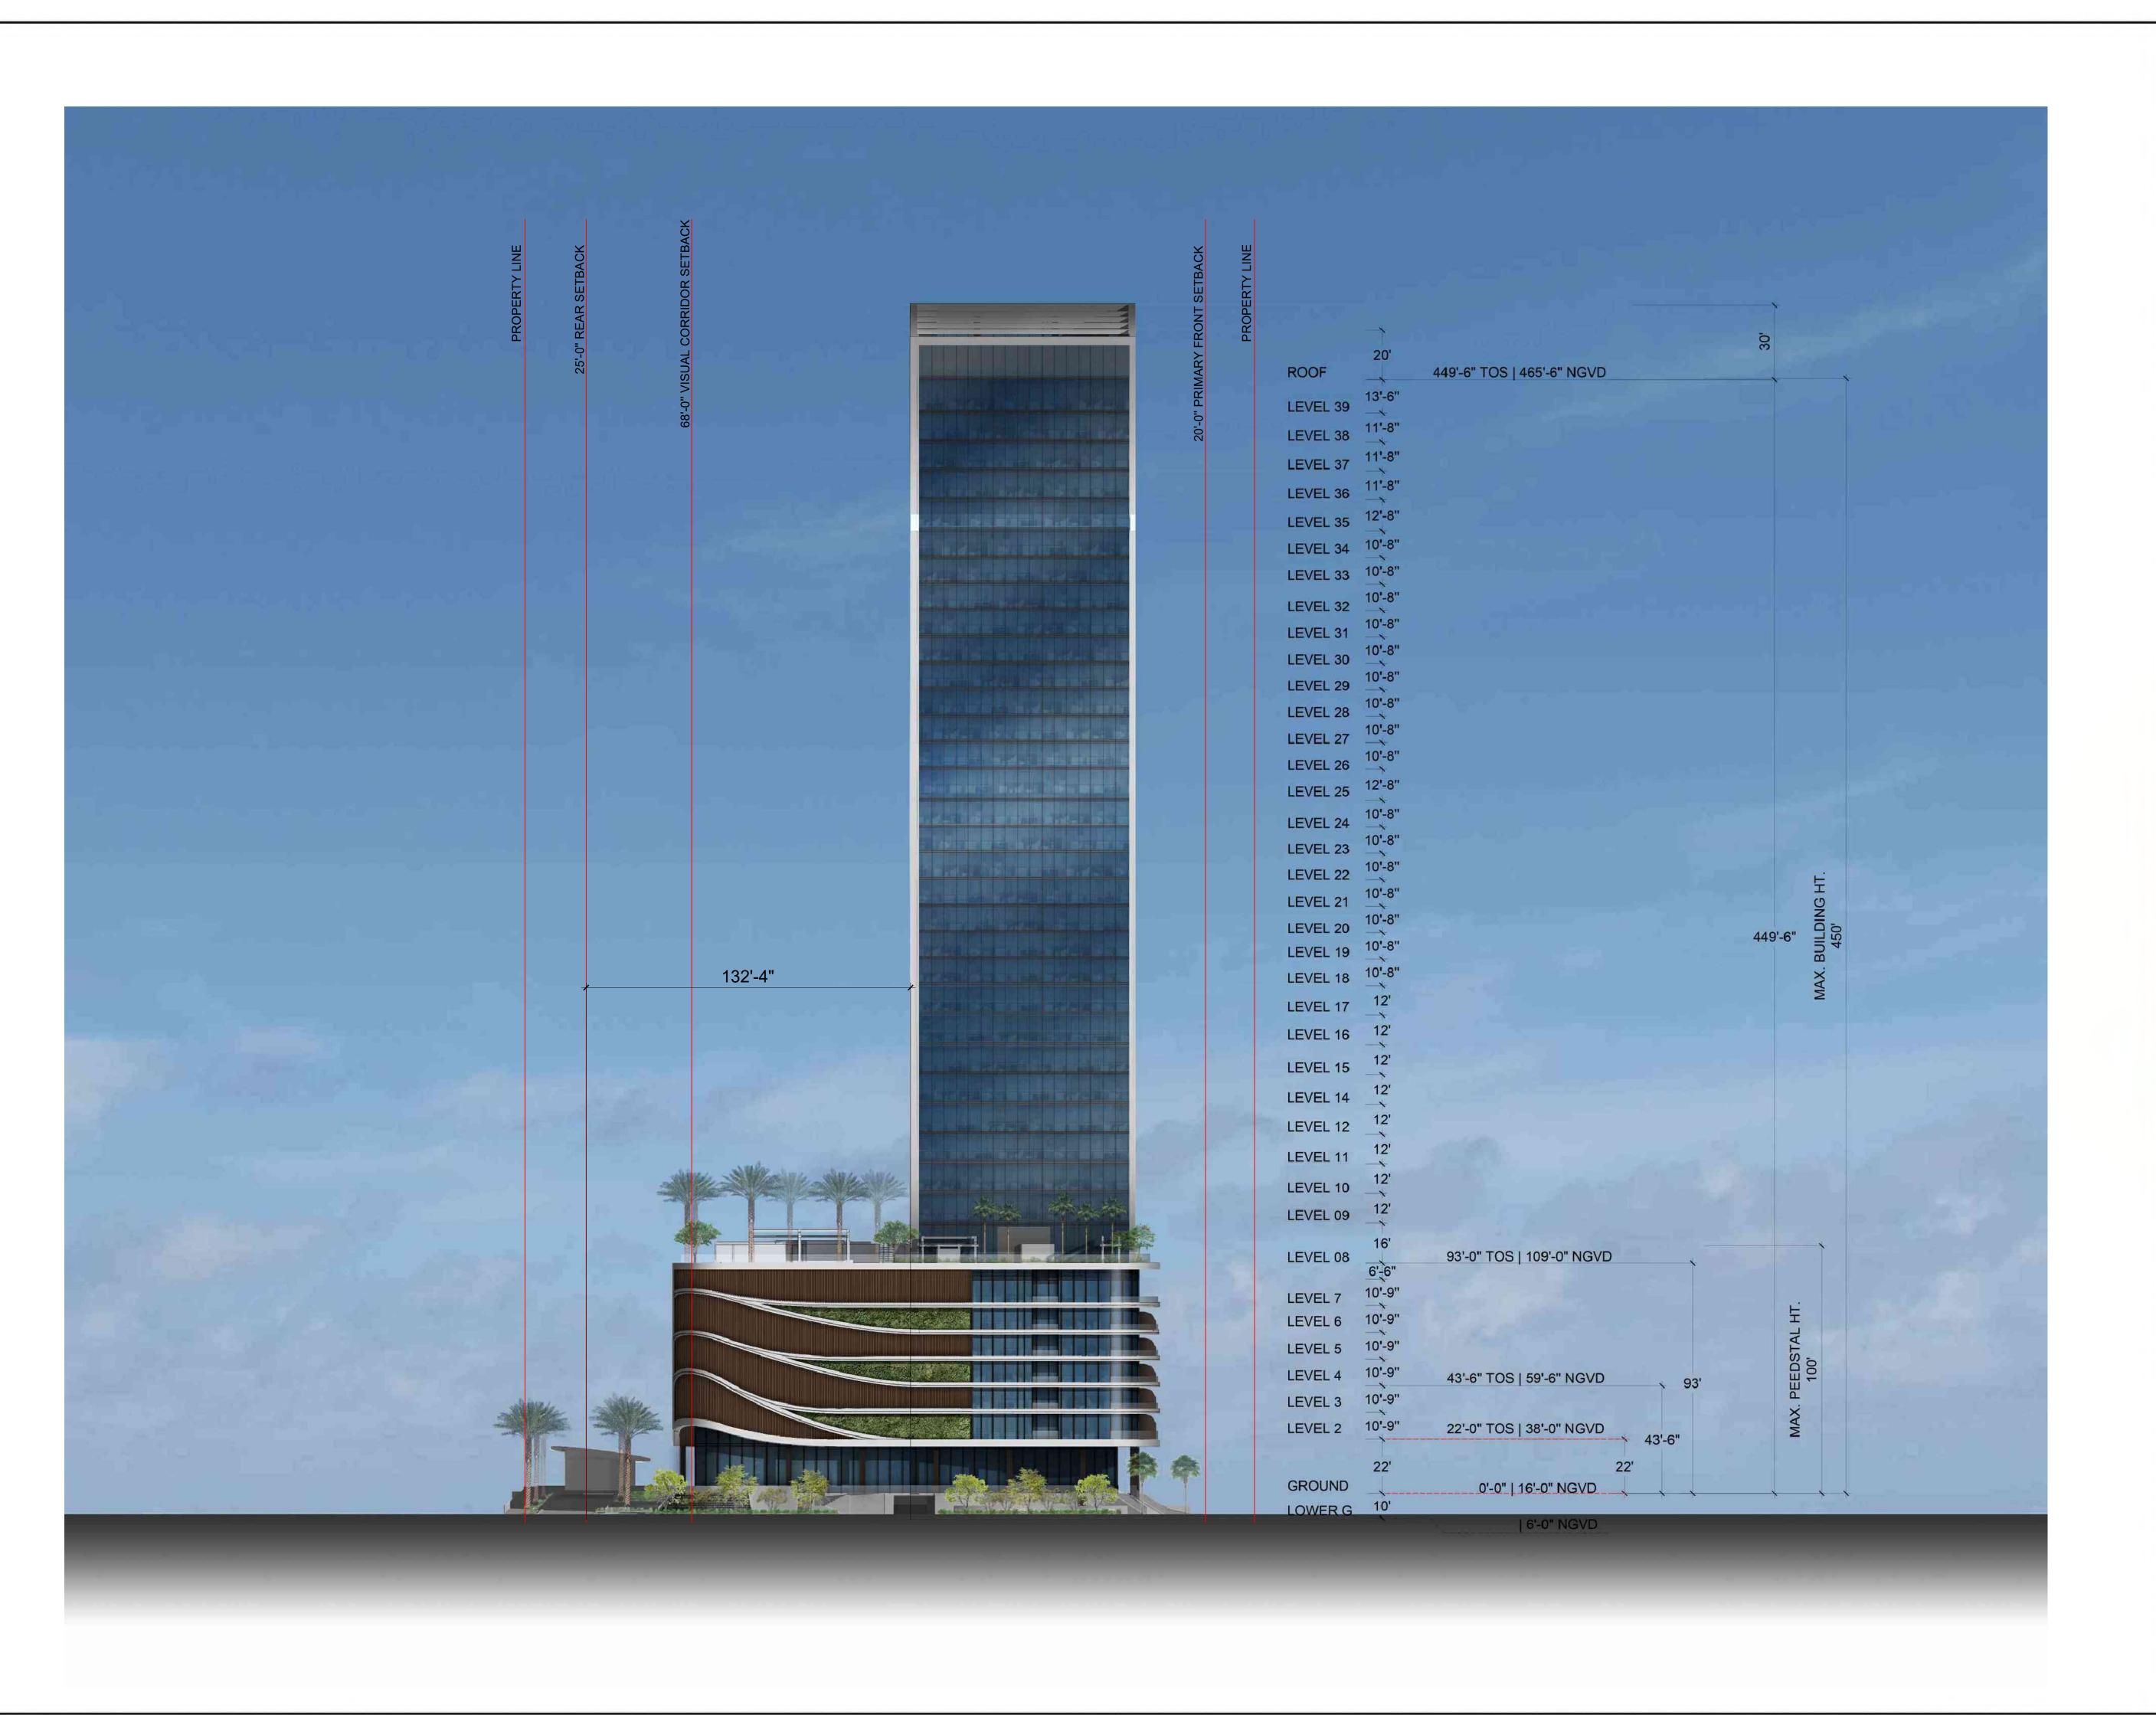

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PLANNING LANDSCAPE ARCHITECTURE URBAN DESIGN

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Project Phase
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EAST ELEVATION

Sheet Number



Project Name

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Project Phase

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NORTH ELEVATION

Sheet Number



Project Name

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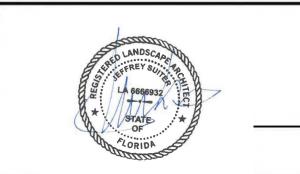
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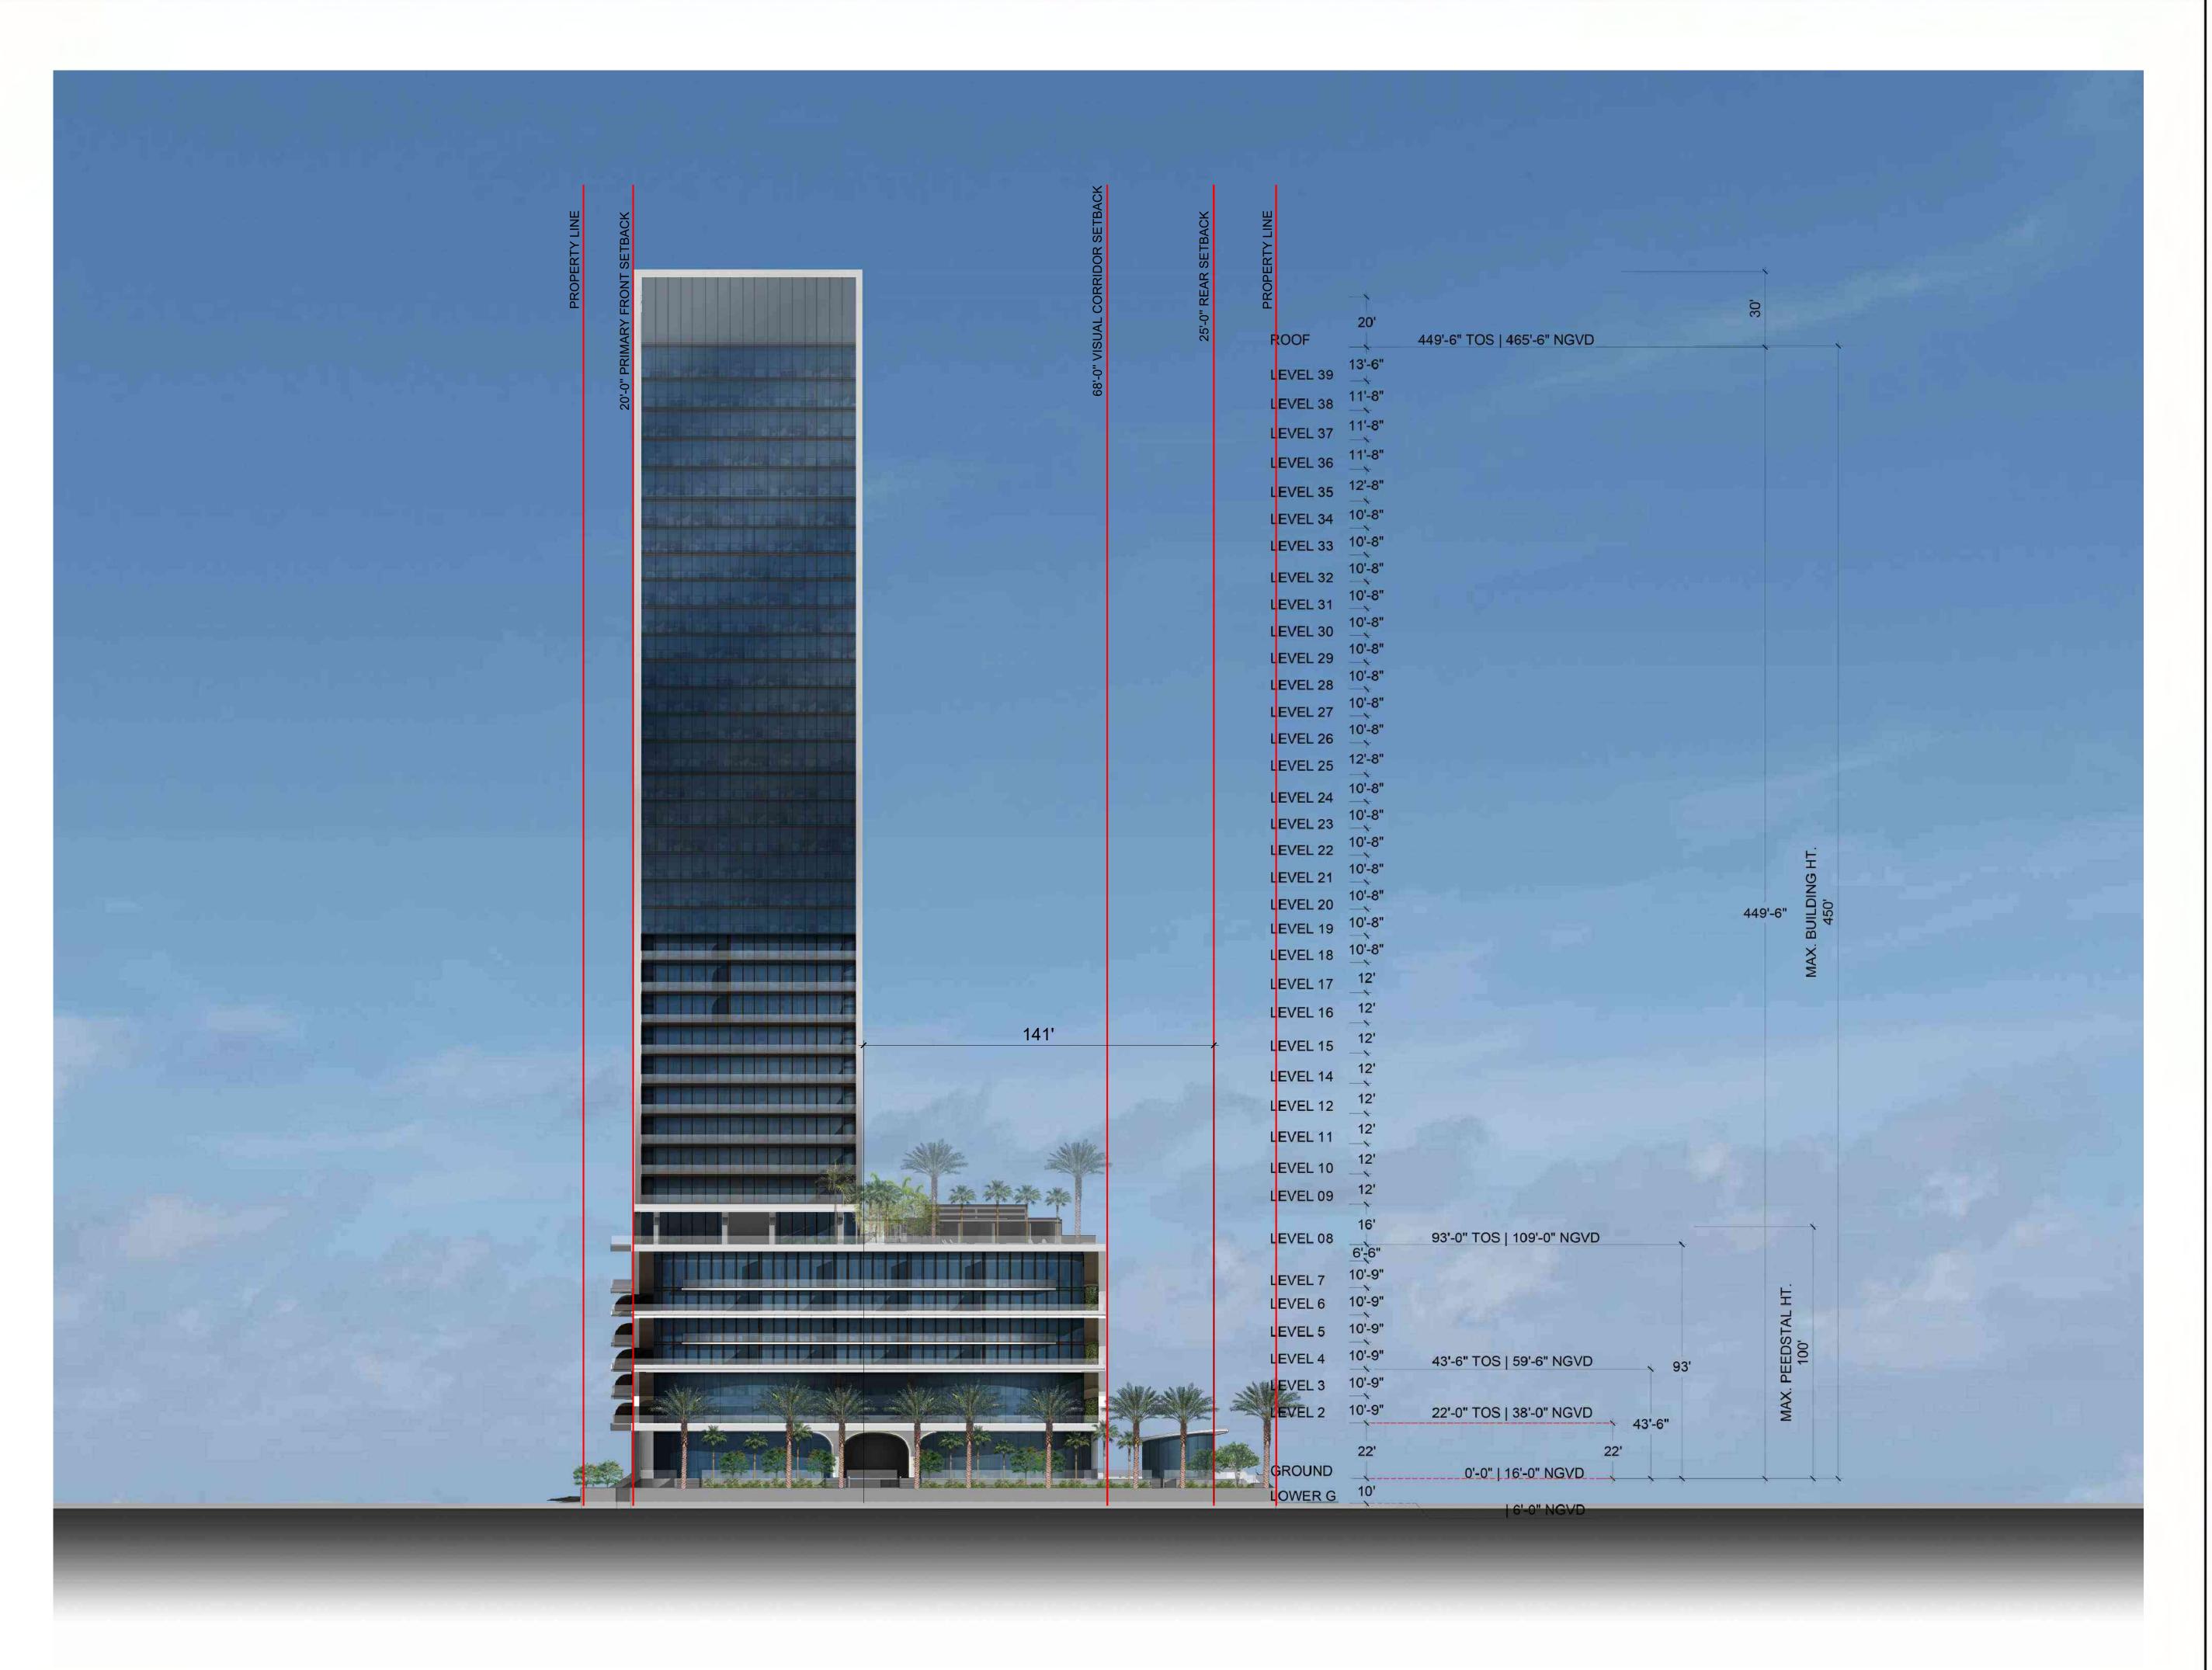
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SHORELINE SUBMITTAL

SOUTH ELEVATION

Sheet Number



Project Name

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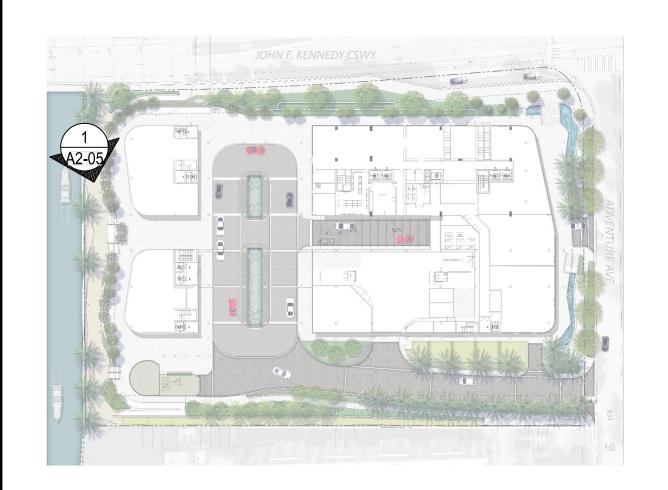
Project Phase

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Shoot Title

WEST ELEVATION

Sheet Number



KEY MAP | N.T.S.



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Project Phase
SHORELINE SUBMITTAL

Shoot Title

ORIGINAL TITLE BLOCK DRAWN AT 24"x36" (Arch D)

BAYWALK PERSPECTIVE

Sheet Number

A2-05

WATERFRONT PED. PROMENADE SECTION

SCALE - 1/4" = 1'-0"