


2300 BROADWAY Redwood City, CA

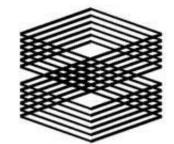

TISHMAN SPEYER

PLANNING APPLICATION #2 10/22/2021

0 BRO	ADWAY		
Redwood City, CA Tishman Speyer			
PROJECT NO.: 19046.00	AHJ #	ISSUES	DATE
		PLANNING APPLICATION PLANNING APPLICATION #2	03/03/2021 10/22/2021
COVER		A REVISION LIST	DATE
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TH FLOOR, STE. 402	AN FRANCISCO	ALIFORNIA 94107	:15.489.2224 TEL	15.358.9100 FAX	WWW.WRNSSTUDIO.COM
4 4	SA	CA	415	415	₹
	4TH FLOOR, STE. 402	4TH FLOOR, STE. 402 SAN FRANCISCO	4TH FLOOR, STE. 402 SAN FRANCISCO CALIFORNIA 94107	4TH FLOOR, STE. 402 SAN FRANCISCO CALIFORNIA 94107 415.489.2224 TEL	4TH FLOOR, STE. 402 SAN FRANCISCO CALIFORNIA 94107 415.489.2224 TEL 415.358.9100 FAX

ENTITLEMENTS / PERMITS REQUESTED

1. PLANNED COMMUNITY (PC) PERMIT FOR NEW OFFICE DEVELOPMENT 2. AMENDMENTS TO THE 2018 REVISED DOWNTOWN PRECISE PLAN SECTION 2.5.2.A SECTION 2.5.2.E SECTION 2.7.3.A

3. TENTATIVE MAP FOR RECONFIGURATION OF EXISTINGS LOTS AND STREET GRID

DEFERRED PERMITS

1. EXTERIOR SIGNAGE 2. INTERNAL FIRE SPRINKLER / STANDPIPE LAYOUT & CALCULATIONS WITH SAID CALIFORNIA CODE OF REGULATIONS TITLE 24, A CHANGE ORDER DETAILING AND JURISDICTION BEFORE PROCEEDING WITH THE WORK. PARTIAL LIST OF APPLICABLE CODES AS OF 03/05/21

2019 BUILDING STANDARDS ADMINISTRATIVE CODE, PART 1, TITLE 24 CCR

2019 CALIFORNIA BUILDING CODE (CBC), PART 2, TITLE 24 CCR

2019 CALIFORNIA ELECTRICAL CODE (CEC), PART 3, TITLE 24 CCR

2019 CALIFORNIA MECHANICAL CODE (CMC), PART 4, TITLE 24 CCR 2019 CALIFORNIA PLUMBING CODE (CPC), PART 5, TITLE 24 CCR

2019 CALIFORNIA ENERGY CODE, PART 6, TITLE 24 CCR

2019 CALIFORNIA FIRE CODE, PART 9, TITLE 24 CCR


2019 CA GREEN BUILDING STANDARDS CODE (CAL GREEN), PART 11, TITLE 24 CCR 2019 CALIFORNIA REFERENCE STANDARDS, PART 12, TITLE 24 CCR

TITLE 19 CCR, PUBLIC SAFETY, STATE FIRE MARSHAL REGULATIONS


NFPA 13 AUTOMATIC SPRINKLER SYSTEMS W/ CA AI NFPA 14 STANDPIPE SYSTEMS W/ CA AMENDMENTS NFPA 17A WET CHEMICAL SYSTEMS	V/ CA AMENDMENTS MS / CA AMENDMENTS DOE W/ CA AMENDMENT
NFPA 20STATIONARY PUMPSNFPA 24PRIVATE FIRE MAINS W/ CA AMENDMENTSNFPA 72NATIONAL FIRE ALARM DOE W/ CA AMENDMNFPA 2001CLEAN AGENT FIRE EXTINGUISHING SYSTEW/ CA AMENDMENTS	INGUISHING SYSTEMS

REDWOOD CITY MUNICIPAL CODE 2011.01.24 DOWNTOWN PRECISE PLAN (REVISED JUNE 11,2018)

VICINITY MAP

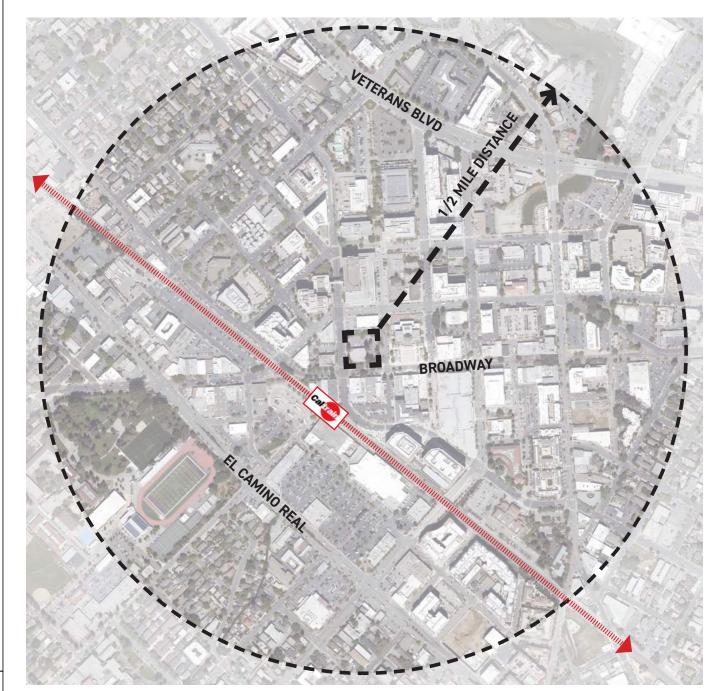

LOCATION MAP

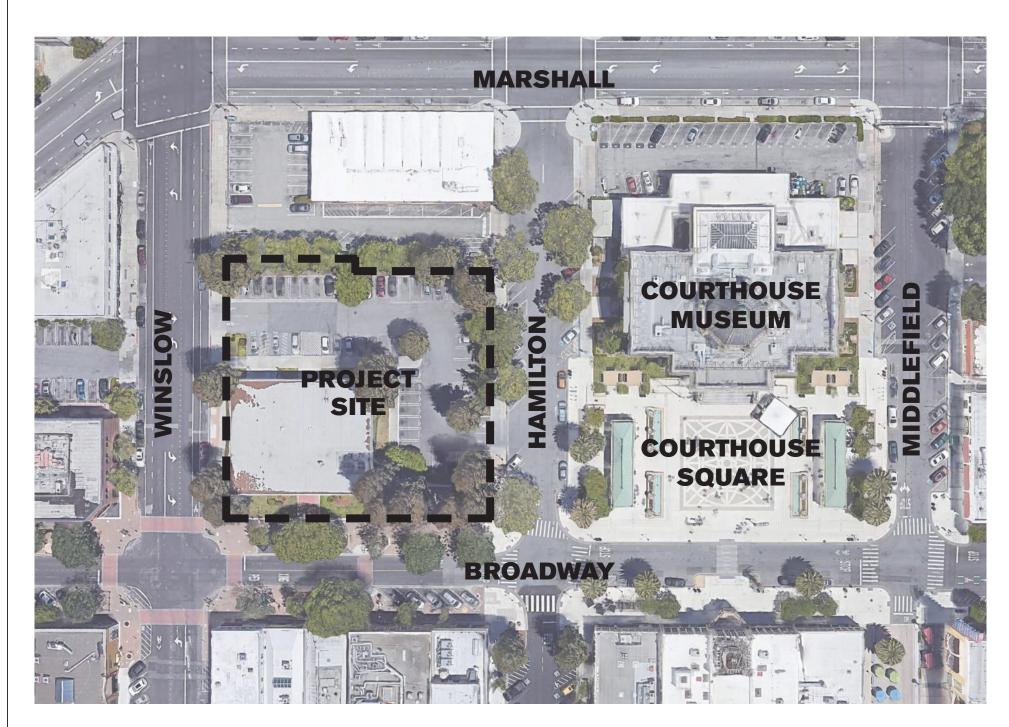

10/24/2021 10:06:27

APPLICABLE CODES & AGENCIES

THE INTENT OF THE DRAWINGS AND SPECIFICATIONS IS TO CONSTRUCT REFERENCED PROJECT IN ACCORDANCE WITH CALIFORNIA CODE OF REGULATIONS TITLE 24. SHOULD ANY CONDITION DEVELOP NOT COVERED BY THE CONTRACT DOCUMENTS WHEREIN THE FINISHED WORK WILL NOT COMPLY SPECIFYING THE REQUIRED WORK SHALL BE SUBMITTED TO AND APPROVED BY THE AGENCY HAVING

MS W/ CA AMENDMENTS

ENDMENTS NDMENTS CA AMENDMENTS

2016 EDITION 2016 EDITION 2016 EDITION 2016 EDITION 2016 EDITION 2016 EDITION

2016 EDITION

PROJECT DIRECTORY

APPLICANT

TISHMAN SPEYER ONE BUSH PLAZA, 1 BUSH ST SUITE 500 SAN FRANCISCO, CA 94104 CONTACT: HENRY SEARS 415-297-2834

ARCHITECT

WRNS STUDIO 501 SECOND STREET SUITE 402 SAN FRANCISCO, CA 94107 CONTACT: BRIAN MILMAN 415-489-2224

LANDSCAPE

GLS LANDSCAPE/ARCHITECTURE 2677 MISSION STREET #200 SAN FRANCISCO, CA 94110 GARY STRANG 415-285-3614

CIVIL

BKF ENGINEERS 255 SHORELINE DRIVE SUITE 200 REDWOOD CITY, CA 94065 JAMES DALLOSTA 650-482-6414

All drawings and written material appearing herein constitute original and unpublished work of the Architect/Engineer and may not be duplicated, used or disclosed without consent of Architect/Engineer.

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415.358.9100 FAX WWW.WRNSSTUDIO.COM	
ISSUES PLANNING APPLICATION PLANNING APPLICATION #2	03/ 10/
# REVISION LIST	
	VAY

PROJECT NO.: 19046.00 DATE: 10/22/2021 SCALE:

SHEET TITLE:

DRAWING INDEX, PROJECT DIRECTORY

SHEET NO:

If this drawing is not 24"x36", then the drawing has been revised from its original size. Noted scales must be adjusted. This line should be equal to one inch

PROJECT INFO

PROJECT SUMMARY

Commercial development at 2300 Broadway, also known as the Chase application is based on initial feedback we have received over the cour meetings with community members who are invested in and care deep Redwood City. Three common themes from this outreach have informe

New Public Green Space & Enhanced Redwood Grove Given its adjacency to the Courthouse Square, 2300 Broadway preser

placemaking opportunity that can expand on the incredible success of t partnering with the City to create over 20,000 square feet of public gree the Square that can preserve and enhance the grove of Redwood trees Broadway. This space can be complimented by active uses and public our building.

With other pedestrian improvements underway, Hamilton Street has the pedestrian throughfare linking CalTrain to Courthouse Square, County Redwood City to the North. With further improvement, it has the potenti network of multi-modal transportation to and from downtown.

Hamilton Green

Envisioned as a pedestrian-only public space to support Courthouse S with the city's Parks, Recreation and Community Services to develop a needs for downtown green space and contributes meaningfully to public

Redwood Grove By saving and improving upon the current Redwood trees at the South Project will create roughly 5000 sf of naturally-landscaped public outdoor community better interaction with the trees, their shade, and their lovely

Active Storefront Uses

Broadway is a lively street, with many successful restaurant, entertainn Unfortunately, when the Chase Bank building was built almost a half-ce constructed in a set-back, auto-centric manner, that detracts from the p breaking up the continuity of retail space. The proposed project would s storefront square footage, and we would work with the City and commu manner that best meets the needs of Redwood City.

The Project site at 2300 Broadway is currently underutilized in this exce mostly given over to surface parking areas and a squat, beige bank bui life of downtown aside from the function of the bank itself. While the lan the public's access to and ability to enjoy their canopy could be improve walls running through the redwood grove where one could imagine a pa The rest of the landscaped areas pull back from the sidewalk - distinctly

guidelines of the Downtown Precise Plan and the urban character of th neighboring blocks of Broadway.

The Project proposes: 10 stories

Approx. 110' to solid parapet height, not to exceed Courthouse cupola p Approx. 12,000 SF of ground level retail and amenities Approx. 213,000 GSF of office on upper levels 5,000 SF of publicly-accessed Redwood Grove 15,000 SF of public space Hamilton Green

This project intends to bring active uses, public outdoor space, family-fi compelling streetscape to both Broadway and Hamilton Street. This wil its fullest potential to the character of Broadway and downtown Redwood

SITE INFORMATION

CURRENT ZONING: P - DOWNTOWN ASSESSOR'S PARCEL #: 052-364-130 REFERENCE ADDRESS: 2300 BROADWAY, REDWOOD CITY, C SITE AREA: CURRENT USE: PROPOSED USE: PROPOSED DENSITY: 5.71 FAR SURROUNDING USES:COMMERCIAL OFFICE, INDUSTRIAL-RIBUILDING HEIGHT:110'-8" TO SOLID PARAPET, 129' TO PE PARKING: OPEN SPACE:

39,500 SF (.91 ACRES) FINANCIAL COMMERCIAL OFFICE, RETAIL 2 LEVELS BELOW GRADE PARKING (1 5,000 SF (12.6%) ON SITE, 15,000 SF O

SCOPE OF WORK

10/24/2021 10:09:33 AM

	2300 BROADWAY	Commercial/Office			
			PARCEL AREA		REFERENCE
perty. Our	2010 General Plan	ZONING Mixed Use - Downtown	(SF)		CODE SECTION
ns of in-person	Precise Plan	Downtown			
e future of ication:	Zoning	P - Planned Community			
	Neighborhood Association	Downtown			
community-led	DTPP District APN	Entertainment / Active Ground Floor 052-364-130			
We envision ectly adjacent to	Site Area (actual)		39,500		
ner of Hamilton & e ground floor of					
	PROJECT SUMMARY	PROPOSED	ALLOWED / REQ	D	REFERENCE CODE SECTION
become a	Use	Office, Retail	Permitted/Permitt		DTPP Section 2.2.1
nd other parts of	Floor Area Ratio	5.74	N/A		
t a larger	Number of Stories Above Grade	10	12		DTPP Section 2.7.1
	Along Broadway	3	3		
roject will work	Along Hamilton Height	2 110'-8" / 130'-8" (penthouse)	3 136' / 146' (pentho	ouse)	DTPP Section 2.7.1
meets the city's	Along Broadway	39'-8"	35' minimum	,430)	DTPP Section 2.7.3
	Along Hamilton	110'	35' minimum		
	Gross Floor Area	226,656	N/A		
If the site, the will allow the	Sidewalk Width (min) Setback (Broadway)	12' 0' / 50' / 75'	12' 0' / 40'		DTPP Section 2.4.3.B+C DTPP Section 2.5.1, 2.7
	Setback (Broadway) Setback (Hamilton)	0'	0 / 40 0' / 60'		
	Setback (Winslow)	0'	0'		
ail uses.	Setback (Rear)	0'	0'		
was perience,	Frontage	83%	100%		DTPP Section 2.5.1
icrease active I that space in a			GSF PROPOSED		REFERENCE
	BUILDING AREA SUMMARY		(COUNTED TOW)	ARD FAR)	CODE SECTION
tt. This site is	Level Roof		5,368		RCMC Article 2.2
ars little to the	Level Roof Mechanical Level 9	5,726	22,183		"Floor Area Gross"
eautiful trees, there are low	Level 8		22,183		-
nes instead.	Level 7		22,183		-
to the ientioned	Level 6		22,183		
	Level 5		22,183		_
	Level 4 Level 3		22,183 29,043		-
	Level 2		29,753		-
	Level 1		16,035		
	Level B1	34,762			_
	Level B2	34,762			-
n, and a	TOTAL OFFIC		213,297		4
k to contribute	Level 1 (Retail) Level 1 (Garage Ramp)	2,685	13,359		-
	TOTA		226,656		-
			220,000		
			RATIO	TOTAL STALLS	
	PARKING SUMMARY		(REQUIRED)	(REQUIRED)	CODE SECTION
	Commercial (shared)		3/1000 GSF	680	RCMC Article 30.2.C, DTPP 2.6
				TOTAL STALLS	
	UNDERGROUND PARKING			(PROVIDED)	CODE SECTION
	Parking Level B1			74	
	Parking Level B2		+	77	
			+	151 15	RCMC Article 30.6.C
	TOTAL PARKING PROVIDED		÷		RCMC Article 30.6.D
	Car/Vanpool (10% of total)			45	
	Car/Vanpool (10% of total) Bicycle Parking (1/5000 GSF) Motorcycle Parking			45 8	RCMC Article 30.6.E
TAIL	Car/Vanpool (10% of total) Bicycle Parking (1/5000 GSF)	24'			RCMC Article 30.6.E
"AIL	Car/Vanpool (10% of total) Bicycle Parking (1/5000 GSF) Motorcycle Parking	24'	PERCENTAGE	8	
ЧL	Car/Vanpool (10% of total) Bicycle Parking (1/5000 GSF) Motorcycle Parking	24' GSF	PERCENTAGE (PROPOSED)		RCMC Article 30.6.E REFERENCE CODE SECTION
AIL	Car/Vanpool (10% of total) Bicycle Parking (1/5000 GSF) Motorcycle Parking Depth of Garage Below Grade PUBLIC OPEN SPACE Parcel Area	GSF 39,500		8 PERCENTAGE	REFERENCE
ΑL	Car/Vanpool (10% of total) Bicycle Parking (1/5000 GSF) Motorcycle Parking Depth of Garage Below Grade PUBLIC OPEN SPACE Parcel Area Building Coverage Area	GSF 39,500 32,079	(PROPOSED)	8 PERCENTAGE	REFERENCE
	Car/Vanpool (10% of total) Bicycle Parking (1/5000 GSF) Motorcycle Parking Depth of Garage Below Grade PUBLIC OPEN SPACE Parcel Area Building Coverage Area Redwood Grove	GSF 39,500 32,079 5,000		8 PERCENTAGE	REFERENCE
	Car/Vanpool (10% of total) Bicycle Parking (1/5000 GSF) Motorcycle Parking Depth of Garage Below Grade PUBLIC OPEN SPACE Parcel Area Building Coverage Area Redwood Grove Hamilton Green	GSF 39,500 32,079 5,000 15,000	(PROPOSED) 12.66%	8 PERCENTAGE (REQUIRED)	REFERENCE CODE SECTION
	Car/Vanpool (10% of total) Bicycle Parking (1/5000 GSF) Motorcycle Parking Depth of Garage Below Grade PUBLIC OPEN SPACE Parcel Area Building Coverage Area Redwood Grove	GSF 39,500 32,079 5,000	(PROPOSED)	8 PERCENTAGE	REFERENCE
	Car/Vanpool (10% of total) Bicycle Parking (1/5000 GSF) Motorcycle Parking Depth of Garage Below Grade PUBLIC OPEN SPACE Parcel Area Building Coverage Area Redwood Grove Hamilton Green	GSF 39,500 32,079 5,000 15,000	(PROPOSED) 12.66% 50.63%	8 PERCENTAGE (REQUIRED)	REFERENCE CODE SECTION
	Car/Vanpool (10% of total) Bicycle Parking (1/5000 GSF) Motorcycle Parking Depth of Garage Below Grade PUBLIC OPEN SPACE Parcel Area Building Coverage Area Redwood Grove Hamilton Green TOTAL PUBLIC OPEN SPACE ELEVATORS	GSF 39,500 32,079 5,000 15,000	(PROPOSED) 12.66% 50.63% LEVELS SERVED	8 PERCENTAGE (REQUIRED) 0% 0% DOOR HEIGHT	REFERENCE CODE SECTION DTPP Section 2.5.2 REFERENCE CODE SECTION
	Car/Vanpool (10% of total) Bicycle Parking (1/5000 GSF) Motorcycle Parking Depth of Garage Below Grade PUBLIC OPEN SPACE Parcel Area Building Coverage Area Redwood Grove Hamilton Green TOTAL PUBLIC OPEN SPACE ELEVATORS Office Floors	GSF 39,500 32,079 5,000 15,000 20,000	(PROPOSED) 12.66% 50.63% LEVELS SERVED L1-LR	8 PERCENTAGE (REQUIRED) 0% 0% DOOR HEIGHT 8'-0"	REFERENCE CODE SECTION DTPP Section 2.5.2 REFERENCE
	Car/Vanpool (10% of total) Bicycle Parking (1/5000 GSF) Motorcycle Parking Depth of Garage Below Grade PUBLIC OPEN SPACE Parcel Area Building Coverage Area Redwood Grove Hamilton Green TOTAL PUBLIC OPEN SPACE ELEVATORS	GSF 39,500 32,079 5,000 15,000 20,000	(PROPOSED) 12.66% 50.63% LEVELS SERVED L1-LR B2-LR	8 PERCENTAGE (REQUIRED) 0% 0% DOOR HEIGHT	REFERENCE CODE SECTION DTPP Section 2.5.2 REFERENCE CODE SECTION

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PLANNING APPLICATION PLANNING APPLICATION #2	03/03/2021 10/22/2021

REVISION LIST

DATE

2300 BROADWAY Redwood City, CA

KEYPLAN


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SHEET TITLE:

PROJECT INFORMATION

SHEET NO:


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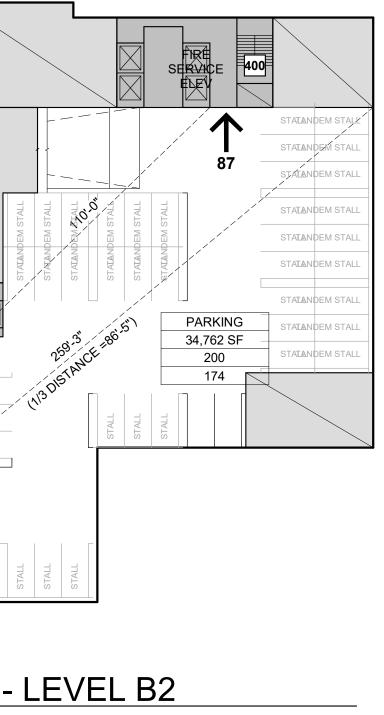
8 FLOOR PLAN - LEVEL B2



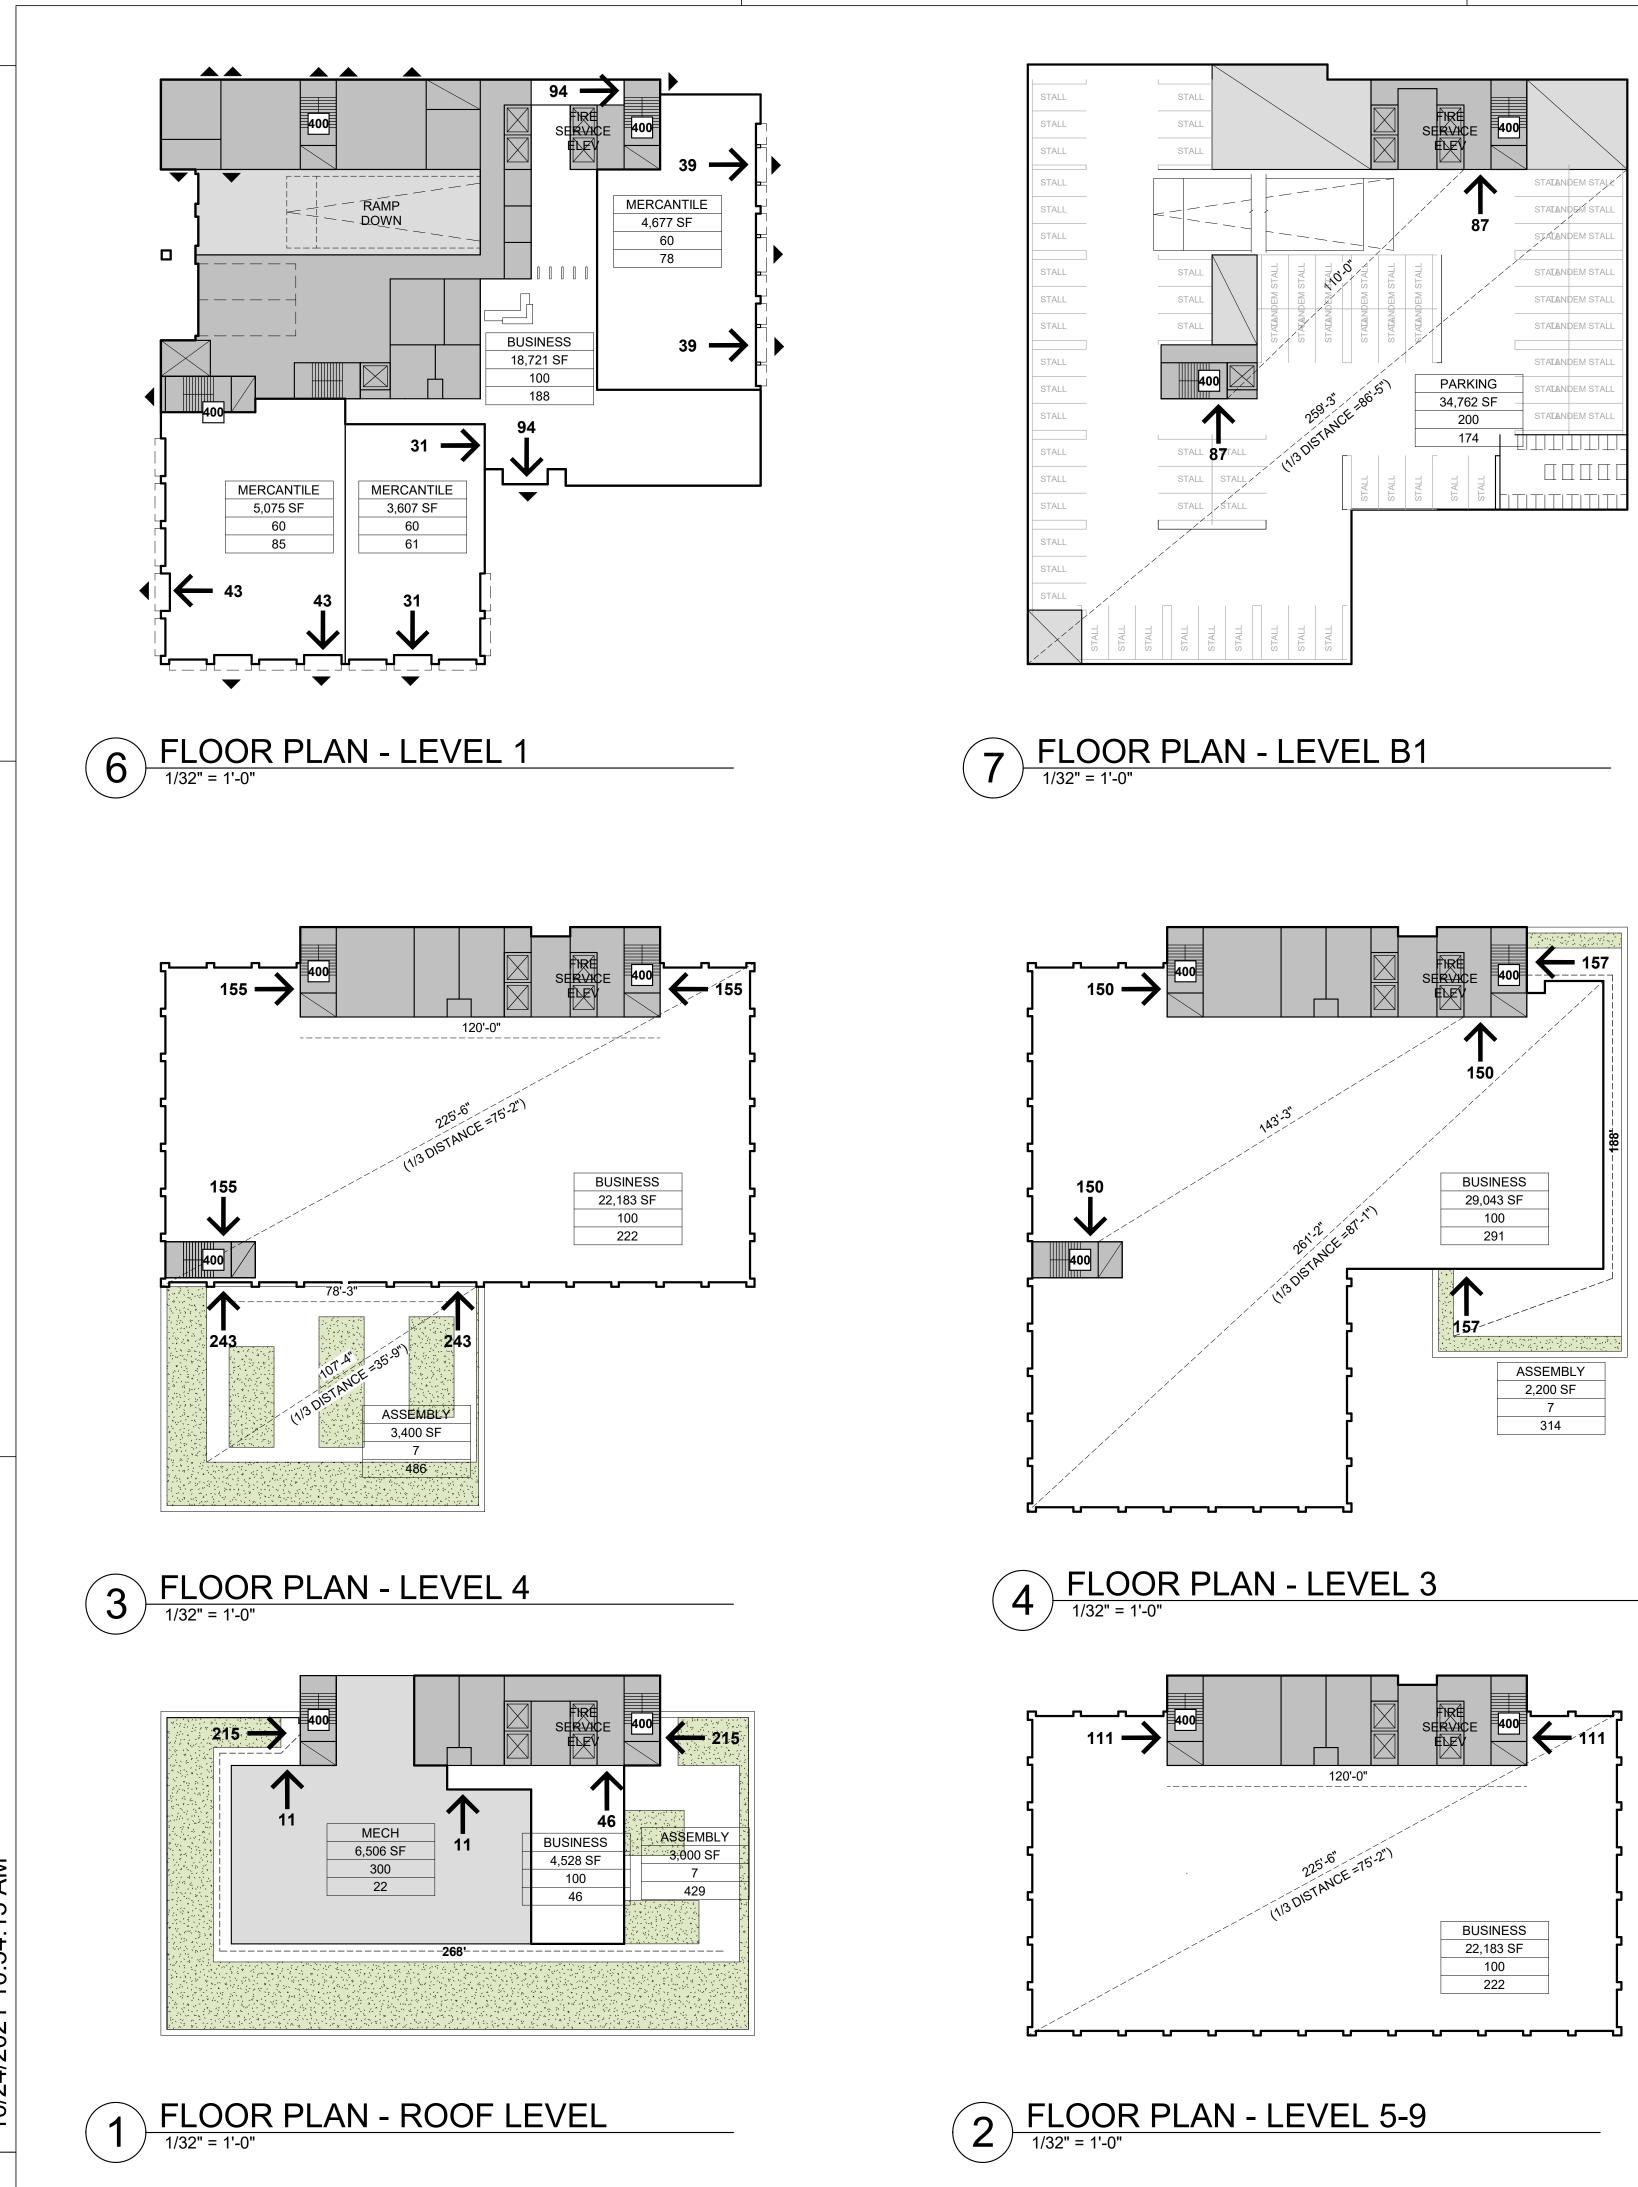

NOTE: 100 GROSS USED FOR B OCC. IN LIEU OF 150 FOR FUTURE FLEXIBILITY. ALL ASSEMBLY OCC.

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		LE	EVE	EL 2	2
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100

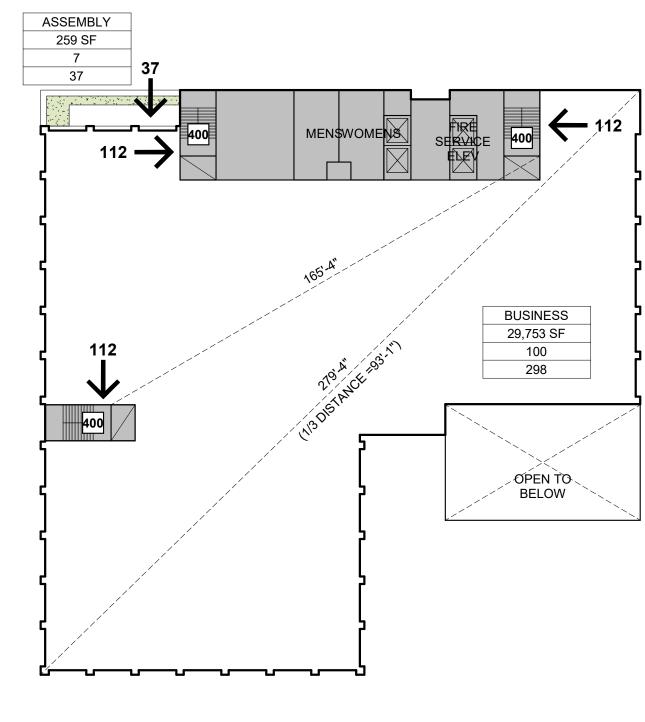13

OCCUPANCY - USE/OCCUPANT TYPE 1,250 SF 🚽 ROOM AREA - OCCUPANT LOAD FA (OCCUPANTS PER S CCUPANT LOAD

CONSIDERED ACCESSORY TO B

ACTOR	\uparrow
SF)	xx
	▼

------ INDICATES AN EXIT ------ NUMBER OF OCCUPANTS EXITING - EXIT AT GRADE

400 - # OF OCCUPANTS EXIT CAN ACCOMMODATE


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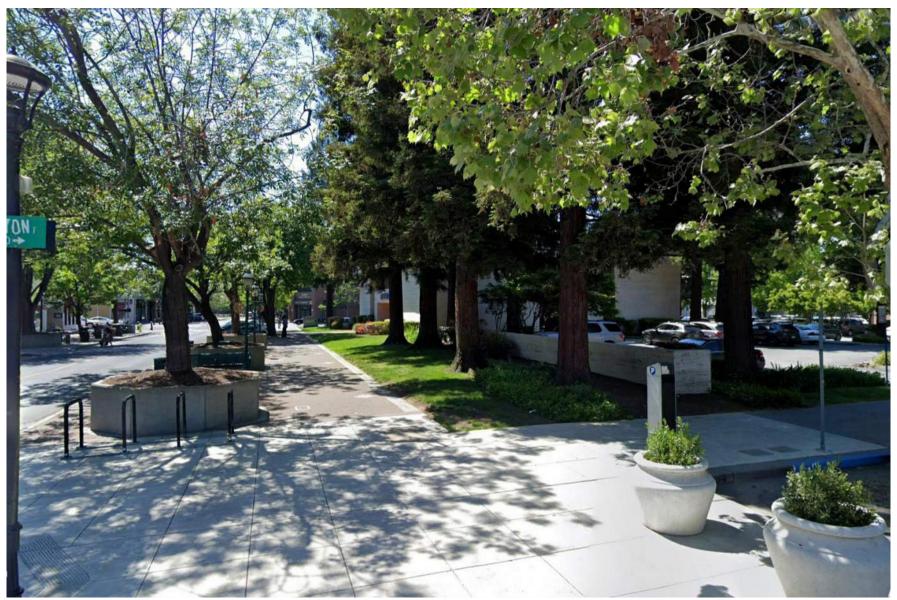
Son Street 4TH FLOOR, STE. 402 SAN FRANCISCO CALIFORNIA 94107 415.489.2224 TEL 415.358.9100 FAX WWW.WRNSSTUDIO.COM	
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PROJECT NO.: 19046.00 DATE: 10/22/2021	

SCALE: As indicated SHEET TITLE:

PRELIMINARY EXITING PLANS


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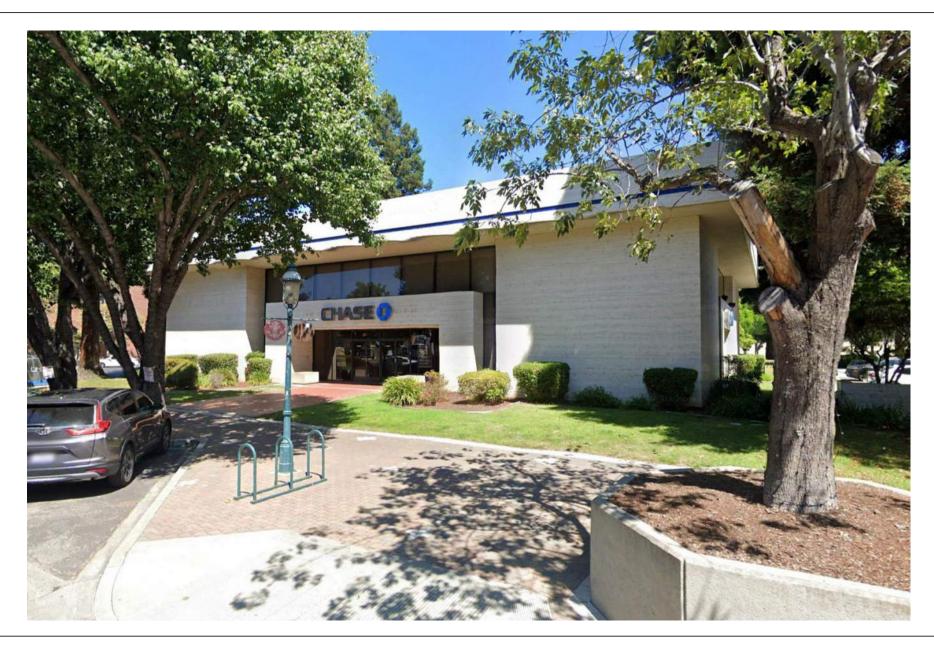
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2 EXISTING HAMILTON AUTO ENTRY

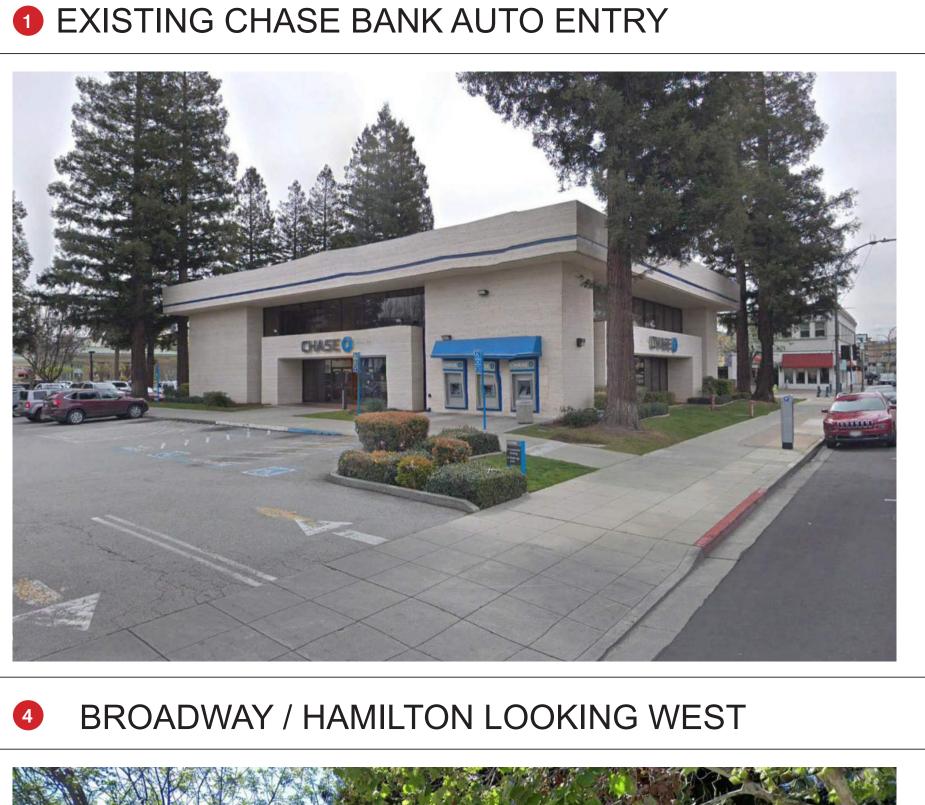

5 BROADWAY / WINSLOW LOOKING EAST




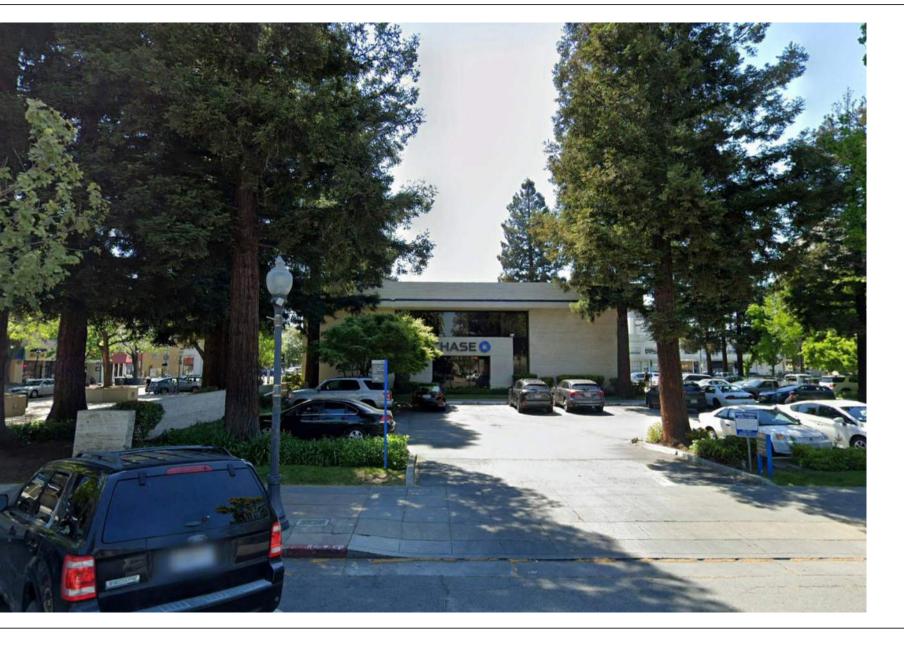

6 STREETSCAPE ALONG WINSLOW



KEY PLAN

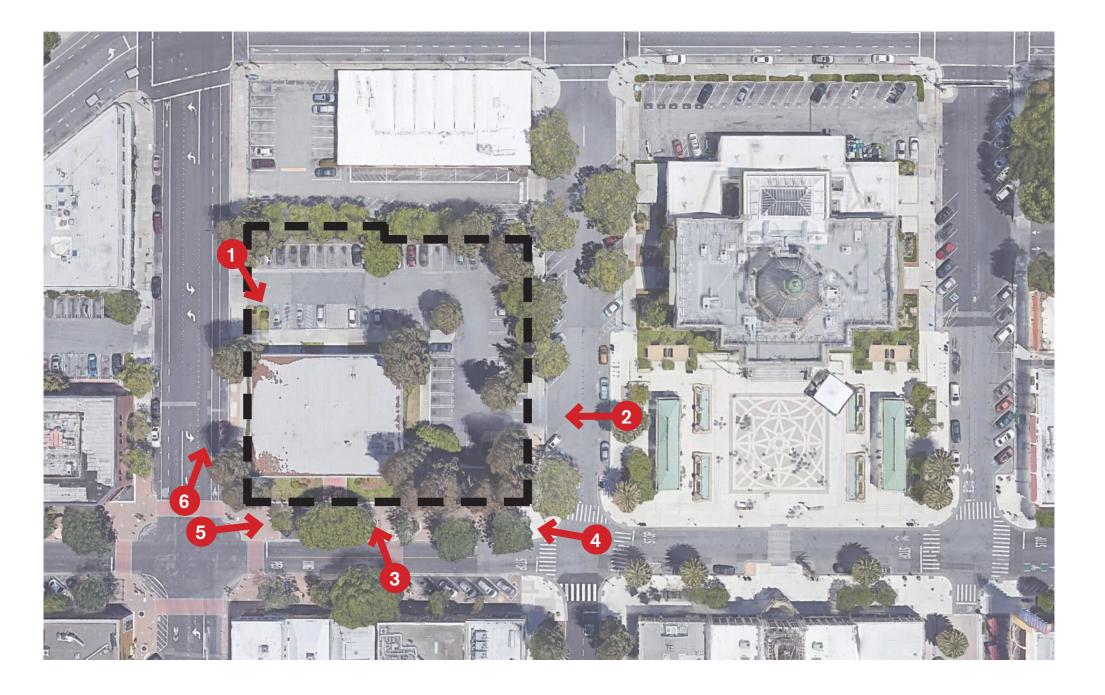

3 EXISTING PEDESTRIAN ENTRY

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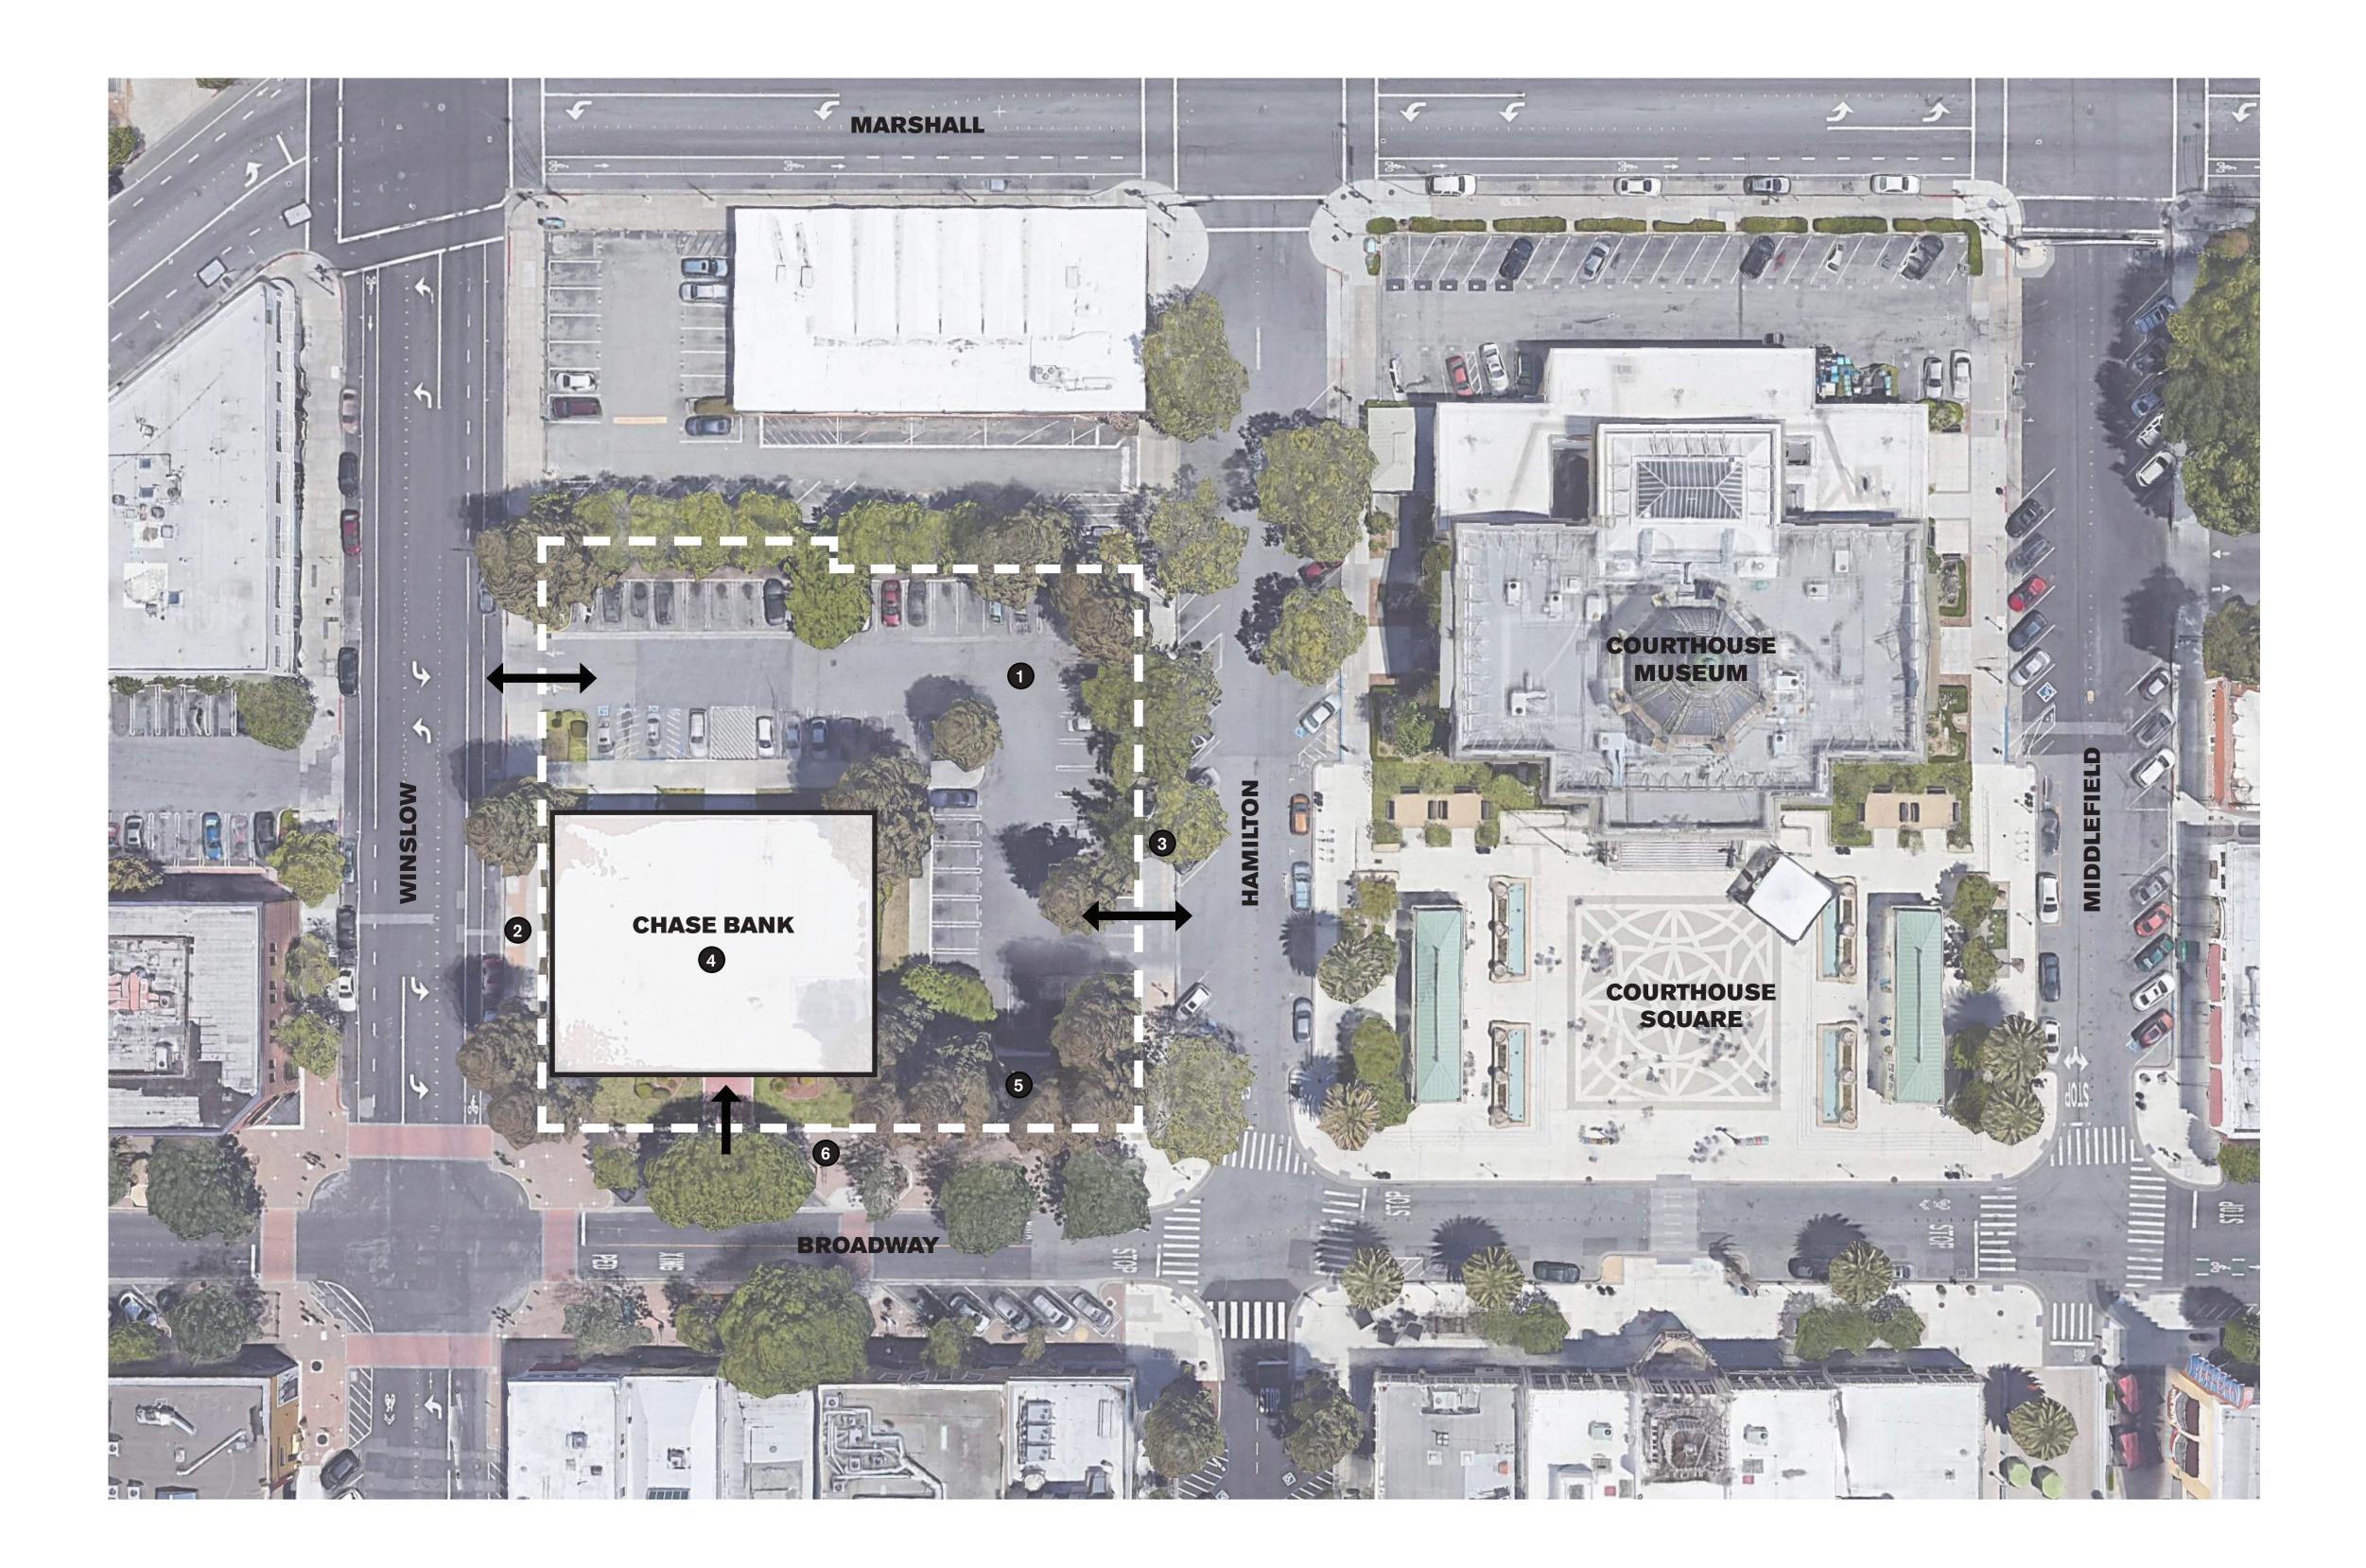
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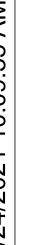
SHEET TITLE:

EXISTING SITE CONDITIONS

SHEET NO:



EXISTING SITE PLAN LEGEND



2

(3)

4

1 PAVED SURFACE PARKING LOTS NO STREETSCAPE ON WINSLOW NO INTERACTION WITH HAMILTON UNDERUTILIZED PROPERTY 5 SITE WALLS ENCROACH ON TREES

6 DOES NOT CONTRIBUTE TO BROADWAY'S ACTIVITIES AND USES

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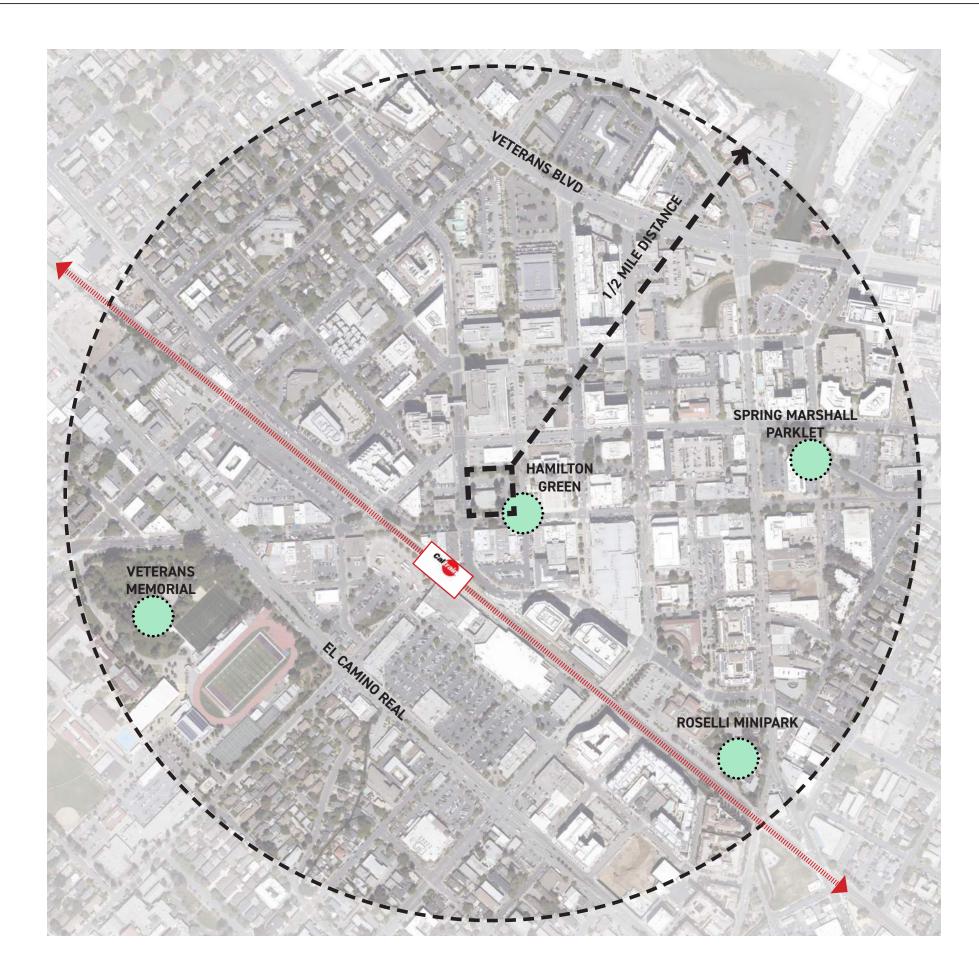
PROJECT NO.: 19046.00 DATE: 10/22/2021 SCALE: 1/8" = 1'-0" SHEET TITLE:

EXISTING SITE PLAN


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CREATE COMMUNITY BENEFITS



Community for All



Green Space Downtown

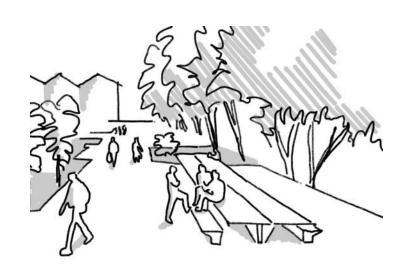

Active Storefronts



Public Amenities




Community Partnerships




Support Cycling

PRESERVE THE REDWOOD GROVE

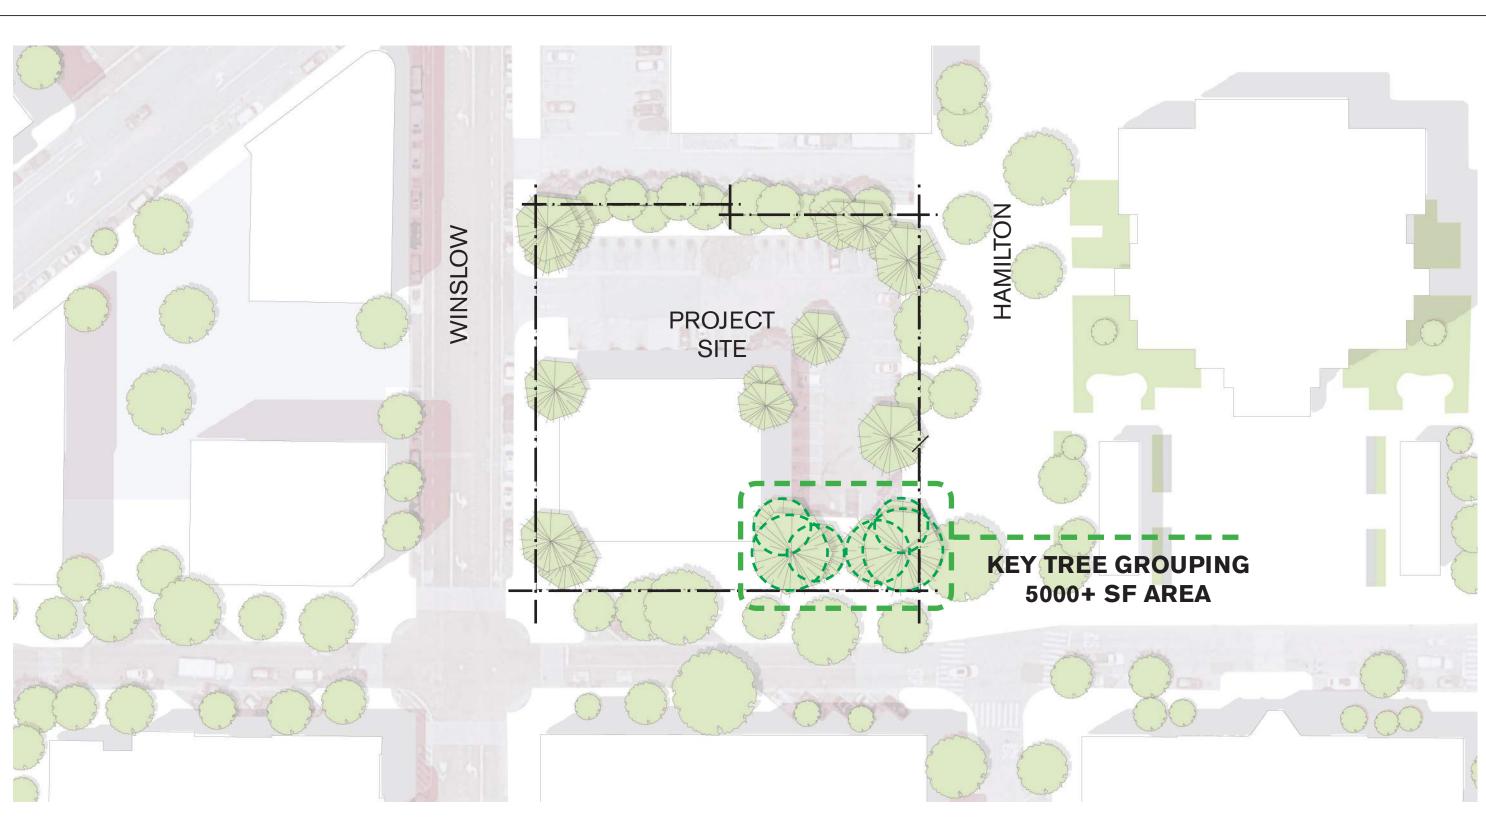



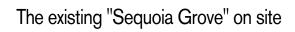



The existing "Sequoia Grove" from across Courthouse Square

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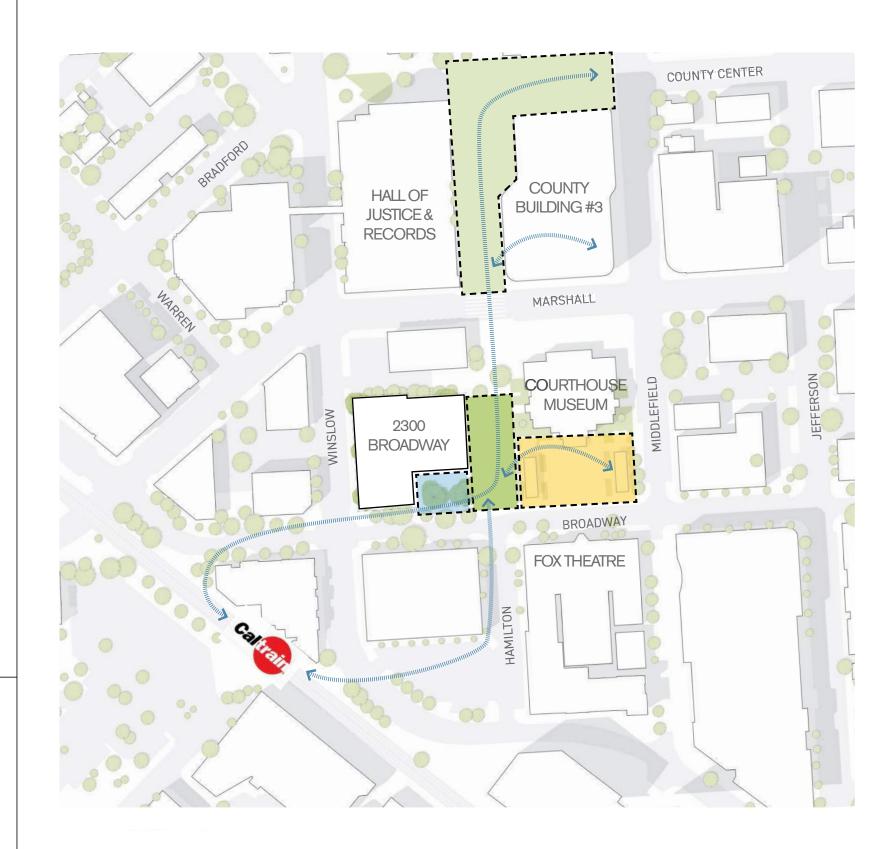
SHEET TITLE:

PROJECT GOALS & CONCEPTS

SHEET NO:

G-006

STITCH INTO THE LARGER PEDESTRIAN NETWORK



The Project has multiple opportunities to build upon Redwood City's pedestrianfriendly and regionallyconnected potential. Creating a pedestrian only Hamilton Green and linking it to the larger pedestrian pathway from Caltrain to County and office buildings creates a safe transit oriented arrival into downtown.

CREATE AN ACTIVE URBAN EDGE



This context map illustrates the current distribution of active uses along Broadway and the Project's proximity to CalTrain. We can see from the current uses on site that this block is undercontributing to the rich life of Broadway.

This project intends to bring active uses, public outdoor space, family-friendly program, and a compelling streetscape to both Broadway and Hamilton Street. This will allow the block to contribute its fullest potential to the character of Broadway and downtown Redwood City.

- Food / Cafe • Civic / Cultural Entertainment Retail
- Bank
- Professional
- County

PRESERVE A SENSE OF PLACE








The Fox Theatre

2300 Broadway is located at the intersection of Broadway and Hamilton Street. Broadway's thriving shops and bistros support a sidewalk community that has made Redwood City one of the most successful downtowns in the Bay Area. Across the street, the grand Fox Theatre makes for a memorable icon. It is places like these that make Redwood City's downtown life so great.

The Project site at 2300 Broadway is currently underutilized in this exceptional context. This site is mostly given over to surface parking areas and a squat, beige bank building that offers little to the life of downtown aside from the function of the bank itself. While the landscape has beautiful trees, the public's access to and ability to enjoy their canopy could be improved - currently there are low walls running through the redwood grove where one could imagine a path with benches instead. The rest of the landscaped areas pull back from the sidewalk - distinctly in opposition to the guidelines of the Downtown Precise Plan and the urban character of the previously mentioned neighboring blocks of Broadway.


With other pedestrian improvements underway, Hamilton Street has the potential to become a pedestrian throughfare linking CalTrain to Courthouse Square, County Building 3, and other parts of Redwood City to the North. With further improvement, it has the potential to support a larger network of multi-modal transportation to and from downtown.



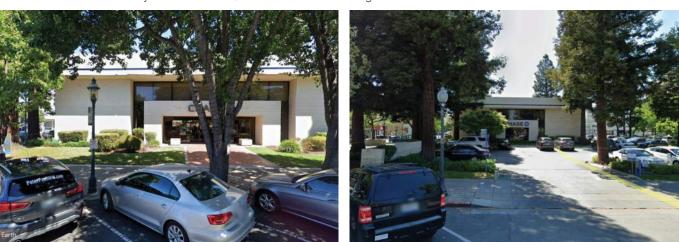

Current view along Broadway

DOWNTOWN PLACEMAKING OPPORTUNITY

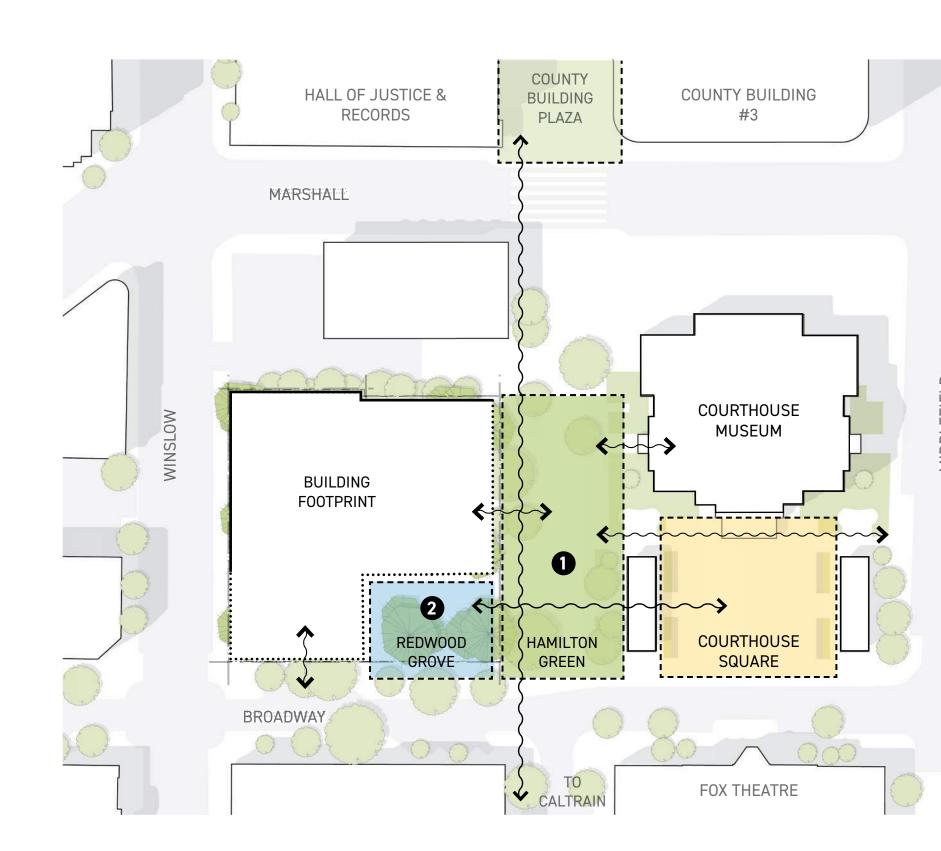



Intersection of Broadway and Hamilton, with the site's existing Redwood trees

Current view along Hamilton Street

The Project will work with the City and community to create new publiclyaccessible spaces that support the current offerings of Courthouse Square. These will stand alone as memorable places, Redwood Grove & Hamilton Green, and will stitch respectfully into their context to support a Downtown which is more than the sum of its parts. These two publicly-accessed spaces will be at ground level, accessible and barrierfree, and contribute much to the public realm.

1 Hamilton Green

Envisioned as a pedestrian-only public space to support Courthouse Square, the Project will work with the city's Parks, Recreation and Community Services to develop a space that meets the city's needs for downtown green space and contributes meaningfully to public life.

2 Redwood Grove

By saving and improving upon the current Redwood trees at the Southeast corner of the site, the Project will create roughly 5000 sf of naturally-landscaped public outdoor space that will allow the community better interaction with the trees, their shade, and their lovely understorv

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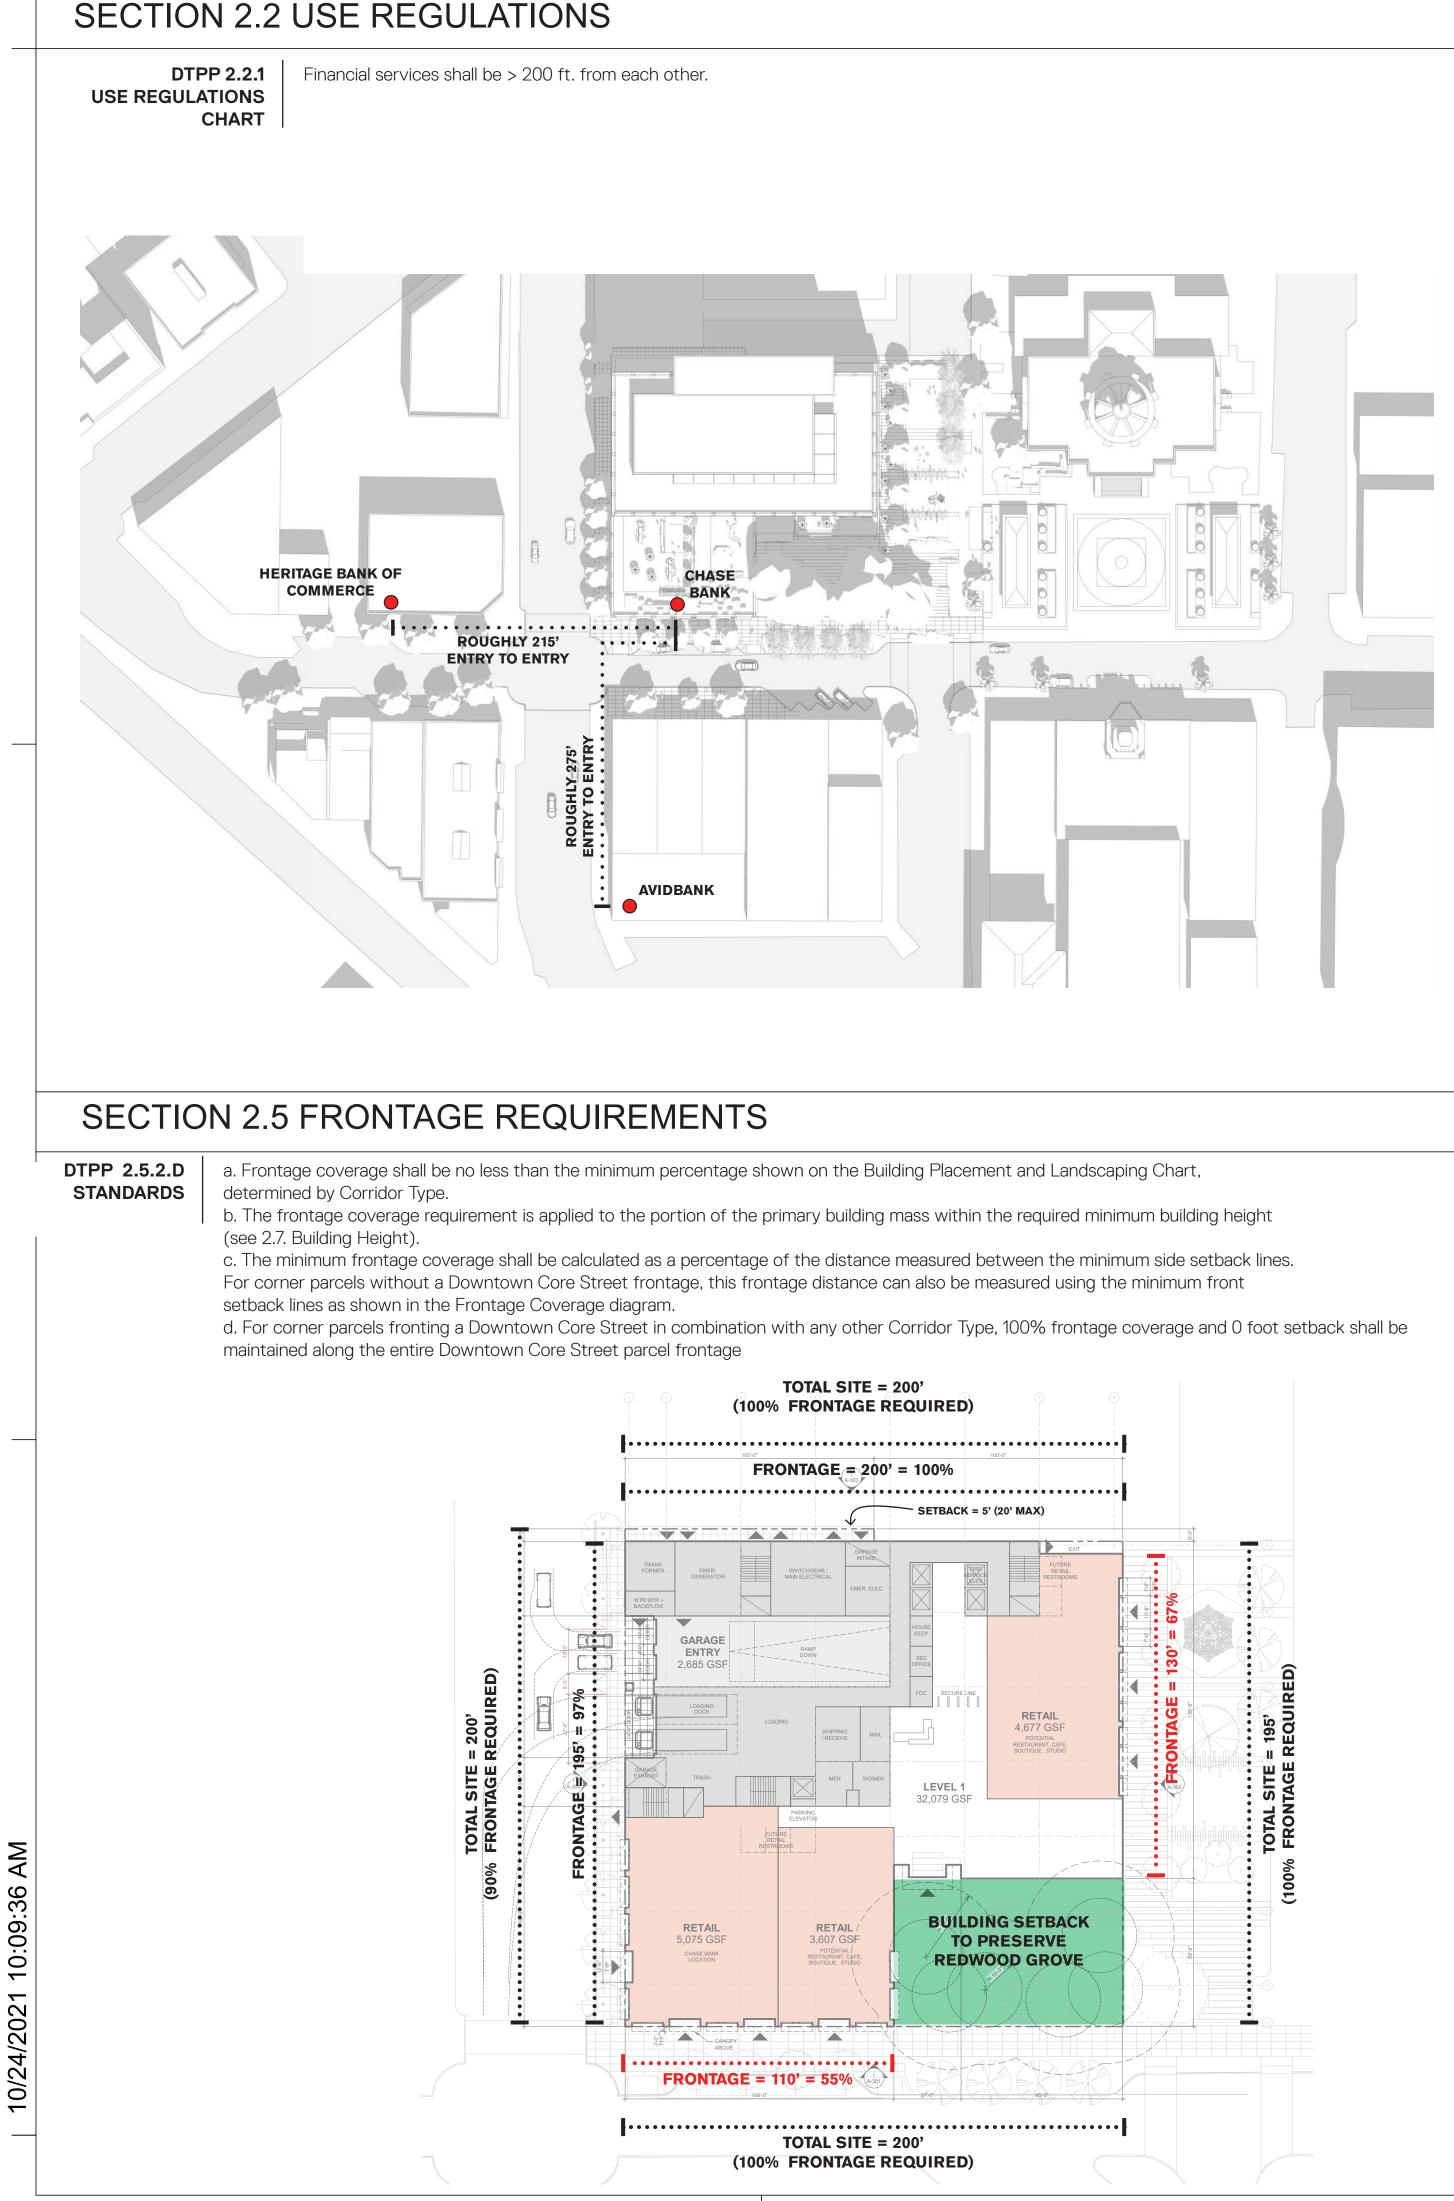
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PROJECT NO.: 19046.00 DATE: 10/22/2021 SCALE:

SHEET TITLE:

PROJECT GOALS & CONCEPTS

SHEET NO:



SECTION 2.5 FRONTAGE NARRATIVE

WE ASK THAT AN AMENDMENT BY MADE TO SECTION 2.5.2.E AND 2.5.2.D TO ALLOW THE PRESERVATION OF THE EXISTING REDWOOD GROVE ON THE SOUTHEAST CORNER OF THE 2300 BROADWAY SITE.

BY SAVING AND IMPROVING UPON THE CURRENT REDWOOD TREES AT THE SOUTHEAST CORNER OF THE SITE, THE PROJECT WILL CREATE ROUGHLY 5000 SF OF NATURALLY-LANDSCAPED PUBLIC OUTDOOR SPACE THAT WILL ALLOW THE COMMUNITY BETTER INTERACTION WITH THE TREES, THEIR SHADE, AND THEIR LOVELY UNDER STORY

THESE TREES LIVE AT A UNIQUE LOCATION IN RELATION TO HAMILTON AND THE COURTHOUSE SQUARE. THEY ARE ABLE TO DEFINE AND MARK THE CORNER, WHILE BEING FAR ENOUGH SOUTH TO SHADE SOME OF THE SQUARE AND MUCH OF HAMILTON. THE PROJECT SITE AT 2300 BROADWAY IS CURRENTLY UNDERUTILIZED IN THIS EXCEPTIONAL CONTEXT. THIS SITE IS MOSTLY GIVEN OVER TO SURFACE PARKING AREAS AND A SQUAT, BEIGE BANK BUILDING THAT OFFERS LITTLE TO THE LIFE OF DOWNTOWN ASIDE FROM THE FUNCTION OF THE BANK ITSELF. WHILE THE LANDSCAPE HAS BEAUTIFUL TREES, THE PUBLIC'S ACCESS TO AND ABILITY TO ENJOY THEIR CANOPY COULD BE IMPROVED - CURRENTLY THERE ARE LOW WALLS RUNNING THROUGH THE REDWOOD GROVE WHERE ONE

COULD IMAGINE A PATH WITH BENCHES INSTEAD. THE REST OF THE LANDSCAPED AREAS PULL BACK FROM THE SIDEWALK - DISTINCTLY IN OPPOSITION TO THE GUIDELINES OF THE DOWNTOWN PRECISE PLAN AND THE URBAN CHARACTER OF THE NEIGHBORING BLOCKS OF BROADWAY.


SO WHILE THE PROPOSED BUILDING SETS BACK FROM THIS CORNER, THE IMPROVED LANDSCAPE FOSTERING MORE INTERACTION WITH THE UNDER STORY OF THE REDWOODS DOES COME DIRECTLY TO THE SIDEWALK EDGE. THUS MAKING THE OUTDOOR SPACE HOLD THE CORNER.

SECTION 2.5 BUILD TO CORNER REQUIREMENTS

DTPP 2.5.2.E STANDARDS

a. Build-to-corner treatments shall be required as indicated on the Building Placement and Landscaping Map. b. At designated corners, the front setback shall not exceed the minimum front setback shown for the applicable Corridor Type on the Building Placement and Landscaping.

c. The minimum front setback shall be held for no less than 25 feet from the corner along each corridor.

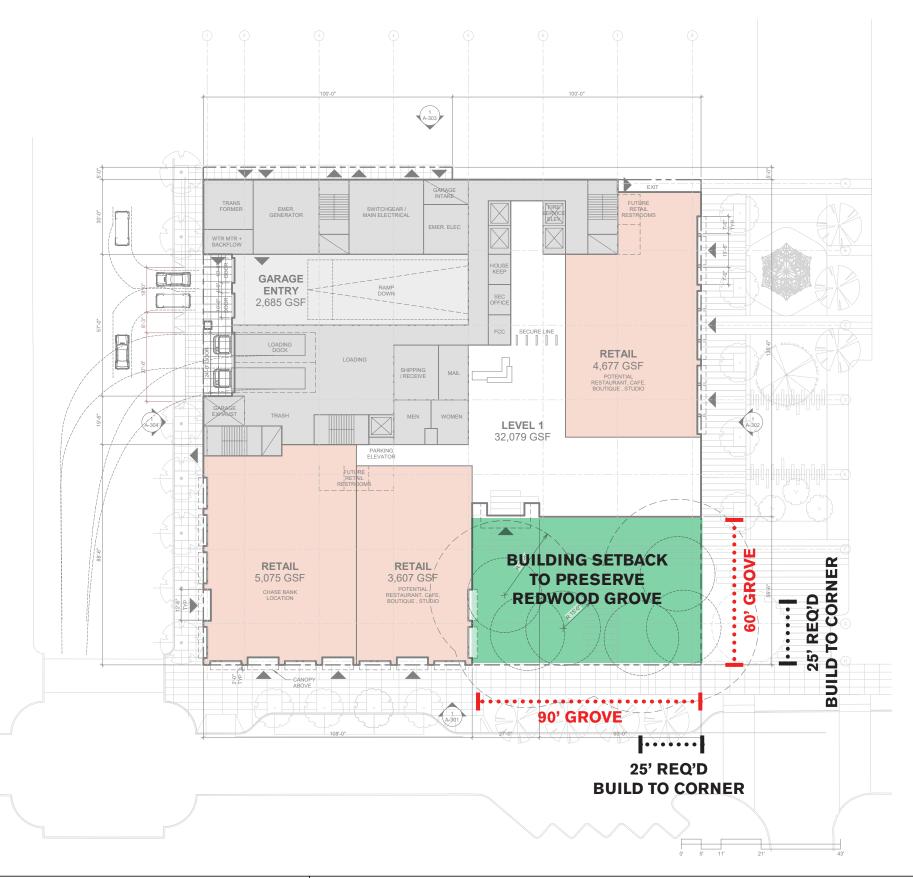

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2300 BROADWAY Redwood City, CA

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PROJECT NO.: 19046.00 DATE: 10/22/2021 SCALE:

SHEET TITLE:

DTPP COMPLIANCE SECTION 2.2 & 2.5

SHEET NO:

SECTION 2.7 STEPDOWN ZONE REQUIREMENTS

DTPP 2.7.1.F STANDARDS 3 Story Stepdown Height Zone

• This Stepdown Height Zone was created to bring heights down from the standard 8 story maximum permitted height in areas with high concentrations of historic resources,

- potential shadow concerns, or areas adjacent to low-rise neighborhoods. • Includes parcels and portions or parcels as designated on the Height Zones Map.
- Additional regulations are applied to Historic parcels within the 3 Story Zone as indicated on the map

BUILDING HEIGHT AND DISPO	SITION REGULATIONS (CHART				
Height Zones (Sec. 2.7.1)	12 Story Zone	10 Story Zone	8 Story Zone	5 Story Zone	4 Story Zone	3 Story Zone
Maximum Height (Sec. 2.7.2)						
Maximum	12 floors / 136 feet	10 floors / 114 feet	8 floors / 92 feet	5 floors / 59 feet	4 floors / 48 feet	3 floors / 35 feet
Relation to Single Family Homes					Required	Required
Special Corner Treatment	Required at					
Accessory Buildings	1.5 floors / 14 feet					
Minimum Height (Sec. 2.7.3)						
Required Minimum Height	3 floors / 35 feet					
Maximum Corner Height	Tallest mass located at					
Building Disposition Types (Sec 2.7.	4)					
Rearyard	Permitted	Permitted	Permitted	Permitted	Permitted	Permitted
Courtyard	Permitted	Permitted	Permitted	Permitted	Permitted	Permitted
Tower	Permitted	Permitted	Permitted			
Specialized	Discretionary	Discretionary	Discretionary	Discretionary		

Legend

Permitted : These elements are allowed, by right, as indicated

Required : These elements are required of all new development as indicated. Discretionary: These elements may or may not be permitted, subject to consideration by the Planning Manager/Designee

--- : These elements are not permitted, as indicated. 12 floors / 136 feet: Maximum or minimum height, measured in habitable floors and in feet, measured from average finish grade

SECTION 2.7 STEPDOWN ZONE NARRATIVE

WE ASK THAT AN AMENDMENT BY MADE TO SECTION 2..7.1.F ALLOWING A RANGE OF MINIMUM AND MAXIMUM HEIGHTS AND FLOORS TO BETTER RESPOND TO DIFFERENT PEDESTRIAN SCALES, DATUMS, AND MASSING GESTURES ON BROADWAY AND HAMILTON ELEVATIONS.

THERE ARE TWO REAL DRIVERS TO THE PROJECT APPROACH. ONE IS THE BEST MASSING RESPONSE TO THE SPECIFIC SITE CONTEXT. THE SECOND IN THE DIFFERENT SCALES AND DATUMS OF BROADWAY STREET AND HAMILTON GREEN.

MASSING -

THE MASSING DOES A SERIES OF THREE BIG MOVES AS ILLUSTRATED BY THE "RESPONDING TO PLACE" DIAGRAMS. THE FIRST IS DROP FROM THE ALLOWABLE HEIGHT OF 136' TO 112' TO BETTER RELATE TO THE COURTHOUSE MUSEUM AND NOT BECOME TOO TALL IN RELATION. THE COUNTY BUILDINGS TO THE NORTH OF US DON'T DO THIS, AND IT IS EVIDENT THAT THEY TOWER OVER THE COURTHOUSE DOME. DOING THIS LOPS OFF AT LEAST A FLOOR FROM THE DTPP PRESCRIBED MASSING ENVELOPE, REDUCING THE SF BY ROUGHLY 22,500 SF. THE SECOND MOVE IS PRESERVING THE REDWOOD GROVE AND ALL THAT IT HAS TO OFFER THE PUBLIC. THIS FURTHER REDUCES THE DTPP PRESCRIBED MASSING ENVELOPE BY ROUGHLY ANOTHER 19,500 SF. THE THIRD, AND WHAT WE BELIEVE IS THE MOST IMPORTANT MASSING GESTURE. IS THAT THE TOWER MASS IS PUSHED TO THE NORTH. THIS DOES A FEW VERY IMPORTANT THINGS -

- BY PUSHING THE MASS TO THE NORTH, AND CREATING A SIMPLE BAR OF A BUILDING RATHER THAN AN "L", WE ALLOW THE FACADE OF THE COURTHOUSE MUSEUM TO STILL BE THE BACKDROP OF THE SQUARE. THE "L" CONFIGURATION APPEARS TO OVERSHADOW OR BECOME TO DOMINANT.
- THE PROPOSED MASSING BETTER ALLOWS THE SQUARE TO FLOW INTO HAMILTON GREEN AND THE REDWOOD GROVE WITHOUT FEELING WALLED IN. THE LOWER PORTION OF THE REDWOOD ROOM RELATES TO THE EXISTING PAVILIONS IN THE SQUARE AS OBJECTS IN A LARGER FIELD.
- THE PROPOSED MASSING GIVES THE TREES BREATHING ROOM AND VISIBILITY ALL ALONG BROADWAY. AS NOTED BY CHARLIE DRECHSLER, CITY ARBORIST "....[THE TREES] ARE VISIBLE FROM THE WESTERN NEIGHBORHOOD AND PROVIDE A GREEN BUFFER TO THE NEW SKYLINE IN DOWNTOWN REDWOOD CITY....". BY PUSHING NORTH AND CREATING A SIMPLE BAR, WE DON'T BLOCK OR BOX IN THE REDWOOD TREES. INSTEAD ALLOWING THE GROVE TO BE AN ELEMENT OF ITS OWN WITH THE BUILDING SHOWING DEFERENCE.
- WHILE ANY SCHEME ON THIS SITE MEETS THE SHADING REQUIREMENT OF SECTION 2.7.5, THIS MASSING PRESERVES THE MOST SUNLIGHT TO THE SQUARE THROUGHOUT THE YEAR, AS SHOWN BY THE "SOLAR INCIDENCE" DIAGRAM ON G-012.

STEPDOWN ZONE -


WORKING IN CONJUNCTION WITH THE MASSING, THE STEPDOWN ZONE MAXIMUM AND MINIMUM REQUIREMENTS ARE TOO STRINGENT TO ALLOW THE DESIGN TO RESPOND TO INDEPENDENT STREET CONDITIONS IN THE BEST WAY. IT ALSO LIMITS THE VIABILITY OF RETAIL AND OFFICE TENANTS BE DELINEATING THE FLOOR TO FLOOR HEIGHTS.


ALONG BROADWAY, AT 3 STORIES AND 35', THIS DOES NOT ALLOW MODERN RETAIL FLOOR TO FLOORS OF 16' ON THE GROUND LEVEL, LEAVING ONLY 9.5' FOR EACH OF THE TWO FLOORS ABOVE, MAKING THE OFFICE SPACE UNDESIRABLE. WE ARE PROPOSING 3 STORIES AND 40' TO ALLOW A MINIMIZED GROUND LEVEL OF 15' FLOOR TO FLOOR, WITH TWO LEVELS OF 12'-6" FLOOR TO FLOOR ABOVE.


ALONG HAMILTON, WITH THE PROJECT PROPOSING A PEDESTRIAN ONLY HAMILTON GREEN, WE BELIEVE THE SCALE OF EXPRESSING TWO STORIES BETTER RELATES TO THE NEW HAMILTON GREEN. THE EXISTING PAVILIONS IN THE SQUARE, OFFERS VARIATION, AND ALLOWS A THIRD LEVEL TERRACE WITH BETTER INTERACTION TO THE GREEN AND COURTHOUSE SQUARE.

ABOVE THE EXPRESSED TWO STORIES ALONG HAMILTON, THE MASSING ABOVE IS PROPOSED TO EXTEND INTO THE 60' STEPDOWN SETBACK. THIS ALLOWS THE BENEFITING MASSING MOVES AS DESCRIBED EARLIER, AND ALLOWS THE PROJECT TO REGAIN THE 42,000 SF WITHOUT SACRIFICING THOSE BENEFITS.

SECTION 2.7 RESPONDING TO PLACE

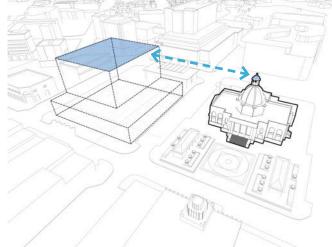

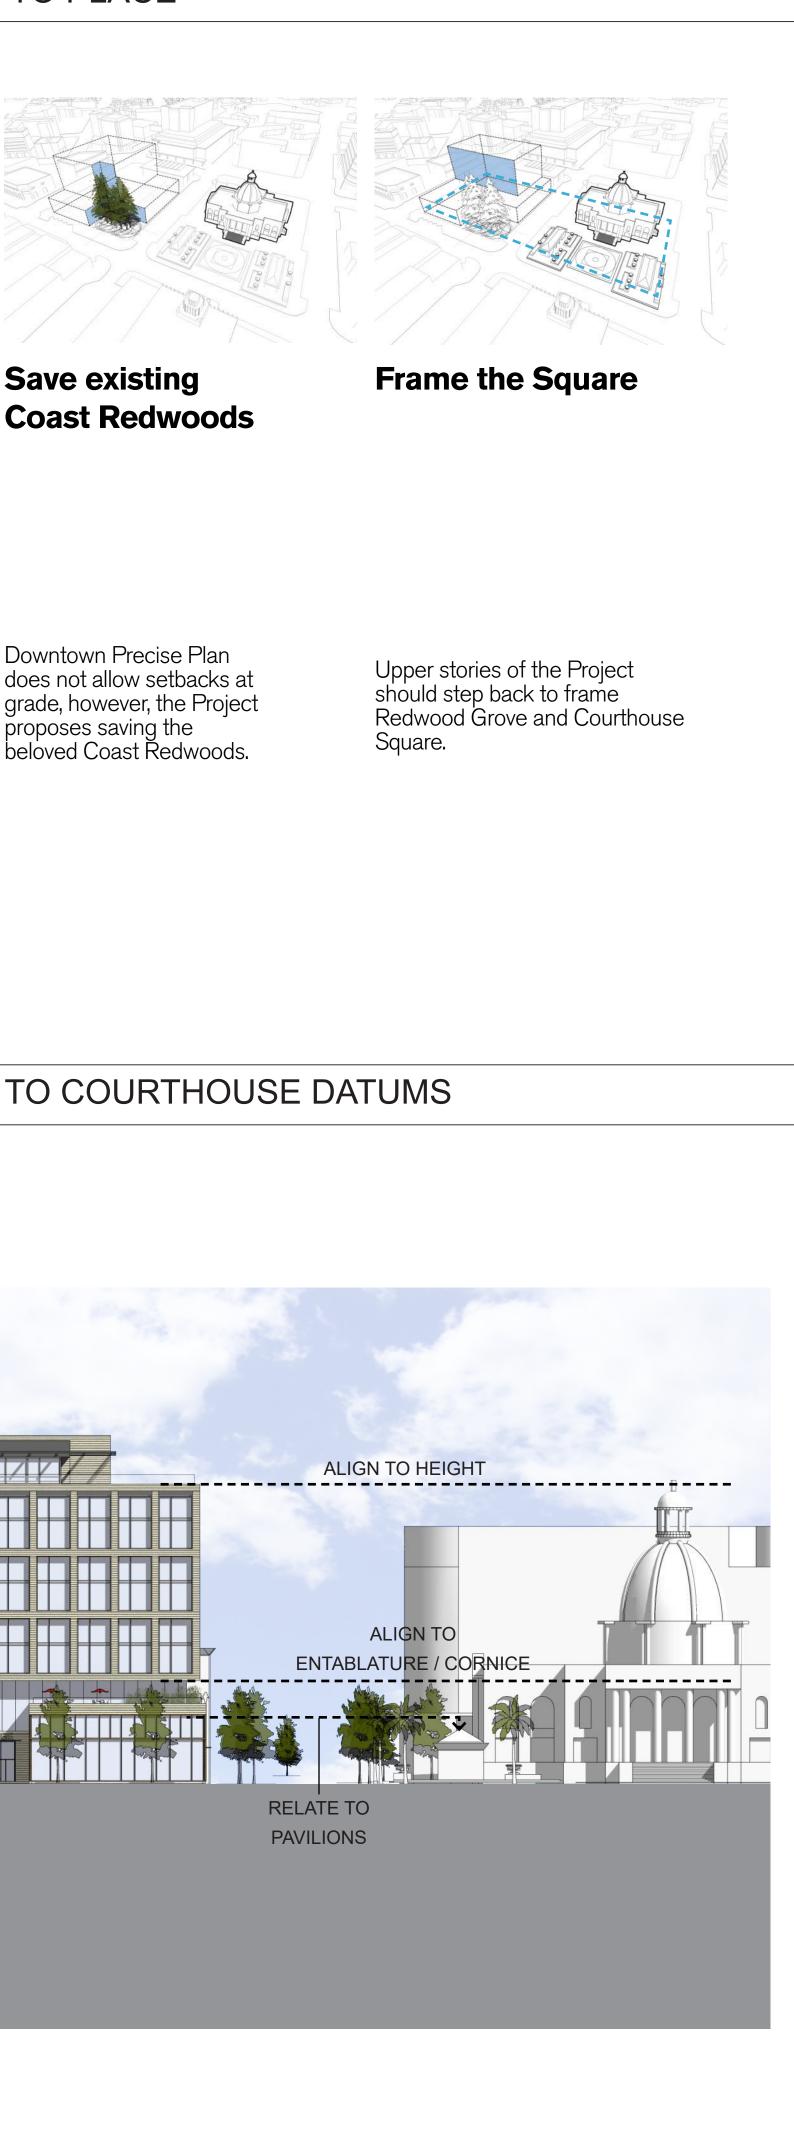

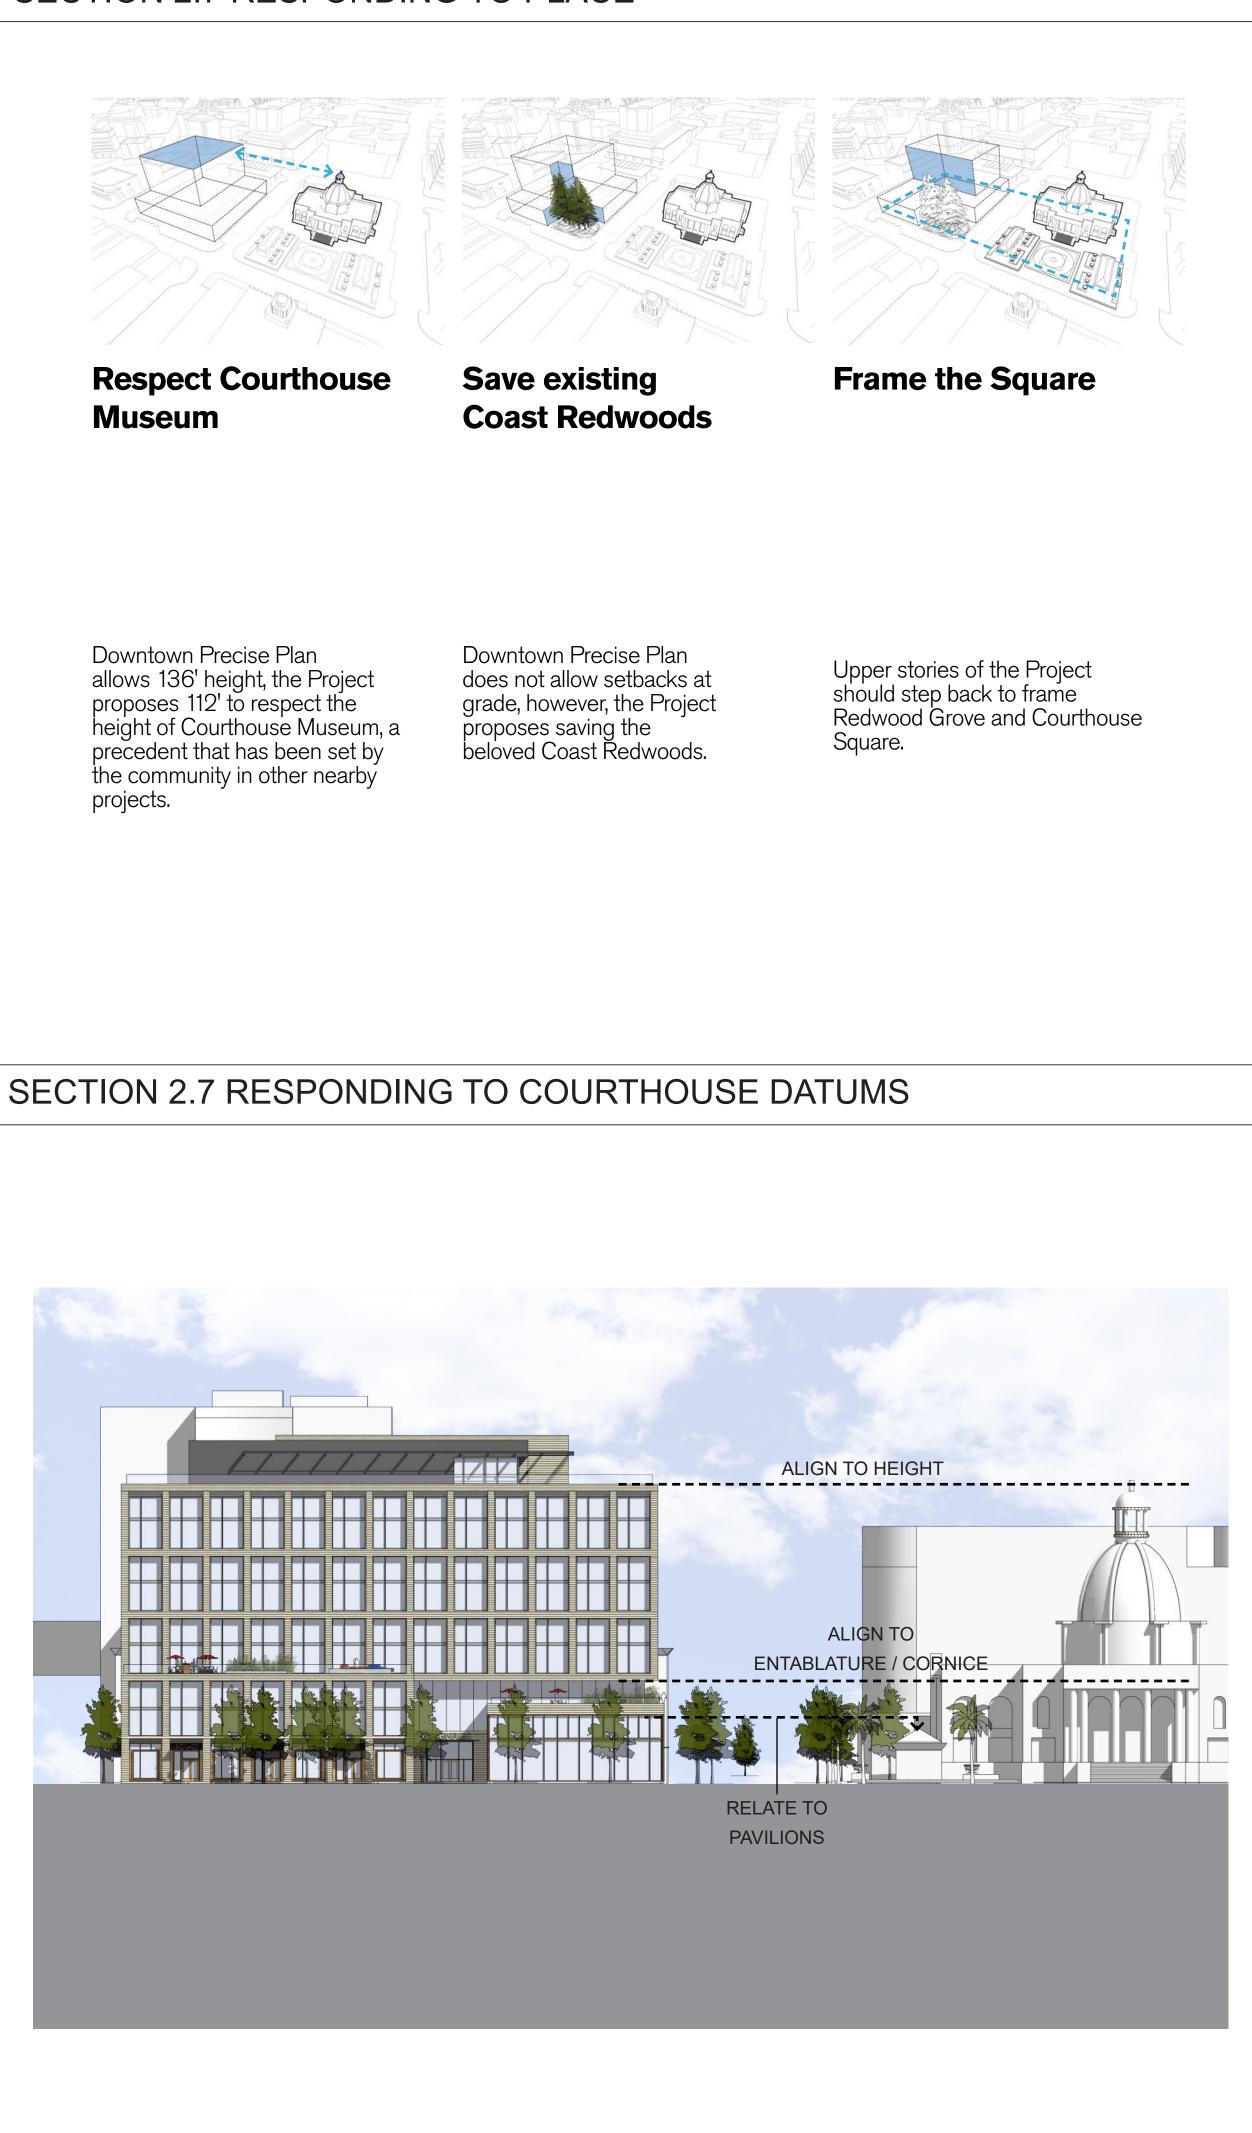

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2300 BROADWAY Redwood City, CA

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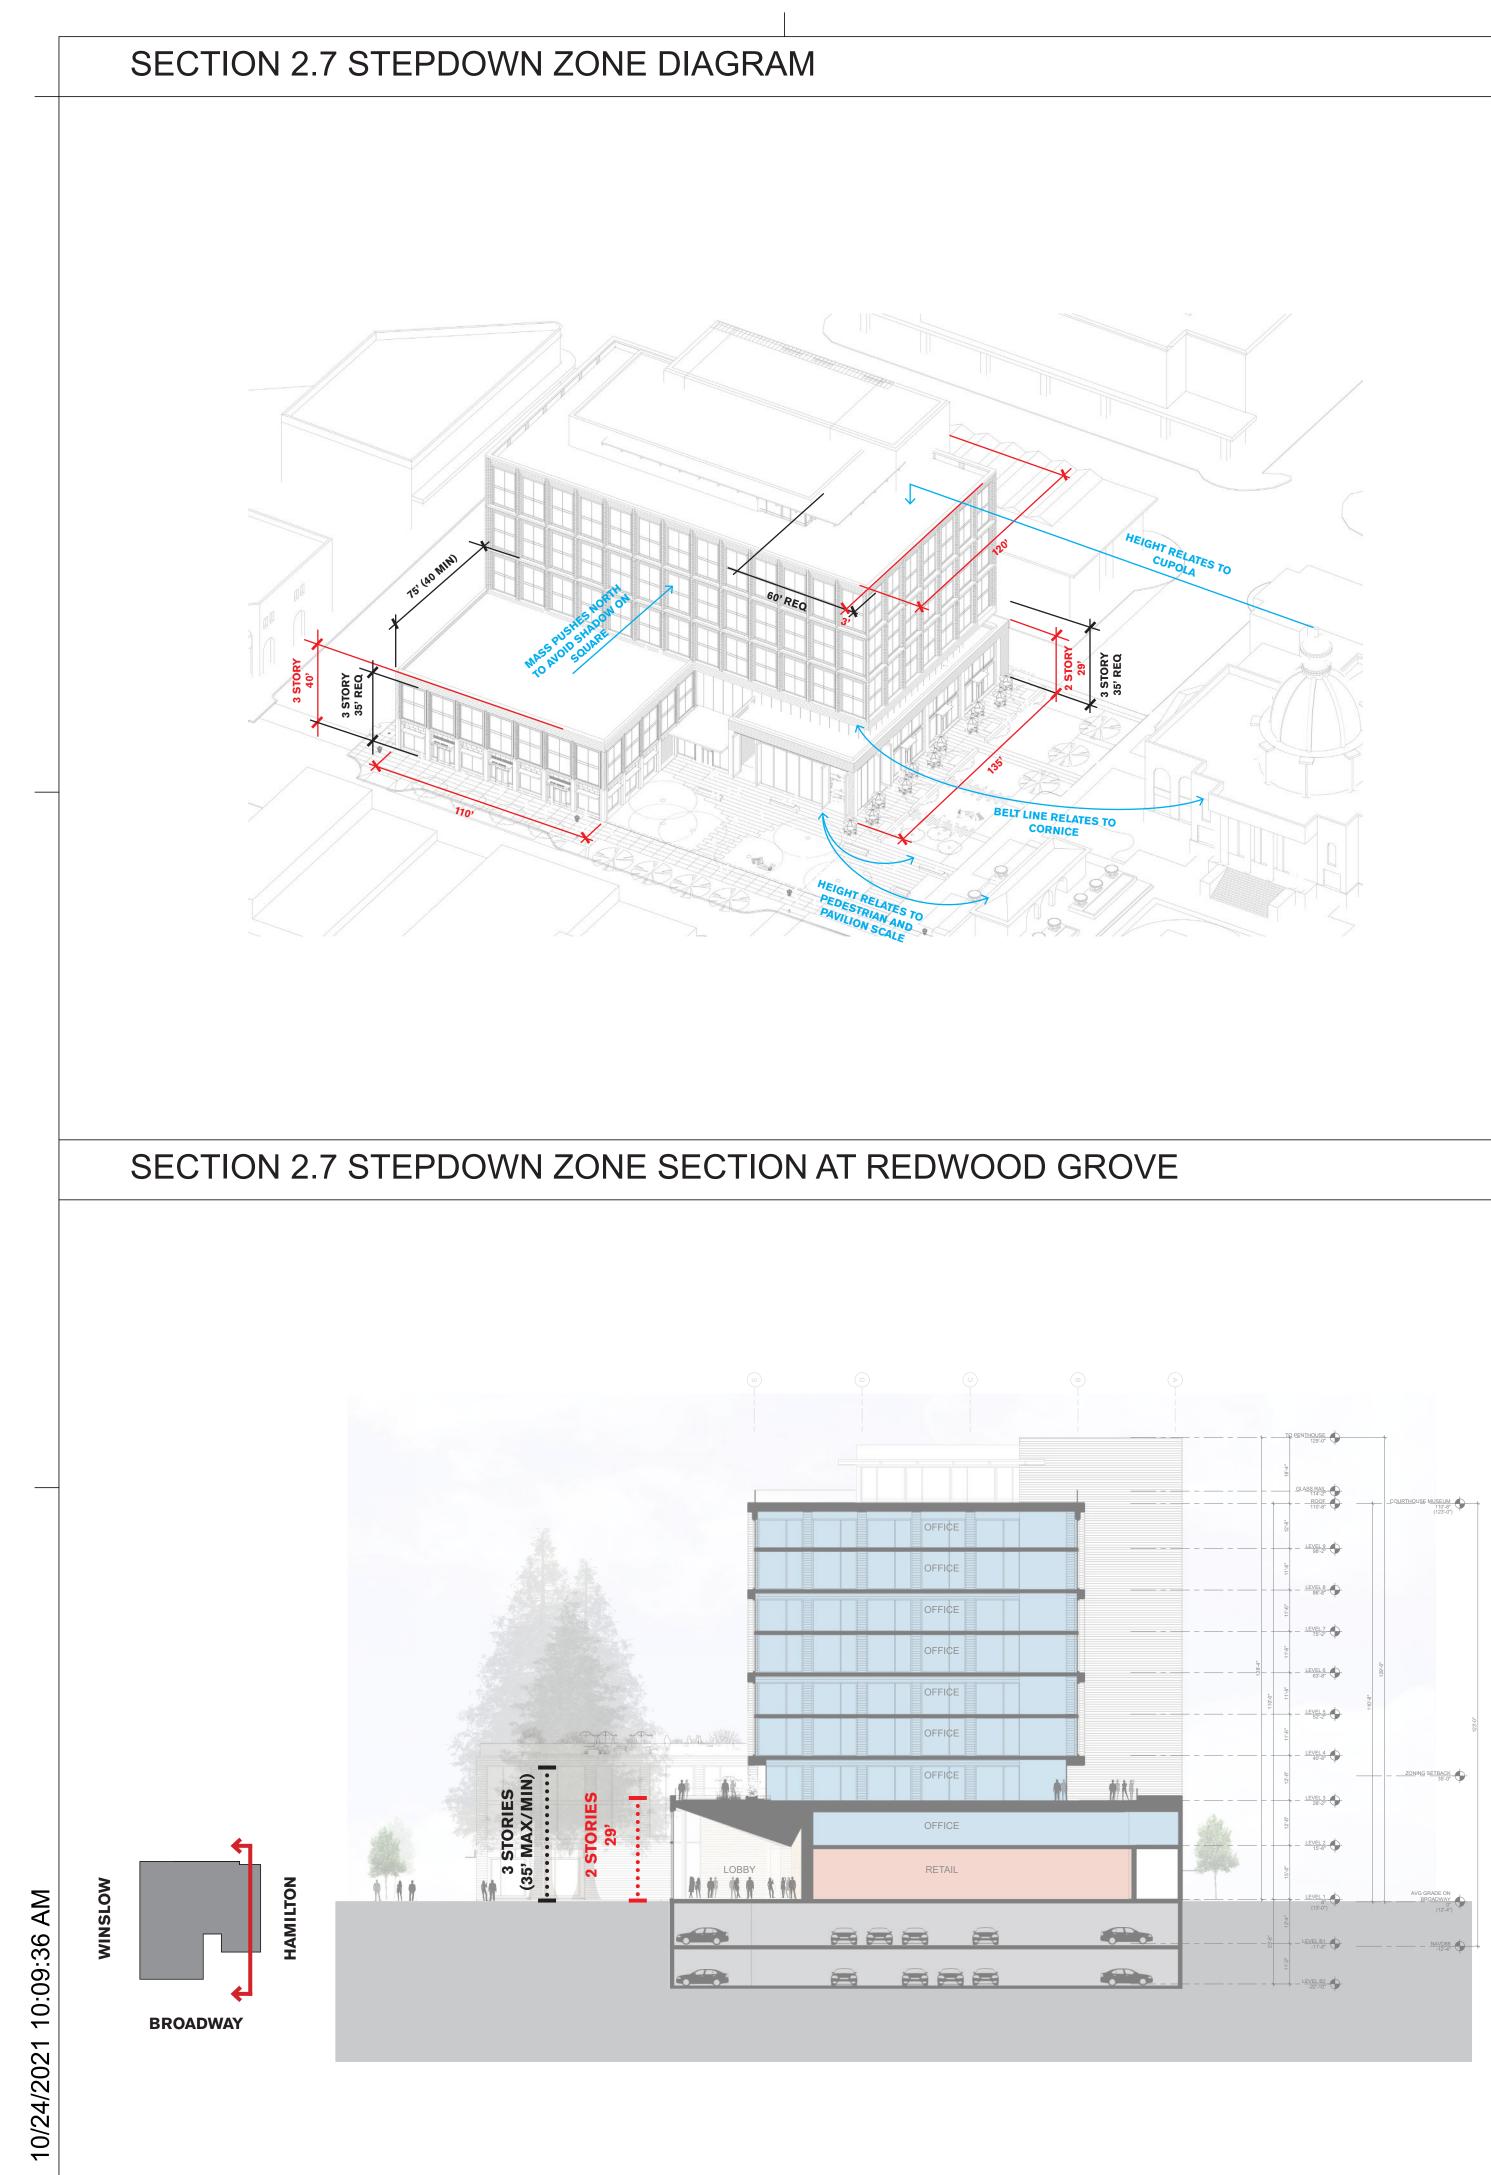
PROJECT NO.: 19046.00 DATE: 10/22/2021 SCALE:


SHEET TITLE:

DTPP COMPLIANCE **SECTION 2.7**

SHEET NO:


G-011



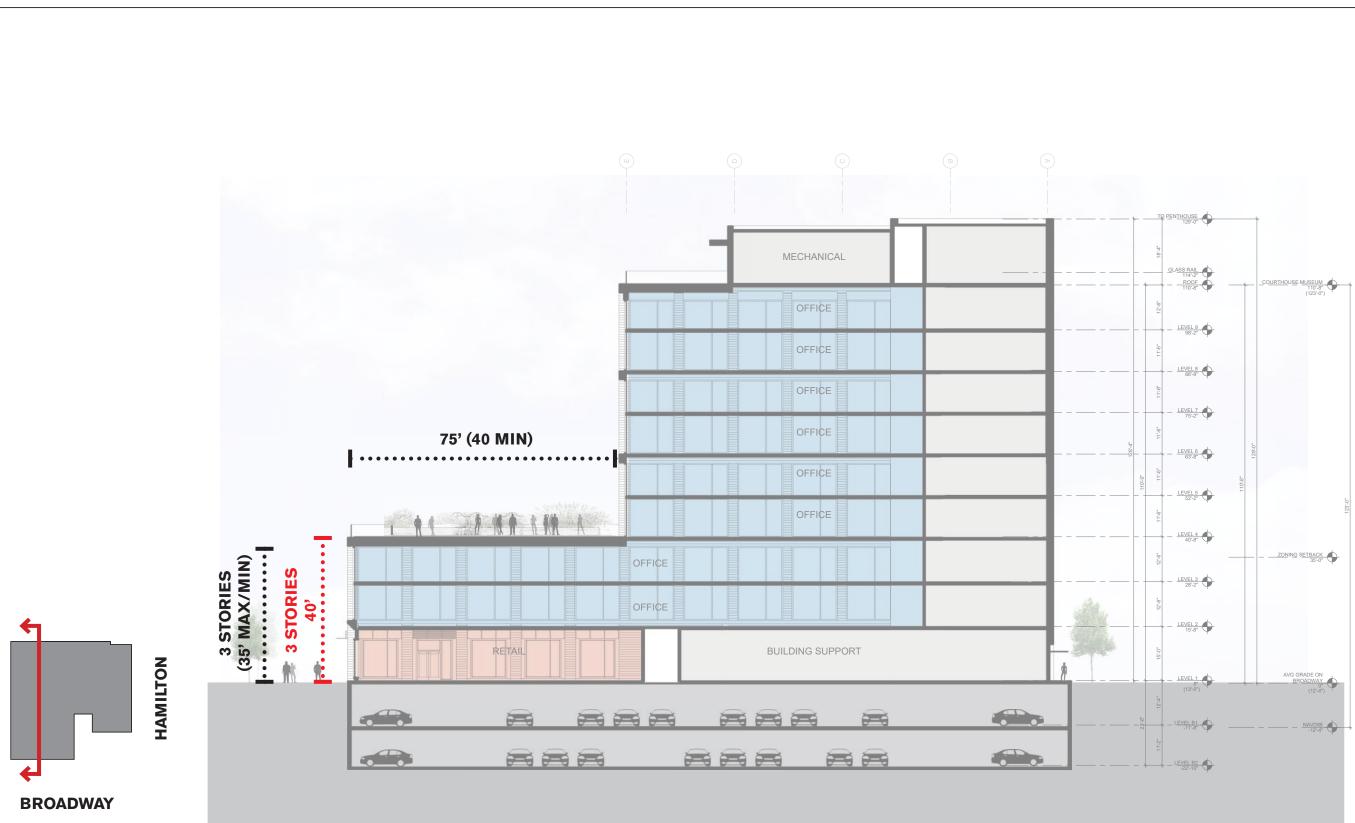

SECTION 2.7 STEPDOWN ZONE SECTION ALONG HAMILTON


WINSLOW

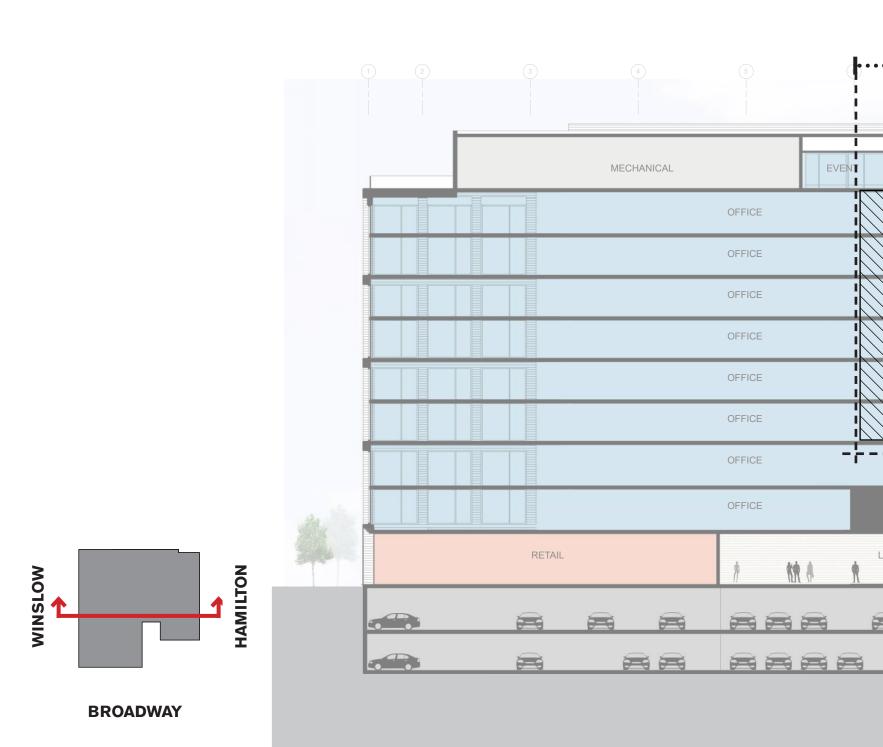

SECTION 2.7 STEPDOWN ZONE SECTION ALONG BROADWAY

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ISSUES PLANNING APPLICATION PLANNING APPLICATION #2	DATE 03/03/2021 10/22/2021
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DTPP COMPLIANCE **SECTION 2.7**

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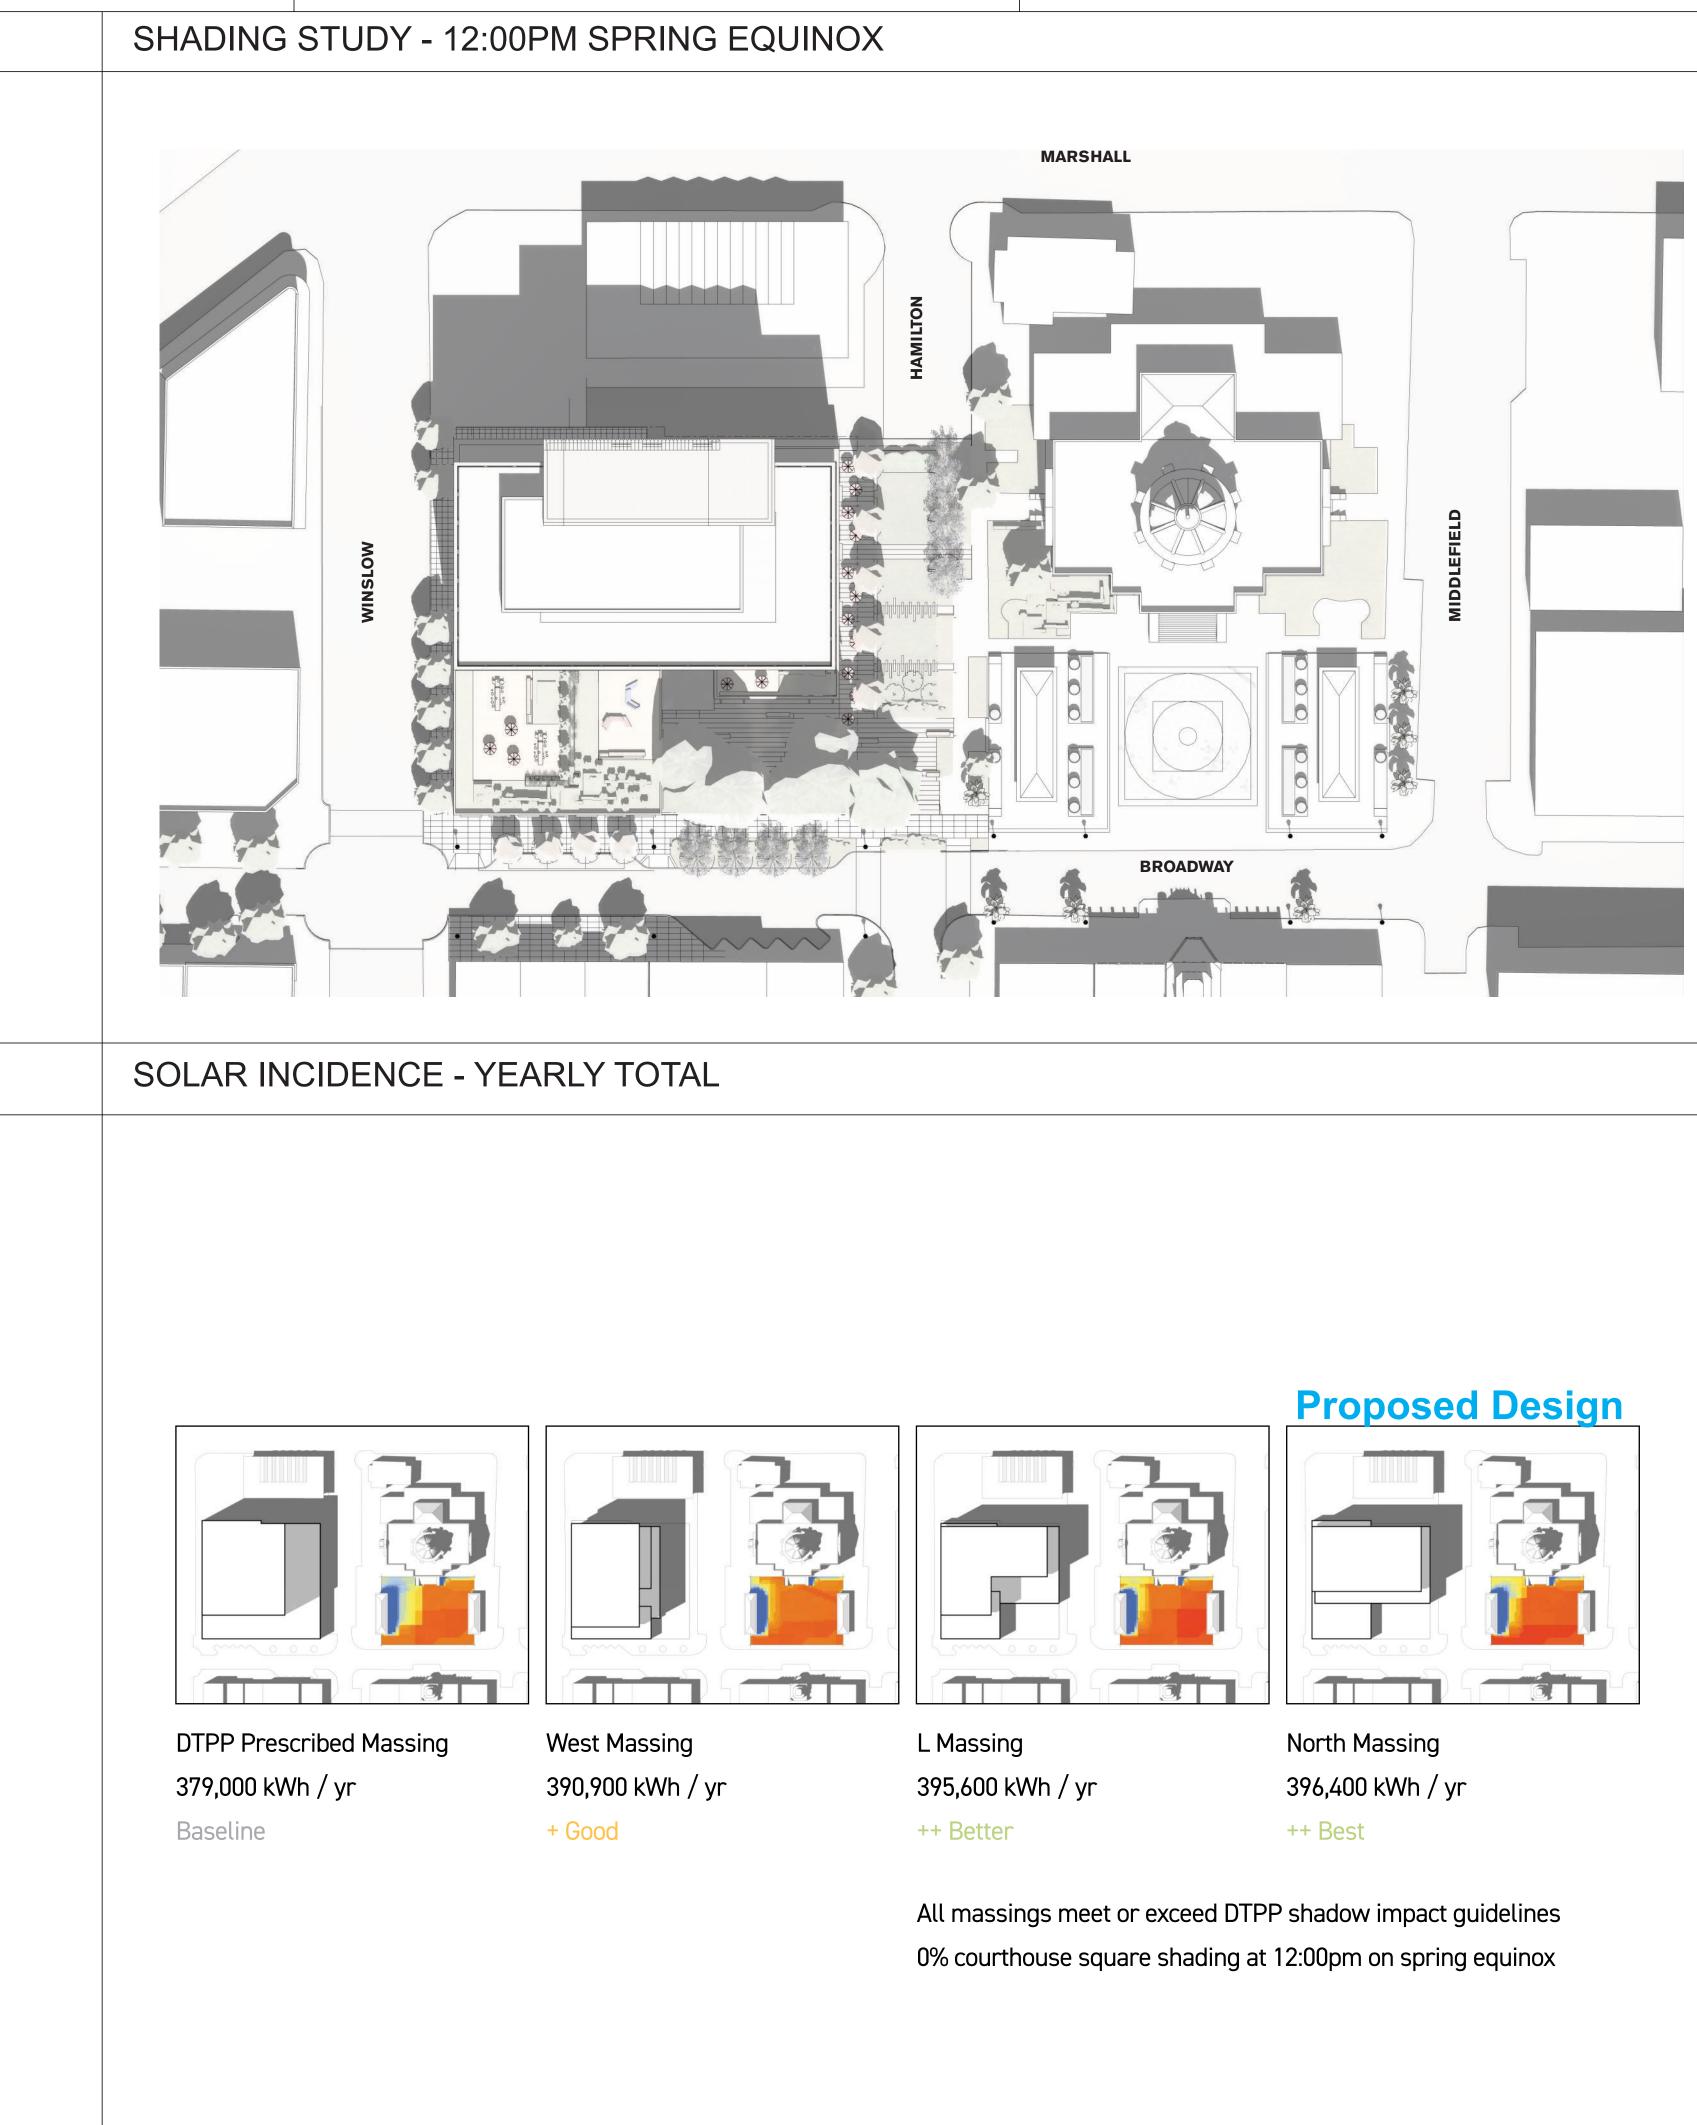
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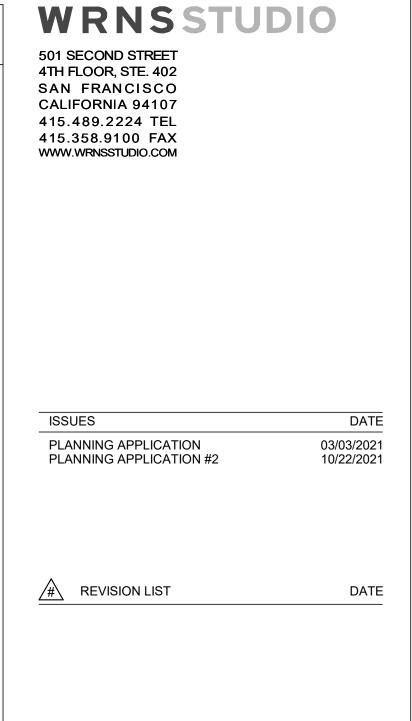
SECTIN 2.7.5 SHADING REQUIREMENTS

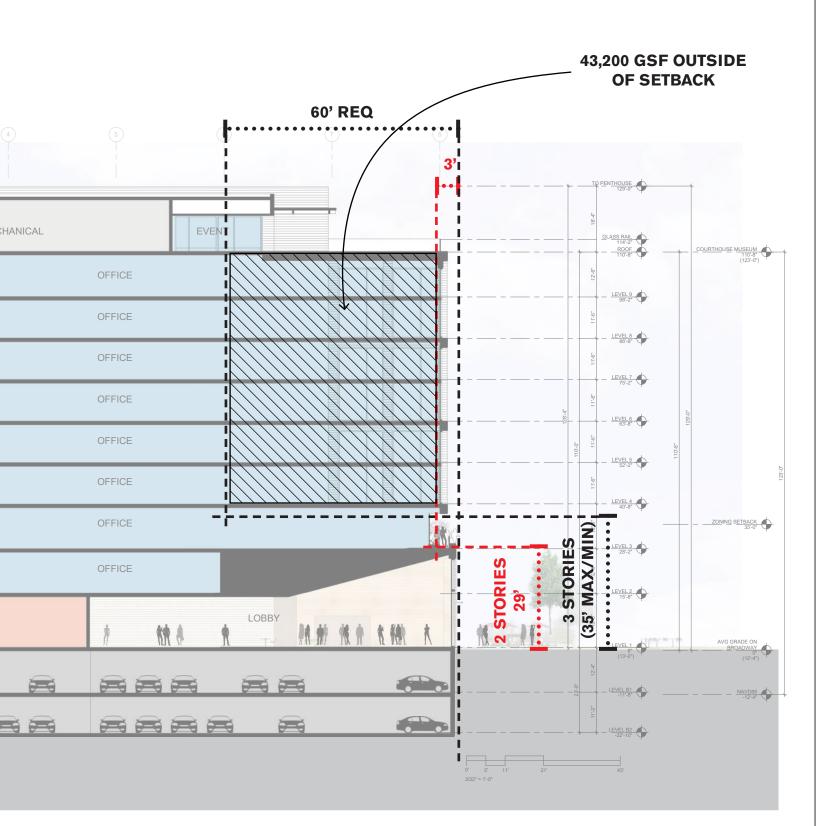GUIDELINES

DTPP 2.7.5 a. No new structure built within the Downtown Precise Plan Area should cause any of the following parcels and building elements to be more than 50% in shadow at 12:00pm on the Spring Equinox. Parcels and building elements which exceeded the shading standard at the time of the adoption of the Downtown Precise Plan shall not be subject to this policy. Maximum permitted heights have been calibrated in this Section to ensure that this guideline is met by all new development, which is studied in detail in the Environmental Impact Report. Compliance with subsections 2.7.1 through 2.7.3 of this Section shall therefore be suffcient to indicate compliance with this guideline.

- Shadow-sensitive public open spaces (Courthouse Square, Theatre Way, City Hall Park, Library Plaza, Hamilton Green, Depot Plaza, Little River Park, Redwood Creek, or City Center
- Plaza as shown on the Downtown Precise Plan Public Open Spaces Map)
- Downtown parcels with lower maximum permitted building heights adjacent to parcels with higher maximum permitted heights;
- Residential properties located outside but adjacent to the DTPP area; Light-sensitive features on historic resources; and
- Historic facades





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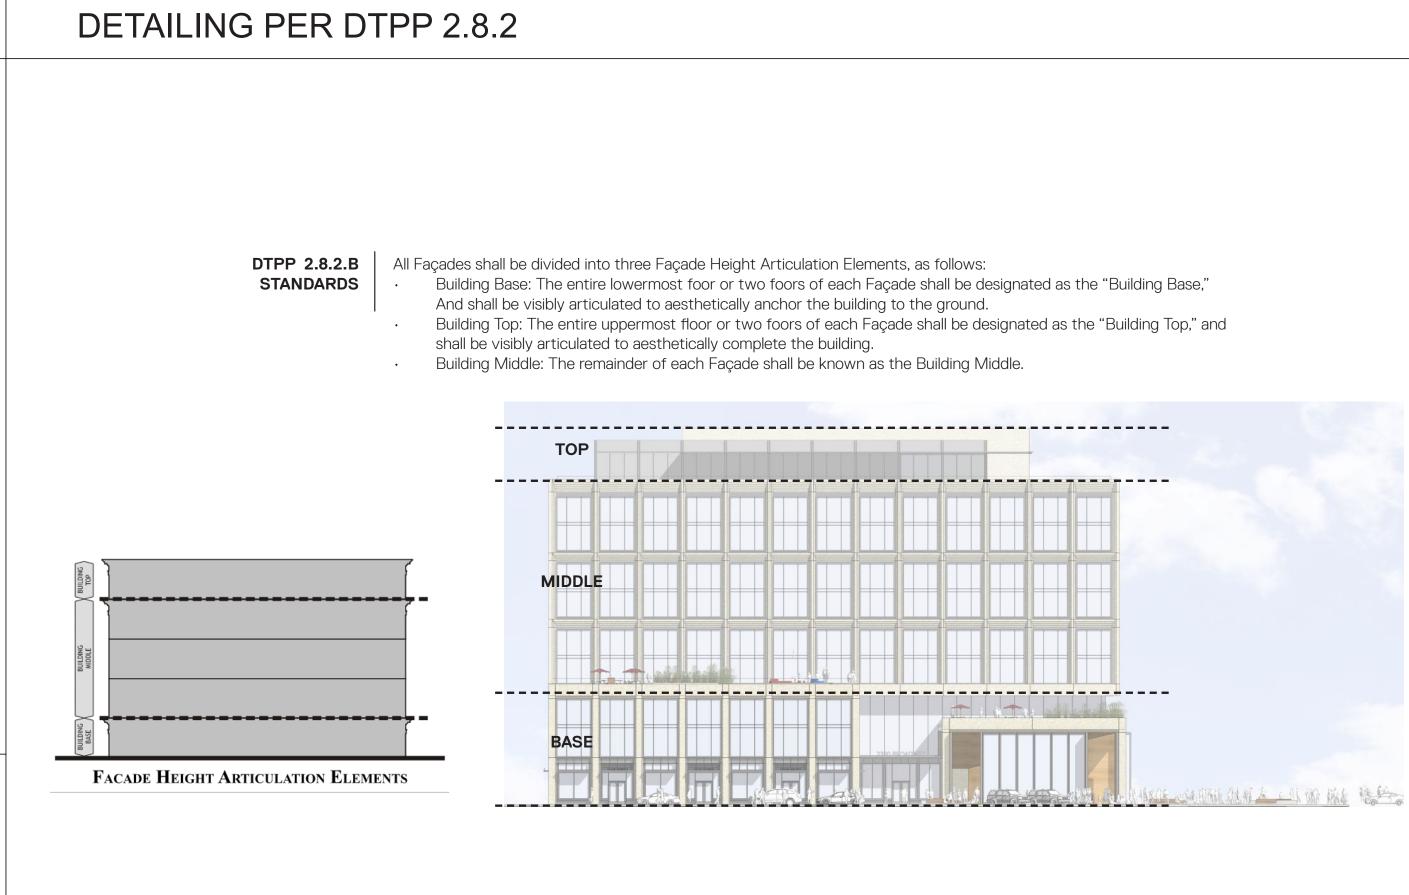
DTPP COMPLIANCE

G-013

SHEET NO:

SHEET TITLE:

SECTION 2.7.5



DTPP 2.8.3.A STANDARDS

A substantial horizontal articulation of the Façade shall be applied at the top of the Building Base, which will be known as the Building Base Cap. • The Building Base Cap should be no less than 2 feet in height.



BUILDING BASE CAP





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DETAILING PER DTPP 2.8.2

STANDARDS


consist of the following treatments:



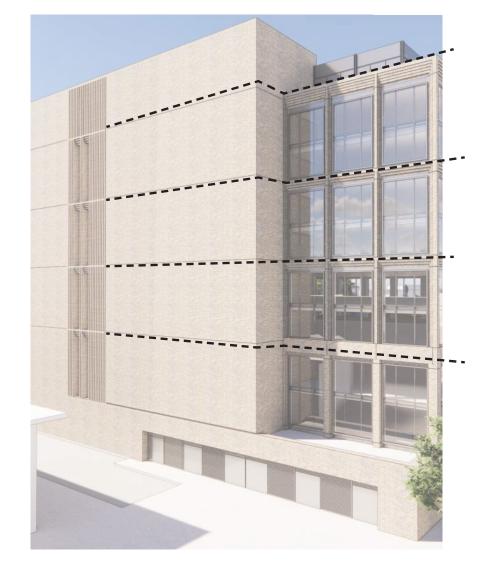

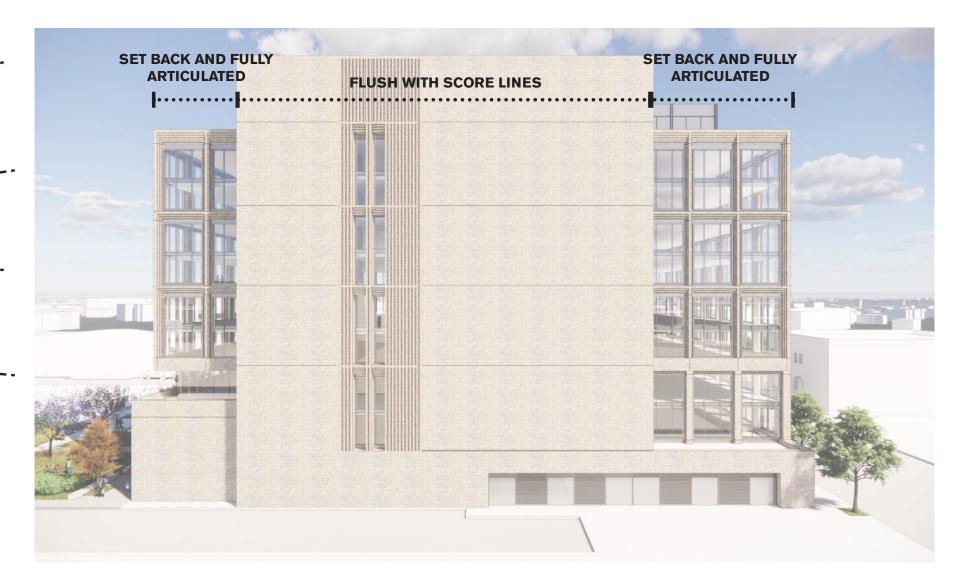DETAILING PER DTPP 2.8.3




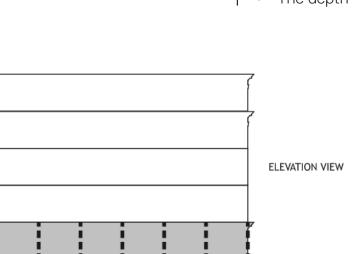

DTPP 2.8.3.C

STANDARDS

BUILDING BASE LENGTH ARTICULATION

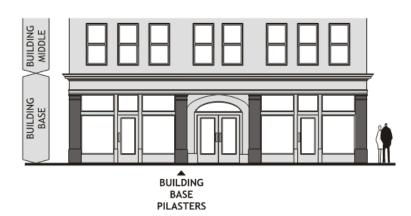

BUILDING BASE PILASTER

 The Building Base Length Articulations should be created using a pilaster. Building Base Pilasters should have the following characteristics:
 The horizontal width of a protruding pilaster or pier should be at least 18 inches wide, but should not exceed 4 feet in width. • The depth of the protruding pilaster should be at least 12 inches.



PLAN VIEW

DTPP 2.8.2.C When Sidewalls or Rearwalls are located less than 5 feet from a side or rear property line, or are located within a courtyard, Height Articulation using flush wall treatments is permitted. Flush wall treatment Height Articulations shall

• Horizontal score lines matching top, bottom, and/or other lines of Façade horizontal articulation.

ISSUES	DAT
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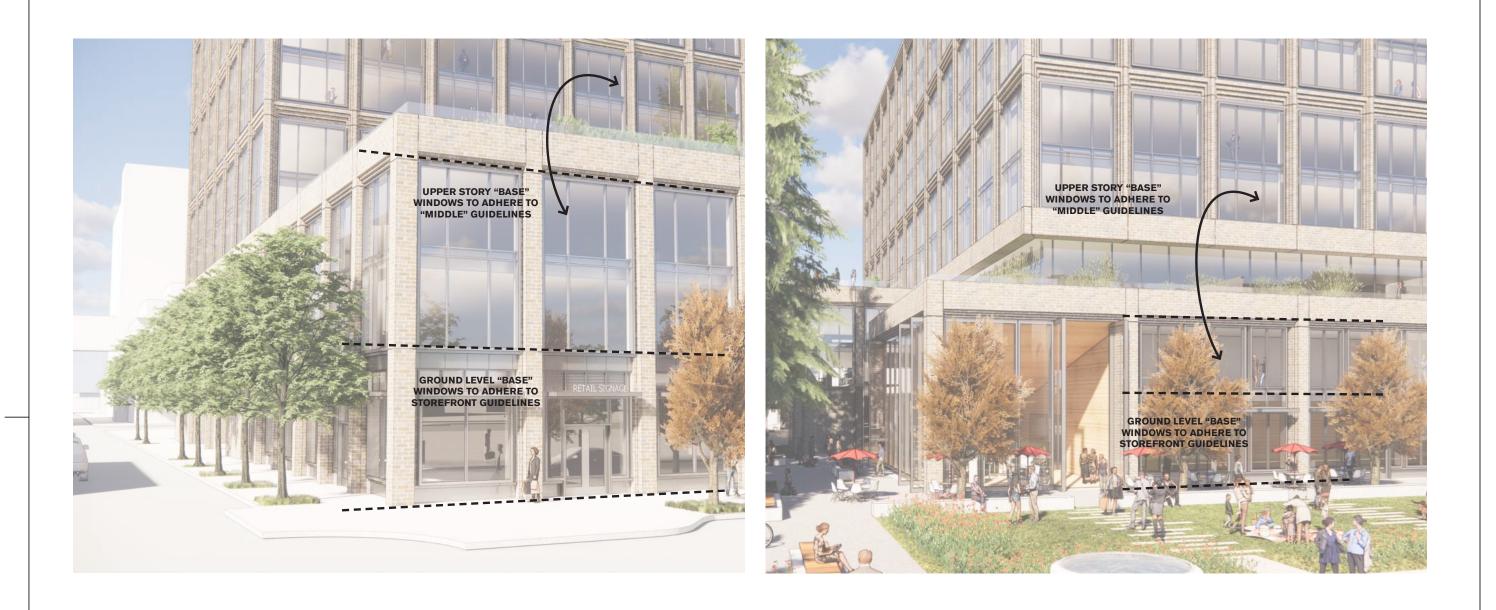
SHEET TITLE:

DTPP COMPLIANCE SECTION 2.8

SHEET NO:

G-014

DTPP 2.8.3.D For buildings with a two-story high Building Base, guidelines for second-foor windows shall be the same as the windows guidelines **GUIDELINES** for the Building Middle.




DETAILING PER DTPP 2.8.4

GUIDELINES

DTPP 2.8.4.A.2.B Each Storefront bay should contain the following elements:

• One entrance. Business occupying more than one bay, when permitted per Section 2.2.3, may be permitted to provide only one Storefront bay with a door, while the remaining Storefront bays may exclude doors. · Clerestory and/or transom windows. Where height permits, they should be used above doors and display windows to provide a continuous horizontal band or row of windows across the upper portion of a Storefront.

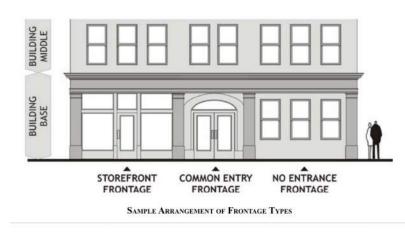



DETAILING PER DTPP 2.8.3

DTPP 2.8.3.E GUIDELINES


- These items should be located no lower than 8 feet above the sidewalk, and below the Building Base Cap. lights, or other vertical infrastructure.
- up Building Base Pilasters.



DETAILING PER DTPP 2.8.4

GUIDELINES

DTPP 2.8.4.A.2.D Storefront pilasters and Building Base Pilasters should have a maximum spacing of 15 feet within Storefront frontage areas.

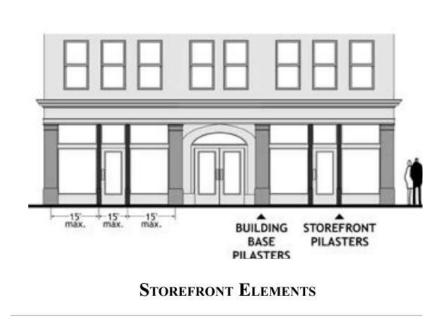



• Awnings and canopies should project no more than 6 feet into the setback or public right-of-way, and should not interfere with street trees,

 Colored fabric mounted awnings supported by a metal structural frame or permanent architectural awnings utilizing materials from the building architecture are both acceptable. Internally illuminated fabric awnings should not be used. • Discrete awnings or canopies should be used for each Building Base Bay, rather than one continuous run-on awning. Awnings should not cover

If this drawing is not 24"x36", then the drawing has been revised from its original size. Noted scales must be adjusted. This line should be equal to one inch	
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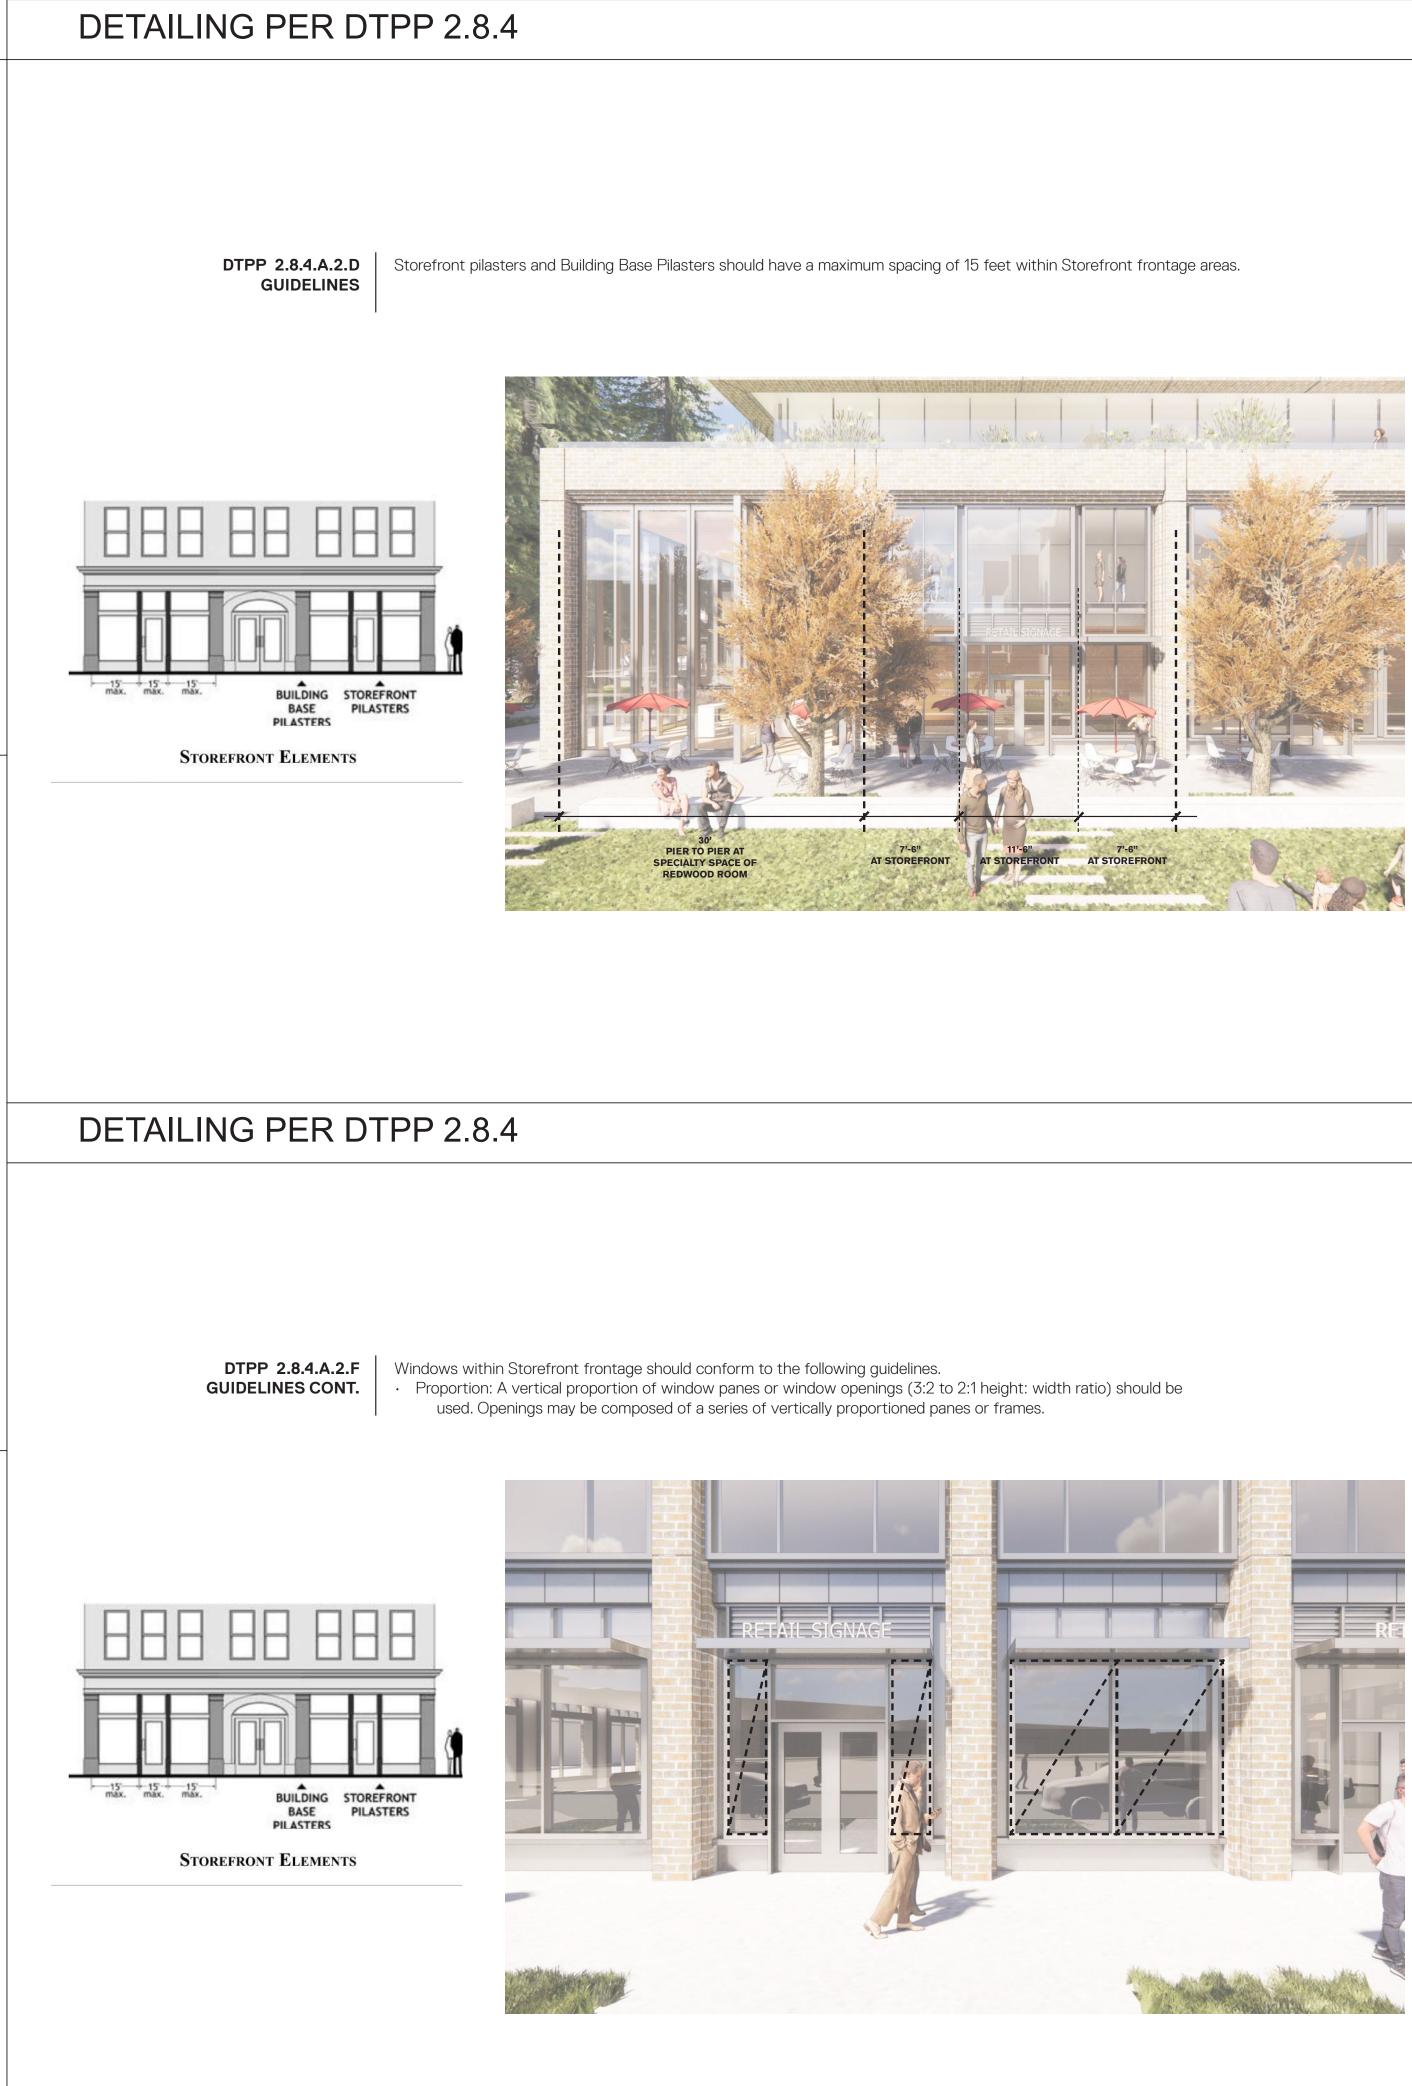
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DTPP COMPLIANCE SECTION 2.8

SHEET NO:





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DETAILING PER DTPP 2.8.4

DTPP 2.8.4.A.2.F

GUIDELINES




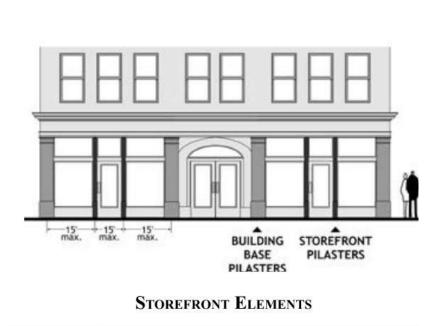

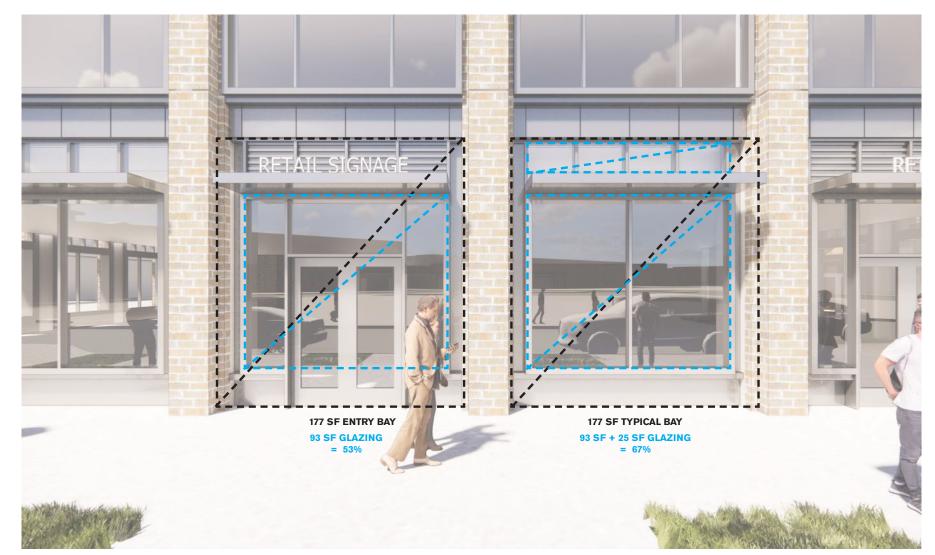DETAILING PER DTPP 2.8.4

GUIDELINES CONT.

DTPP 2.8.4.A.2.F Windows within Storefront frontage should conform to the following guidelines. • Depth of glazing: Window frames shall not be fush with walls. Glass should be inset a minimum of three (3) inches from the surface of the exterior wall and/or frame surface to add relief to the wall surface.

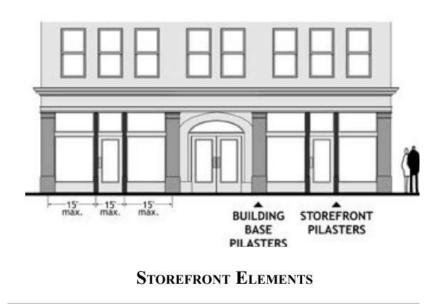



Windows within Storefront frontage should conform to the following guidelines.
 Glazing ratio: Overall wall composition within should contain at least 50%, but no more than 80% glazing

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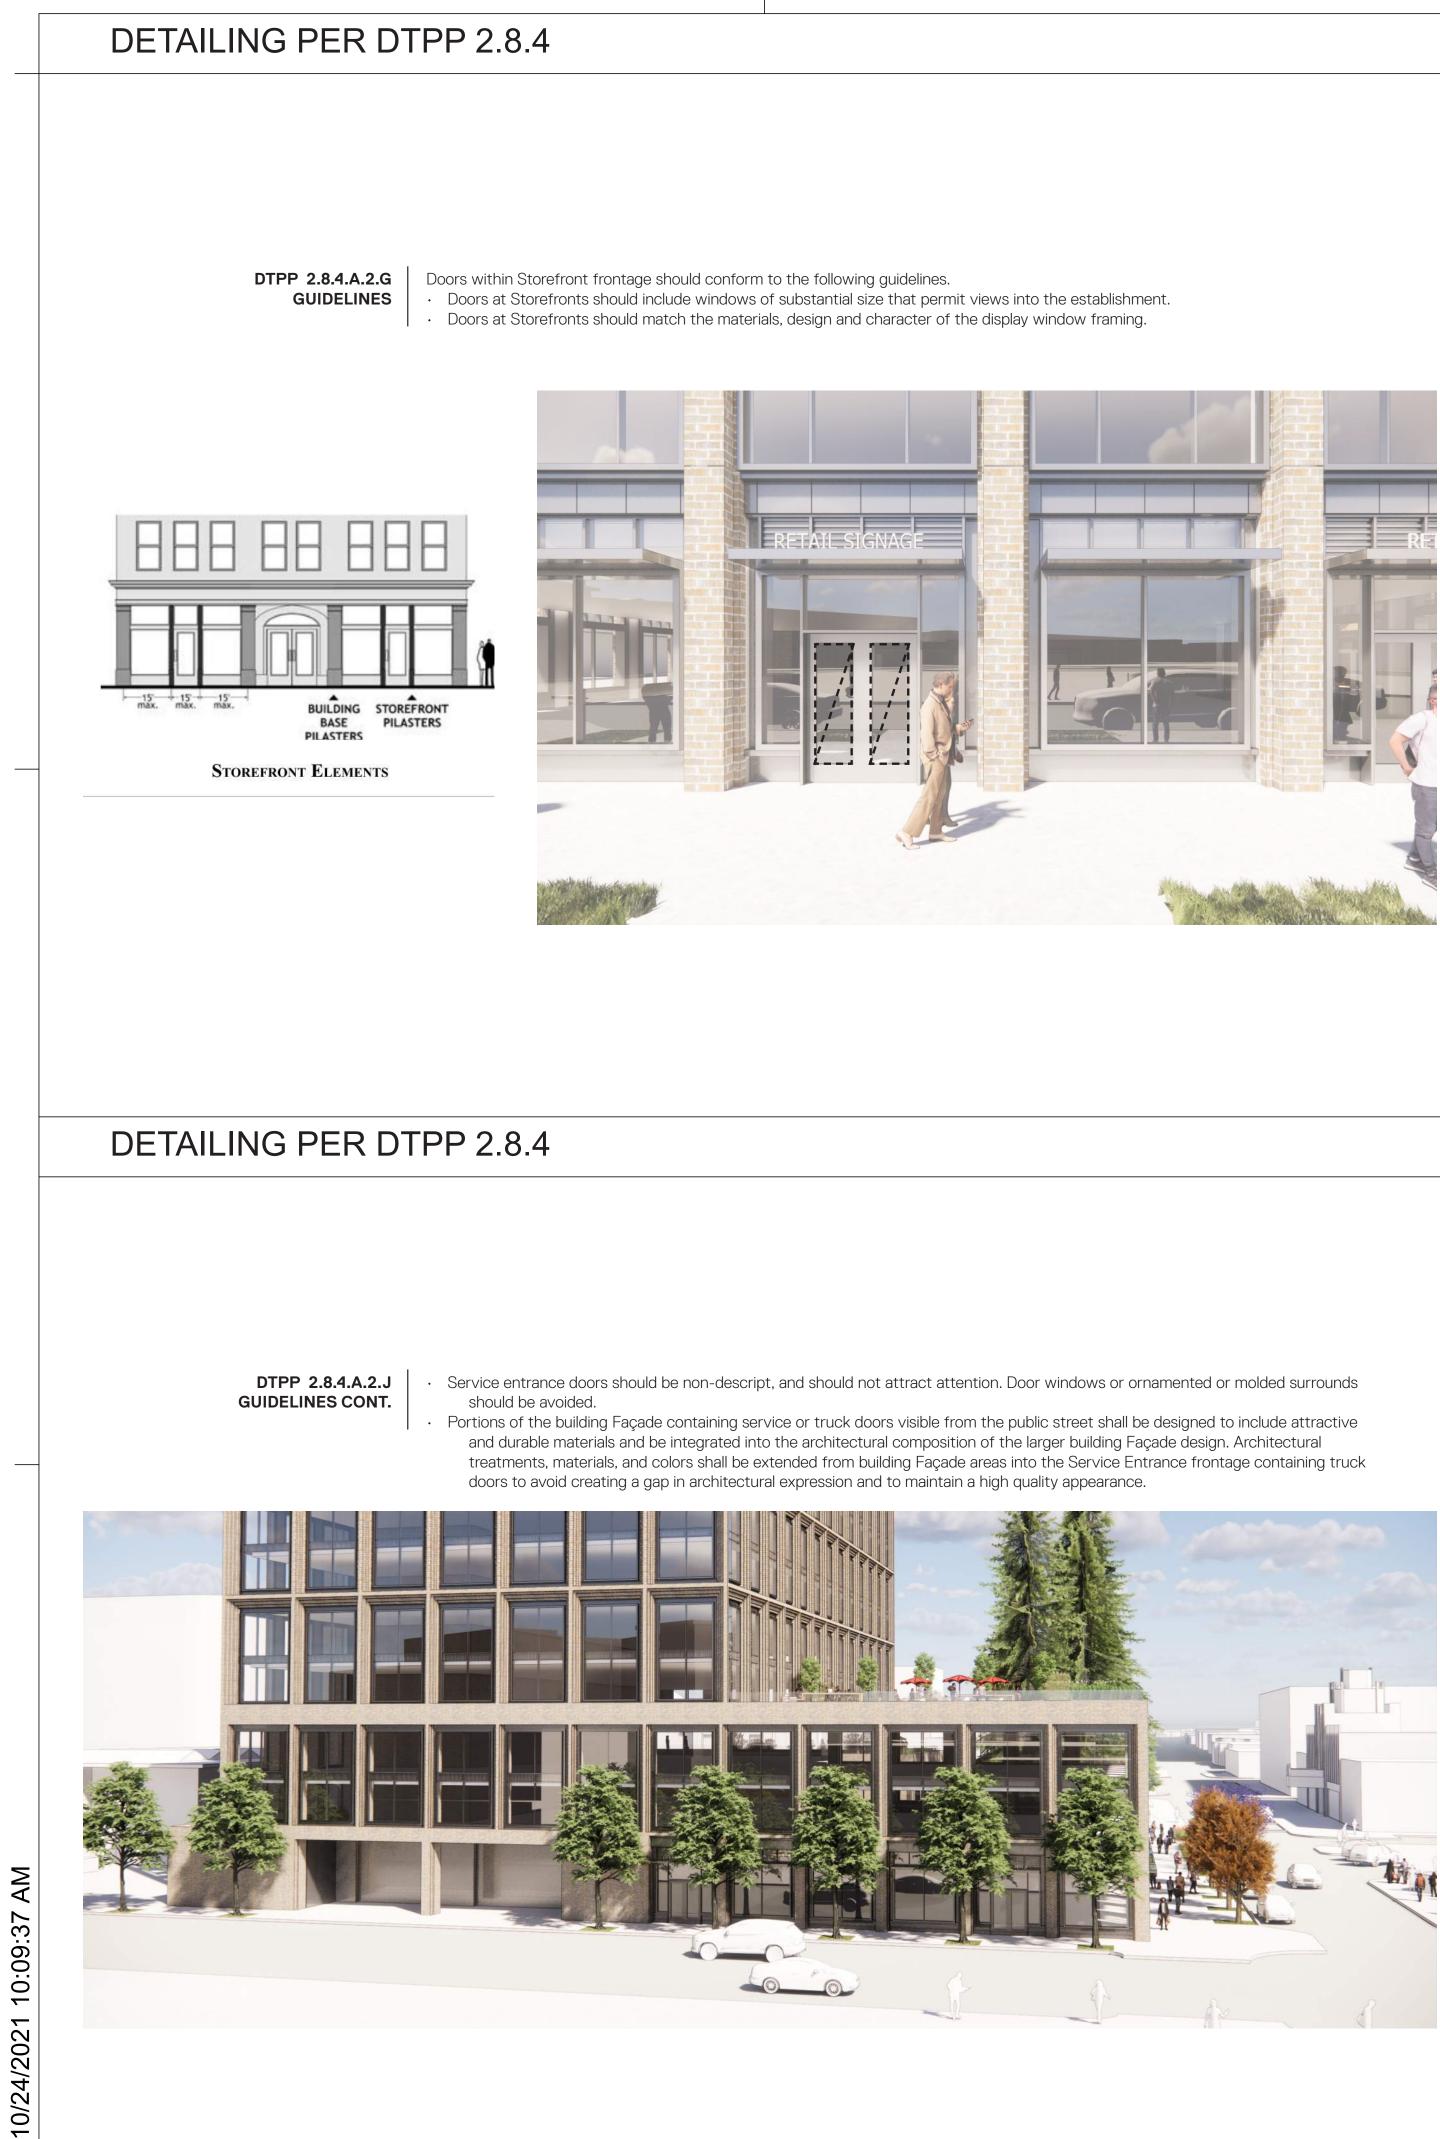
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DTPP COMPLIANCE **SECTION 2.8**


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DTPP 2.8.4.A.2.J GUIDELINES

access.


use



DETAILING PER DTPP 2.8.4

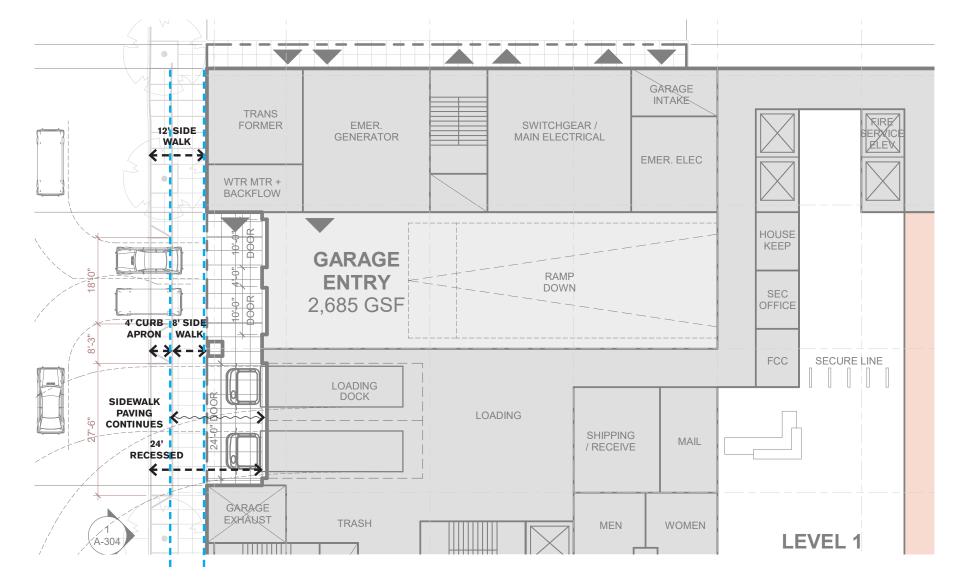GUIDELINES

DTPP 2.8.4.A.2.K A Garage Entrance provides access for vehicles into a parking garage. • For parcels occupying more than one Corridor Type, Secondary Entrances shall not face the highest order Corridor Type.

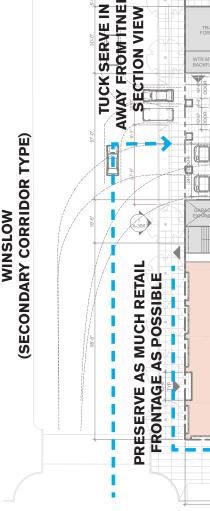

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A Service Entrance is an entrance which is used exclusively for the loading and unloading of wares, or as a fre exit, but which is not used for public • Setback areas must be paved or landscaped in accordance with the Private Frontage type used for the main entrance of the associated

• Loading and services entrances should not intrude upon the public view or interfere with pedestrian activities.

RETAIL 3,860 GSF LEVEL 1 32,363 GSF RETAIL 5,000 GSF RETAIL / 3,302 GS/F BROADWAY (HIGHEST CORRIDOR TYPE

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SHEET NO:


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GUIDELINES CONT.


DTPP 2.8.4.A.2.KA Garage Entrance provides access for vehicles into a parking garage.GUIDELINES CONT.· For all commercial use Garage Entrance doors, single-car garage doors are strongly recommended to avoid projecting an automobile-dominated appearance to the street or alley.



DETAILING PER DTPP 2.8.5

DTPP 2.8.5.B The maximum Façade Length Articulation Increment shall be as shown in the Façade Composition Regulations Chart STANDARDS according to Corridor Type.

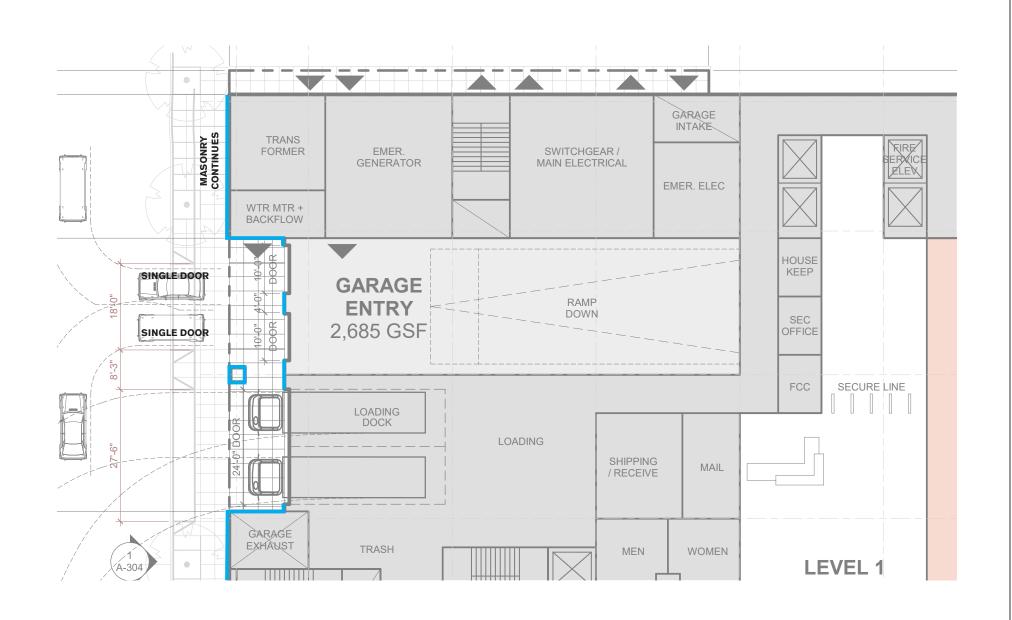- Measurement of the horizontal increment shall be from corner to corner for façade offsets, or from centerline to centerline for other articulations.
- Façade Length Articulations must be aligned vertically with Building Base Length Articulations.

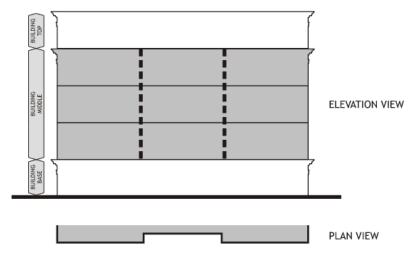

BUILDING MIDDLE LENGTH ARTICULATION




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DETAILING PER DTPP 2.8.5

DTPP 2.8.5.A STANDARDS

BUILDING




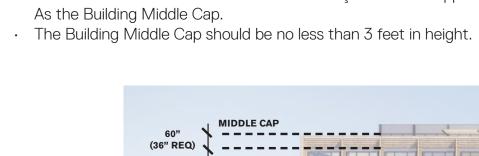

BUILDING MIDDLE CAP


BUILDING MIDDLE

DETAILING PER DTPP 2.8.5

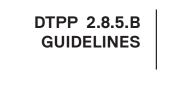

• The Building Middle Length Articulations should be created using façade offsets, which are slight recesses in the wall plane (see Building Middle Length Articulation Graphic). • The depth of a façade off set shall be a minimum of one foot, and should not be more than 5 feet. The offset should be vertically straight and should run the full height of the Building Middle.



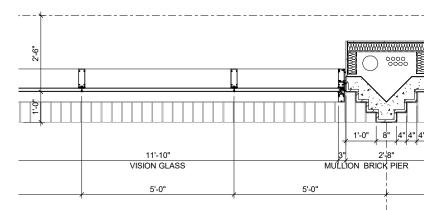

BUILDING MIDDLE LENGTH ARTICULATION

ELEVATION VIEW

PLAN VIEW

If this drawing is not 24"x36", then the drawing has been revised from its original size. Noted scales must be adjusted. This line should be equal to one inch

1'-0" 8" 4" 4" 4" 5'-0" 5'-0" 27'-10" CORNER BAY, ALL OTHERS 30' OC

Building Middle Caps provide a visual termination to the Building Middle, providing a strong accentuation to the Building Top.
 A substantial horizontal articulation of the Façade shall be applied at the top of the Building Middle, which will be known

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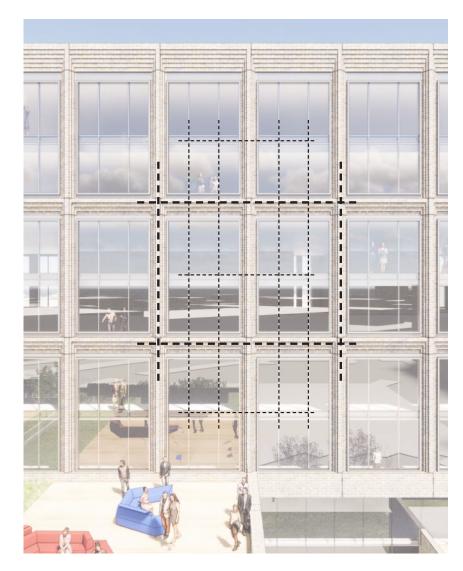
DTPP COMPLIANCE **SECTION 2.8**


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GUIDELINES

DTPP 2.8.5.E Windows are important to visually organizing a façade and to promoting interaction between the public realm and the private realm.

> • Overall wall composition within for Building Middles should contain at least 30%, but no more than 60% glazing. • A vertical proportion of window panes or window openings (3:2 to 2:1 height: width ratio) should be used. • Windows should generally maintain consistency in size, shape, and location across a façade. Unifying patterns should include a common window lintel line and sill line, as well as aligned vertical centerlines of windows and doors, creating a harmonious pattern across the street wall.




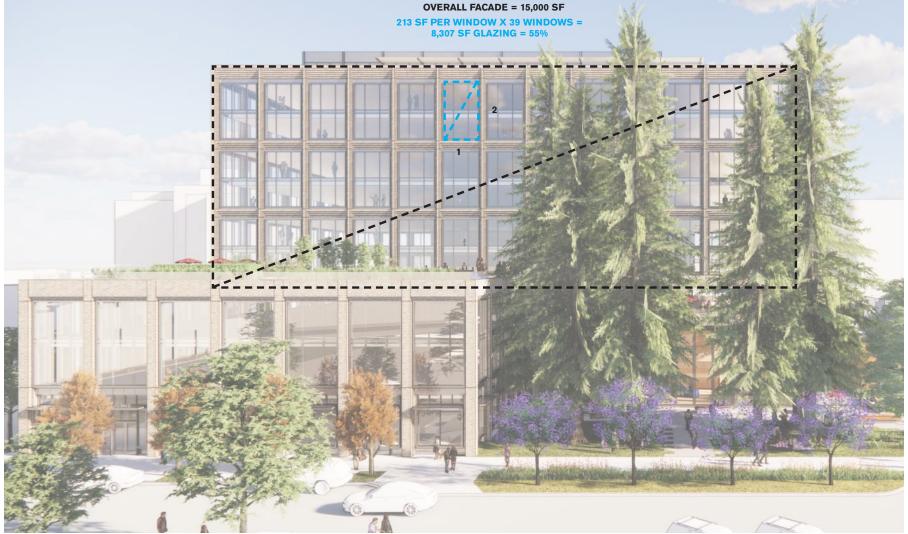

DETAILING PER DTPP 2.8.6

DTPP 2.8.6.B STANDARDS

- The maximum Façade Length Articulation Increment shall be as shown in the Façade Composition Regulation Chart ccording to Corridor Type.
- Measurement of the horizontal increment shall be from corner to corner for façade offsets, or from centerline to centerline for other articulations.
- Façade Length Articulations must be aligned vertically with Building Middle Length Articulations.

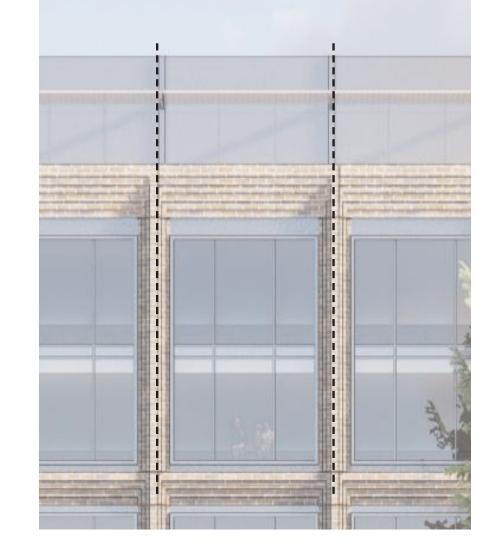




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DETAILING PER DTPP 2.8.6

DTPP 2.8.6.A STANDARDS

• A substantial horizontal articulation of the Façade shall be applied at the top of the Building Top, which will be known as the Building Top Cap. • The Building Top Cap should be no less than 4 feet in height



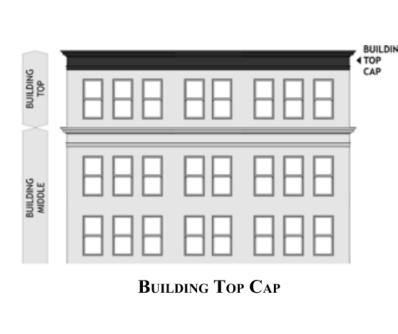

TOP CAP READ 1




TOP CAP READ 2


DETAILING PER DTPP 2.8.6

DTPP 2.8.6.B

GUIDELINES

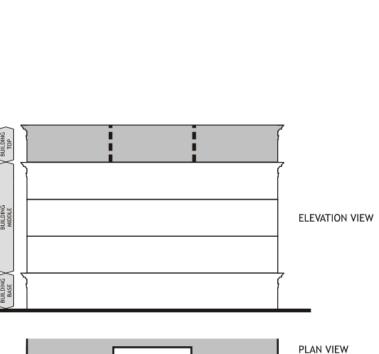

(see the Building Top Length Articulation Graphic). • The depth of a façade off set shall be a minimum of one foot, and should not be more than 5 feet. The offset should be vertically straight and should run the full height of the Building Top.

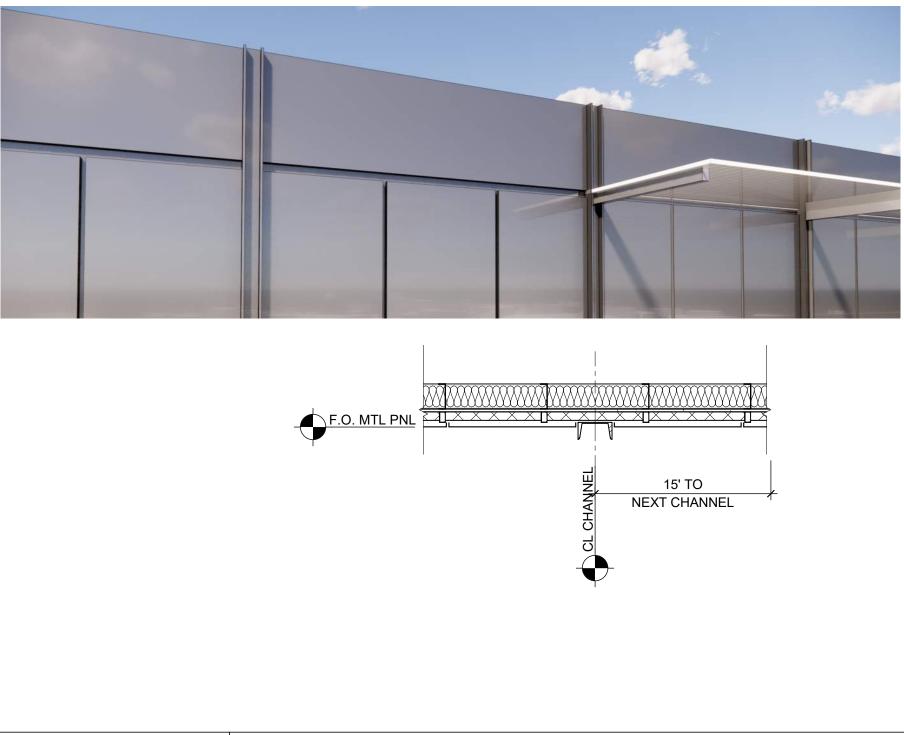

BUILDING TOP LENGTH ARTICULATION

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• The Building Top Length Articulations should be created using façade offsets, which are slight recesses in the wall plane

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DTPP COMPLIANCE **SECTION 2.8**

SHEET NO:

G-019

DTPP 2.9.3.E - GUIDELINE 2.A Roofs should be flat, with an ornamented parapet





HISTORICAL PRECEDENT REDWOOD CITY



MODERN PRECEDENT **GROSS BLEICHEN 19** HAMBURG, GERMANY



PROJECT RESPONSE

DTPP 2.9.3.E - GUIDELINE 2.C



HISTORICAL BRICK PRECEDENT ROOSEVELT JUNIOR HIGH SAN FRANCISCO



HISTORICAL BRICK PRECEDENT SEQUOIA HOTEL



Façade Height Articulation Element, but materials may vary from element to element.

MODERN BRICK PRECEDENT UNKNOWN - MENDELSON



PROJECT RESPONSE



HISTORICAL PRECEDENT 450 SUTTER SAN FRANCISCO

be an ornamented frieze or shaped parapet.



MODERN PRECEDENT BRUCE C. BOLLING MUNICIPAL BUILDING BOSTON

Wall cladding should be brick, stone, stucco, terra cotta, or ceramic tile. Only one primary cladding material should be used within each



HISTORICAL PRECEDENT CHRYSLER BUILDING NEW YORK

DTPP 2.9.3.E - GUIDELINE 2.D Trim materials should be stucco, ceramic tile, terra cotta, or polished metal. Multiple trim materials may be used.




MODERN PRECEDENT 180 E 88TH NEW YORK

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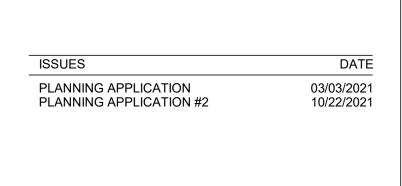
DTPP 2.9.3.E - GUIDELINE 2.B Building Base and Building Middle Caps shall be simple horizontal belt courses or an ornamented frieze. Building Top Cap should



PROJECT RESPONSE

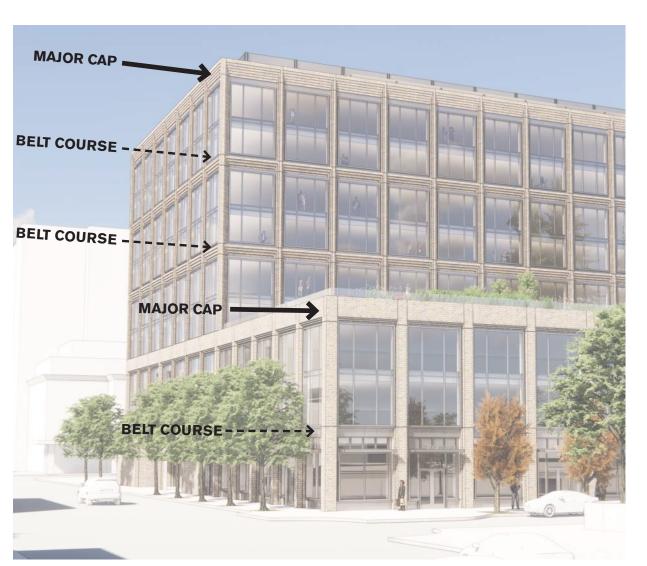

PROJECT RESPONSE



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DTPP COMPLIANCE **SECTION 2.9**

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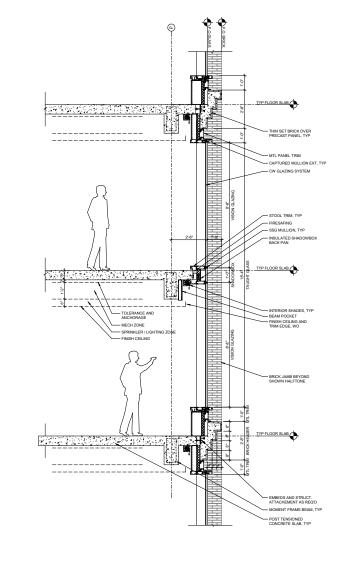
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Ornamental spandrel panels should be applied above and below windows and as Building Top Caps, creating the appearance of vertical bands.

DTPP 2.9.3.E - GUIDELINE 2.E



HISTORICAL PRECEDENT ROOSEVELT JUNIOR HIGH SAN FRANCISCO



CONCEPT SECTION DETAIL




PROJECT RESPONSE

CONTINUED

DTPP 2.9.3.E - GUIDELINE 2.E | Bas relief ornamental motifs of Art Deco—such as fan-like shapes, zigzag elements, sunbursts, chevrons, stepped arches, and stylized foliage—should be used.



HISTORICAL PRECEDENT 501 MADISON AVE NEW YORK

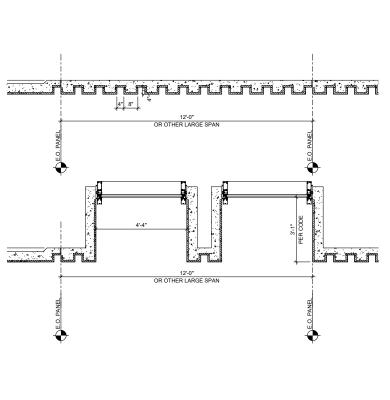

CONCEPT PLAN DETAIL



PROJECT RESPONSE


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HISTORICAL PRECEDENT REDWOOD CITY


DTPP 2.9.3.E - GUIDELINE 2.E Ornamental spandrel panels should be applied above and below windows and as Building Top Caps, creating the appearance of vertical bands.




PROJECT RESPONSE

DTPP 2.9.3.E - GUIDELINE 2.F

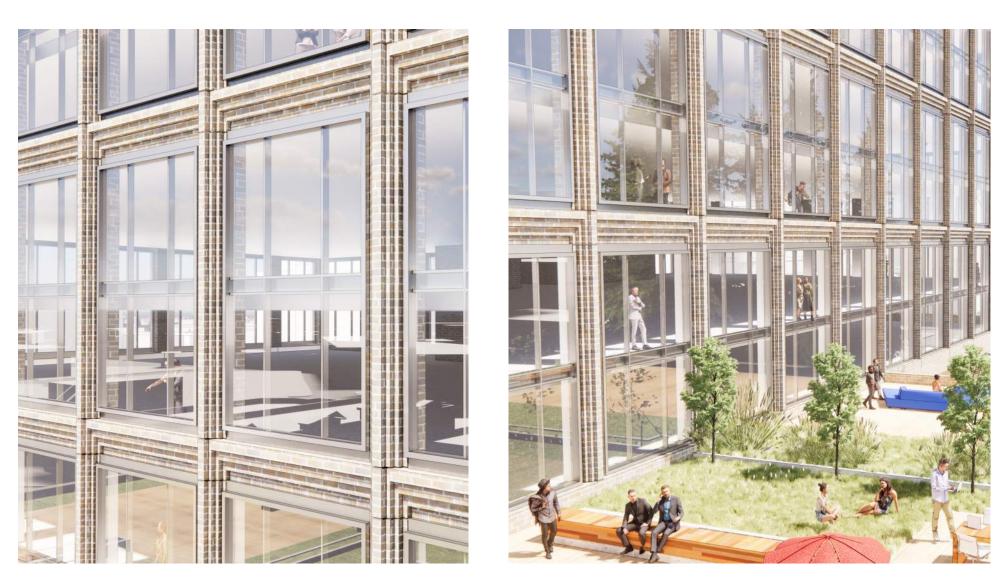Verticality should be emphasized with angled or stepped pilasters running vertically through the entirety of Height Articulation Components, or the entire façade located between each vertical row of windows, or every other vertical row of windows.

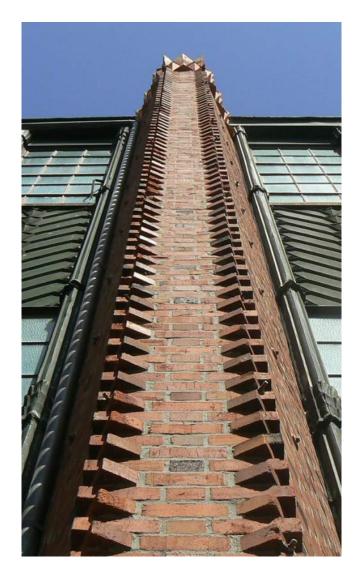


HISTORICAL PRECEDENT ROOSEVELT JUNIOR HIGH SAN FRANCISCO

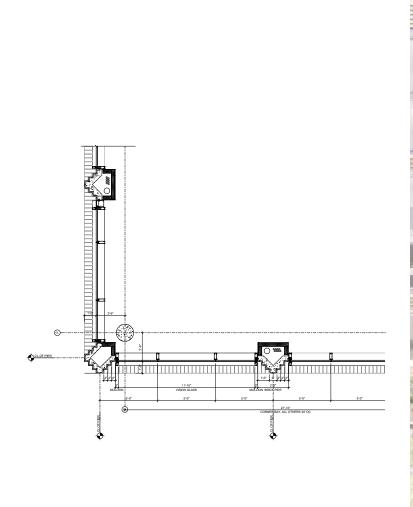


CONCEPT DETAILING

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PROJECT NO.: 19046.00 DATE: 10/22/2021 SCALE:

SHEET TITLE:

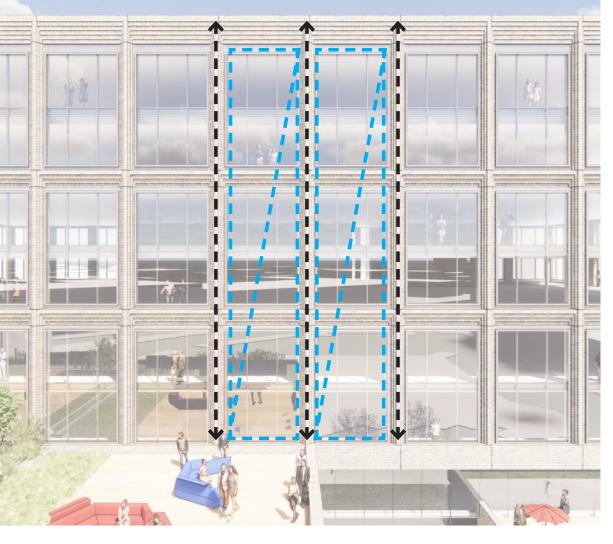DTPP COMPLIANCE **SECTION 2.9**

SHEET NO:

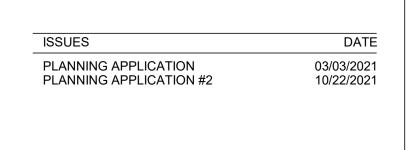G-021

Terminate directly below the Building Top Cap, creating the impression of a supporting column. In this case, the face of the pilasters should be fush with the face of the Building Top Cap in plan, and should be capped with a base relief capital featuring and two-dimensional ionic capital or other Art Deco motif.



PROJECT RESPONSE

CONCEPT DETAIL



DTPP 2.9.3.E - GUIDELINE 2.F

CONTINUED

HISTORICAL PRECEDENT REDWOOD CITY

DTPP 2.9.3.E - GUIDELINE 2.H Bay windows should be polygonal in plan. The angles of the inside corners of the bay should be 135 degrees. (NOT APPLICABLE) **DTPP 2.9.3.E - GUIDELINE 2.I** Window shapes should be simple and rectangular.



HISTORICAL PRECEDENT DUMONT BUILDING NEW YORK



MODERN PRECEDENT TURNMILL BUILDING LONDON




PROJECT RESPONSE



HISTORICAL PRECEDENT 450 SUTTER SAN FRANCISCO

(**REPEAT OF 2.B**) ornamented friezes featuring ornamental spandrel panels.

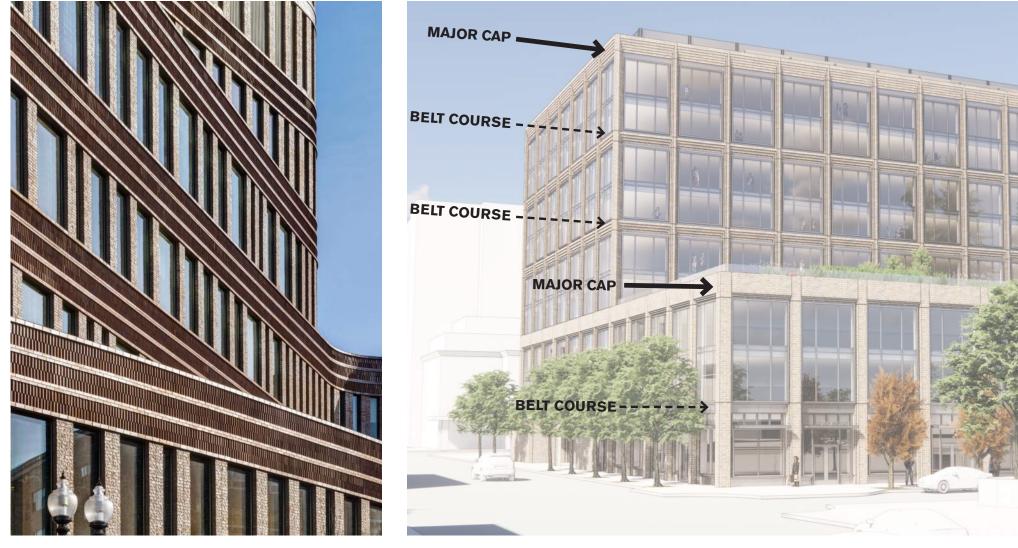

MODERN PRECEDENT BRUCE C. BOLLING MUNICIPAL BUILDING BOSTON



CHICAGO WINDOW PRECEDENT RELIANCE BUILDING



NON DOUBLE HUNG PRECEDENT REDWOOD CITY

DTPP 2.9.3.E - GUIDELINE 2.J Building Middle and Building Top windows should be clear and should not be tinted, should be inset a minimum of 3 inches from the adjacent wall plane, and should be of the double- or single-hung type.



NON DOUBLE HUNG PRECEDENT 450 SUTTER



BUILDING



601 MARSHALL

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DTPP 2.9.3.E - GUIDELINE 2.G Building Base and Building Middle Caps shall be simple horizontal belt courses or a stepped cornice. Building Top Caps should be

PROJECT RESPONSE

CHICAGO WINDOW PRECEDENT SULLIVAN CARSON PIRIE SCOTT



NON DOUBLE HUNG PRECEDENT



PROJECT RESPONSE

DATE
3/2021 2/2021

REVISION LIST

DATE

2300 BROADWAY Redwood City, CA

KEYPLAN

PROJECT NO.: 19046.00 DATE: 10/22/2021 SCALE:

SHEET TITLE:

DTPP COMPLIANCE **SECTION 2.9**

SHEET NO:

G-022

DTPP 2.9.3.E - GUIDELINE 2.K Building Middle and Building Top windows should feature a prominent but simple sill and little or no surround and lintel.



HISTORICAL PRECEDENT REDWOOD CITY



UNACCEPTABLE EXAMPLE CARLSBERG APARTMENTS CARLSBERG



PROJECT RESPONSE

DETAILING PER DTPP 2.10.3

DTPP 2.10.3.J STANDARDS & GUIDLELINES

- Above Awning Signs shall not exceed one and one-half (1½) times the valance height, and width shall not exceed two-thirds (2/3) of the awning width.
- Above Awning Signs shall project no farther from the building than its associated awning. • Lettering for Above Awning Signs shall include one (1) line of lettering only.
- Materials used in Above Awning Signs should be wood, metal, and paint only.



DTPP 2.9.3.E - GUIDELINE 2.L | Wall colors should be limited to white, tan, or light pastel colors. Only one primary wall color material should be used within each Façade Height Articulation Element, but colors may vary from element to element.



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POTENTIAL BRICK COLOR RANGE - FINAL COLOR AND TEXTURE TO BE DETERMINED IN SUBSEQUENT SUBMISSIONS

ISSUES	DATE
PLANNING APPLICATION PLANNING APPLICATION #2	03/03/2021 10/22/2021
	DATE
	DATE



KEYPLAN


PROJECT NO.: 19046.00 DATE: 10/22/2021 SCALE:

SHEET TITLE:


DTPP COMPLIANCE SECTION 2.9 & 2.10

SHEET NO:

If this drawing is not 24"x36", then the drawing has been revised from its original size. Noted scales must be adjusted. This line should be equal to one inch

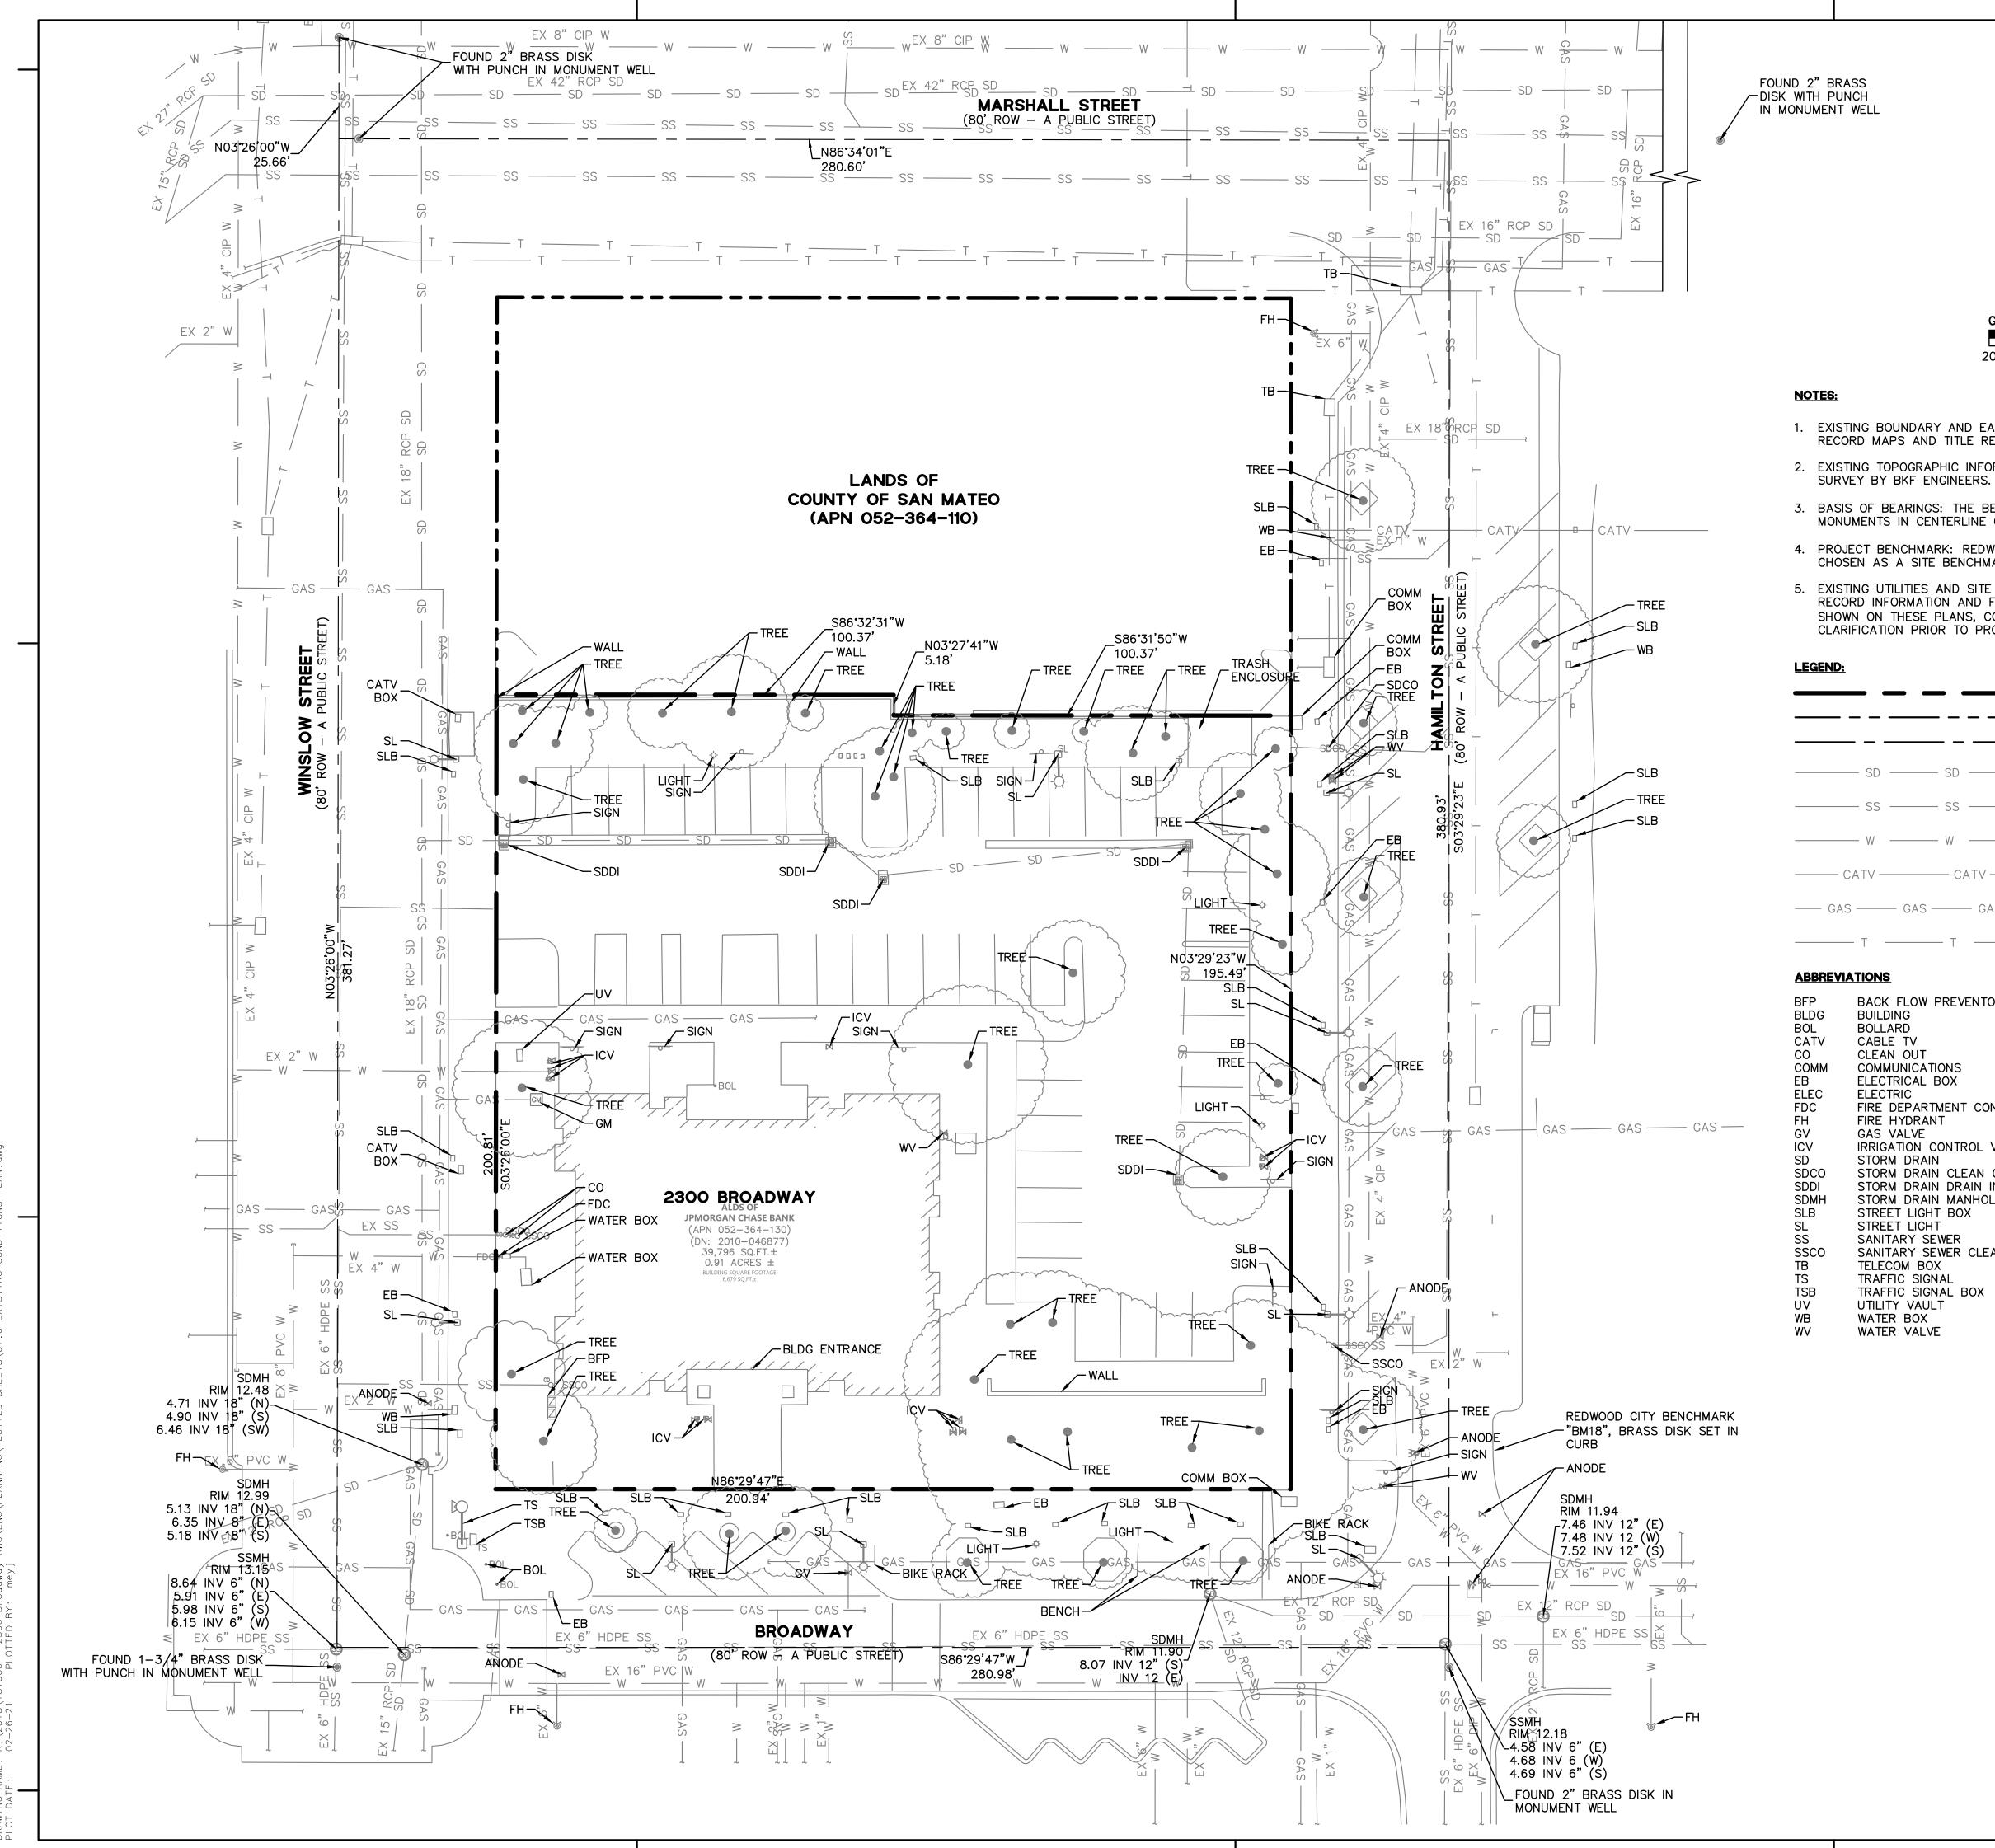

-2 0 201-26-К. 02-DAD

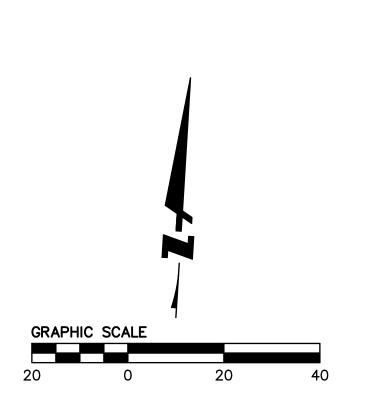

1. EXISTING BOUNDARY AND EASEMENT INFORMATION IS BASED ON A REVIEW OF AVAILABLE RECORD MAPS AND TITLE REPORTS FOR THE PROJECT AREA. 2. EXISTING TOPOGRAPHIC INFORMATION SHOWN ON THESE PLANS IS BASED ON A SITE FIELD

3. BASIS OF BEARINGS: THE BEARING OF NORTH 86°34'01" EAST BETWEEN THE TWO FOUND MONUMENTS IN CENTERLINE OF MARSHALL STREET WAS TAKEN AS THE BASIS OF THIS SURVEY. 4. PROJECT BENCHMARK: REDWOOD CITY BENCHMARK "BM18", A BRASS DISK SET IN CURB, WAS CHOSEN AS A SITE BENCHMARK FOR THIS SURVEY. ELEVATION = 12.59 FT.

5. EXISTING UTILITIES AND SITE CONDITIONS SHOWN ON THIS PLAN ARE BASED ON AVAILABLE RECORD INFORMATION AND FIELD SURVEYS. SHOULD FIELD CONDITIONS DIFFER FROM WHAT IS SHOWN ON THESE PLANS, CONTACT THE OWNER'S REPRESENTATIVE FOR DIRECTION AND CLARIFICATION PRIOR TO PROCEEDING WITH CONSTRUCTION ACTIVITIES.

	PROPERTY LINE
	LOT LINE
	CENTERLINE
SD	EXISTING STORM DRAIN LINE
SS	EXISTING SANITARY SEWER LINE
W	EXISTING WATER LINE
CATV	EXISTING CABLE TV LINE
GAS ——— GAS ——	EXISTING GAS LINE
— т —	EXISTING TELEPHONE LINE

LOW	PREVENTOR

COMMUNICATIONS ELECTRICAL BOX FIRE DEPARTMENT CONNECTION FIRE HYDRANT IRRIGATION CONTROL VALVE STORM DRAIN STORM DRAIN CLEAN OUT STORM DRAIN DRAIN INLET STORM DRAIN MANHOLE STREET LIGHT BOX STREET LIGHT SANITARY SEWER SANITARY SEWER CLEAN OUT TELECOM BOX TRAFFIC SIGNAL TRAFFIC SIGNAL BOX UTILITY VAULT

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255 SHORELINE DRIVE SUITE 200 REDWOOD CITY, CA 94065 (650) 482-6300 www.bkf.com

ISSUES DATE PLANNING APPLICATION 03/03/2021

REVISION LIST

DATE

2300 BROADWAY Redwood City, CA

KEYPLAN


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SHEET TITLE:


EXISTING CONDITIONS PLAN

SHEET NO:

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1. EXISTING BOUNDARY AND EASEMENT INFORMATION IS BASED ON A REVIEW OF AVAILABLE RECORD MAPS AND TITLE REPORTS FOR THE PROJECT AREA. 2. EXISTING TOPOGRAPHIC INFORMATION SHOWN ON THESE PLANS IS BASED ON A SITE FIELD

SURVEY BY BKF ENGINEERS. 3. BASIS OF BEARINGS: THE BEARING OF NORTH 86°34'01" EAST BETWEEN THE TWO FOUND MONUMENTS IN CENTERLINE OF MARSHALL STREET WAS TAKEN AS THE BASIS OF THIS SURVEY.

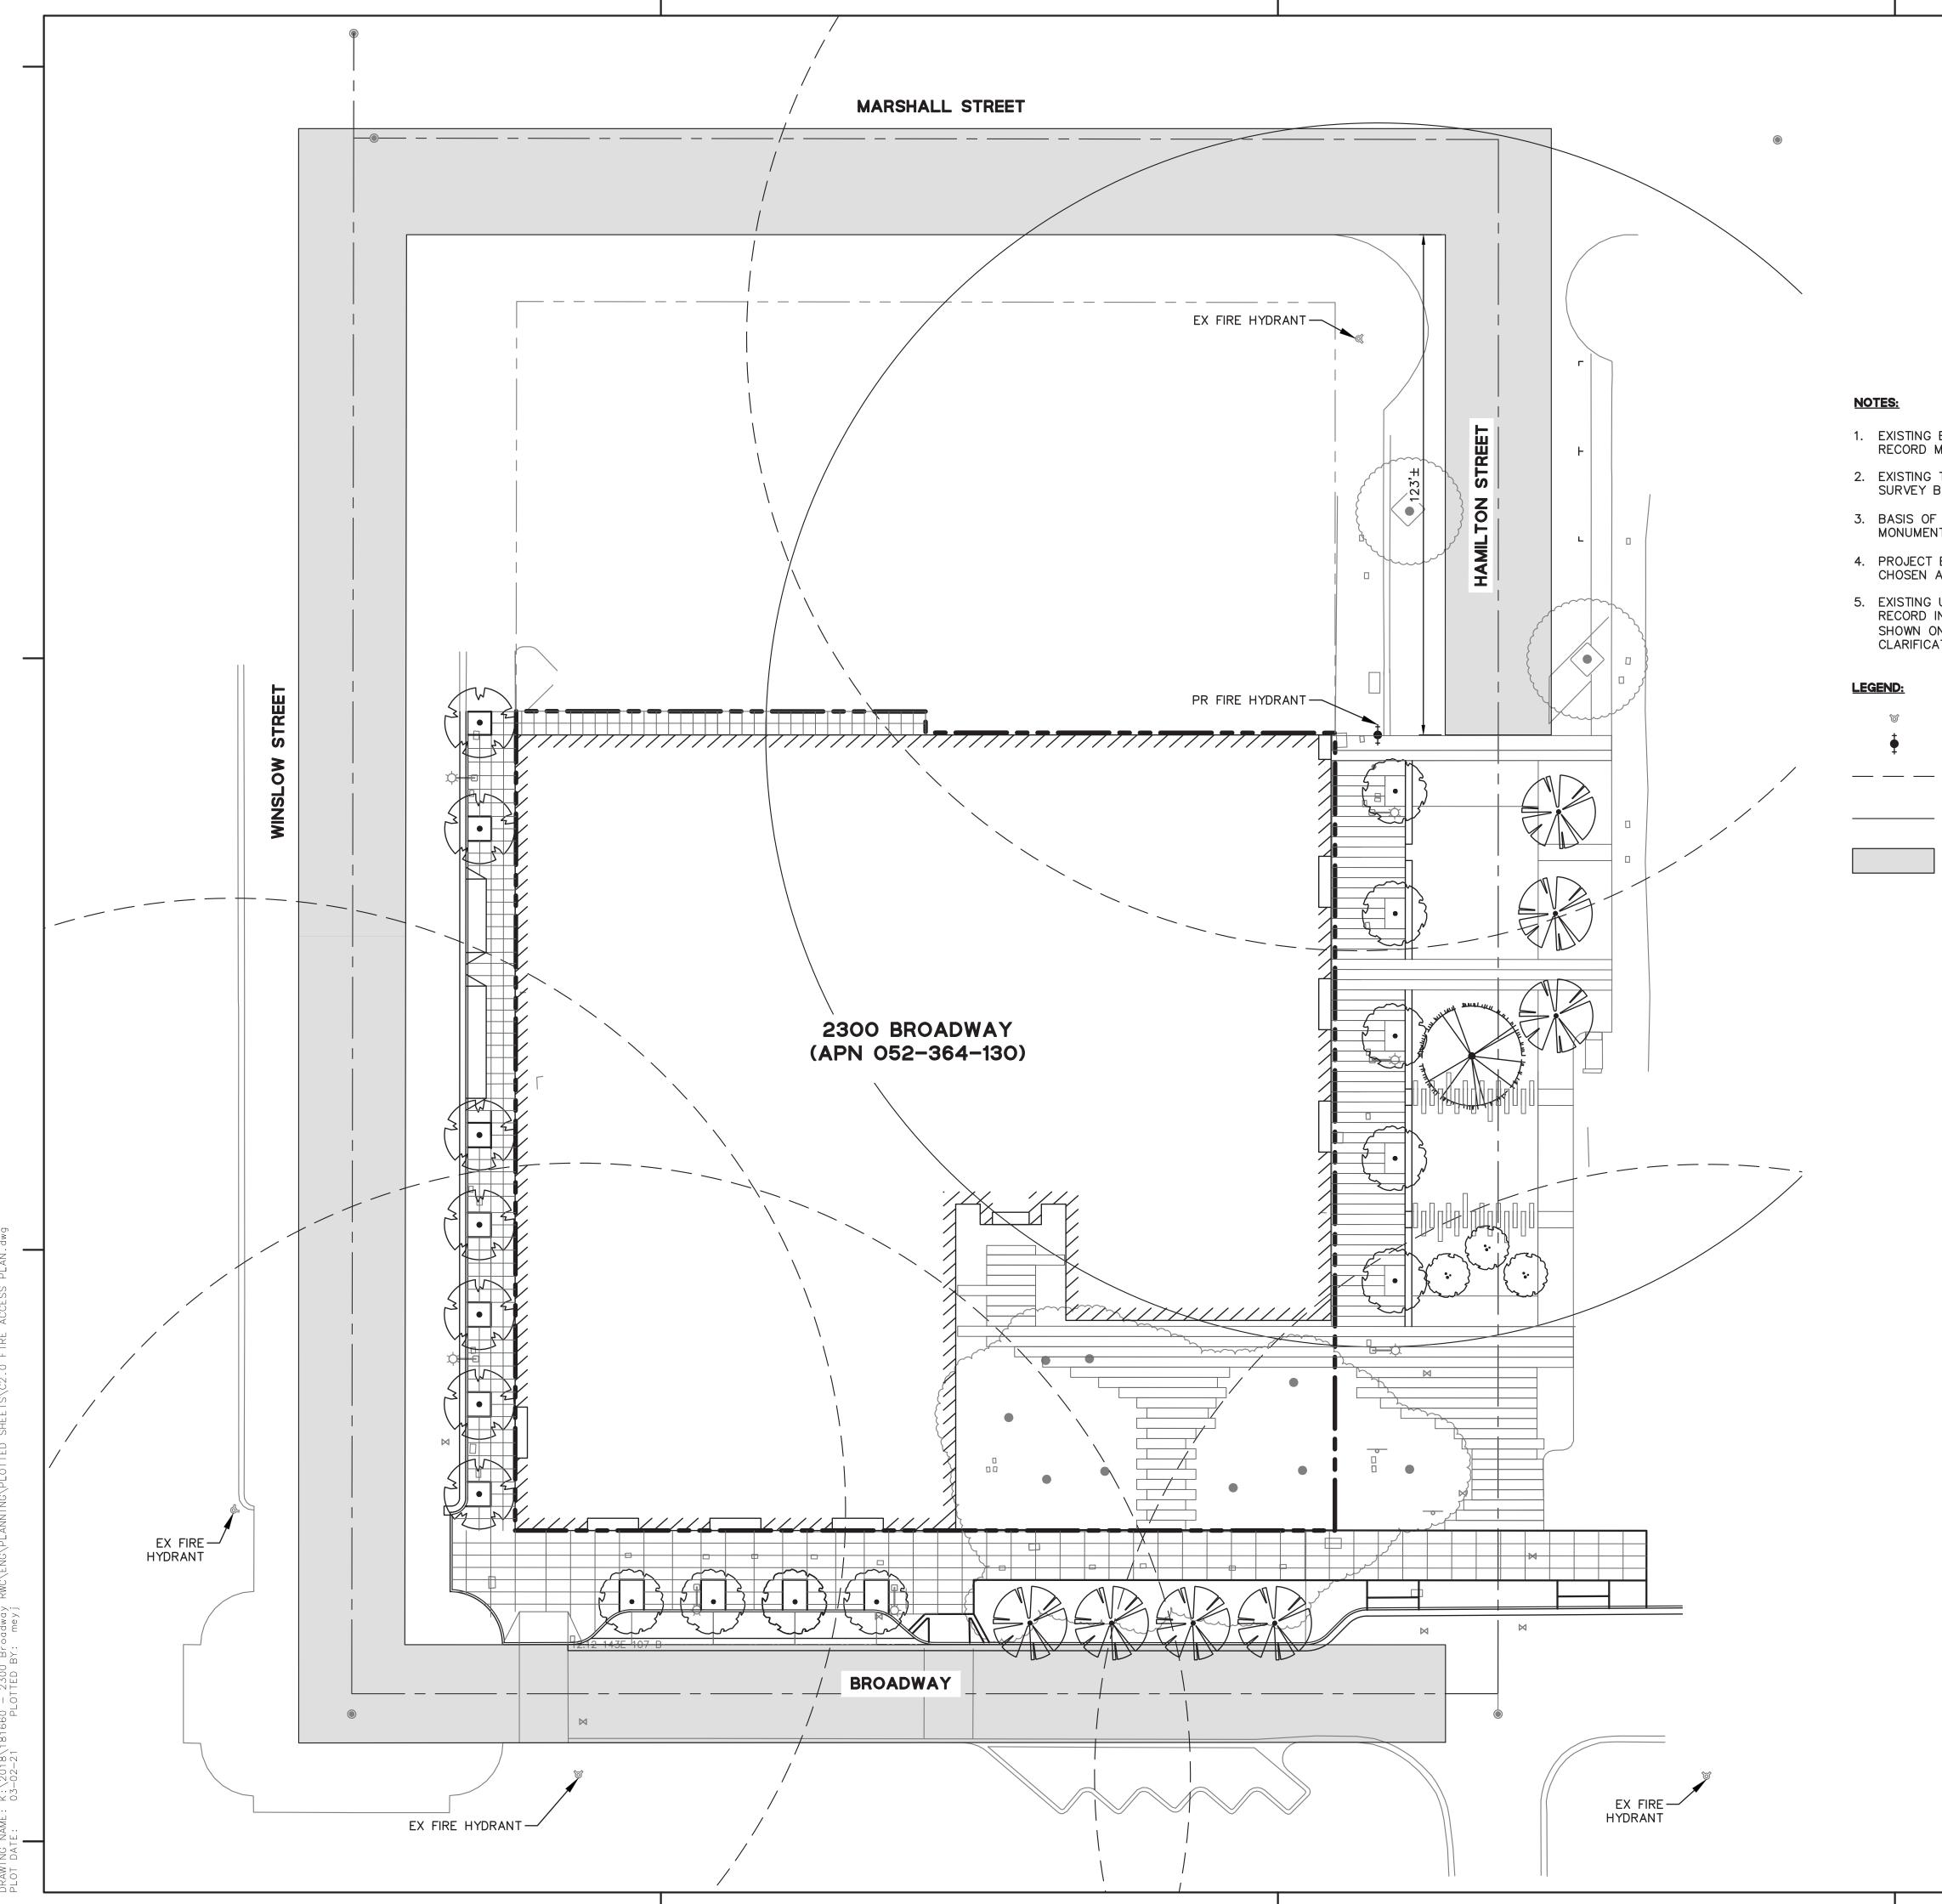4. PROJECT BENCHMARK: REDWOOD CITY BENCHMARK "BM18", A BRASS DISK SET IN CURB, WAS CHOSEN AS A SITE BENCHMARK FOR THIS SURVEY. ELEVATION = 12.59 FT.
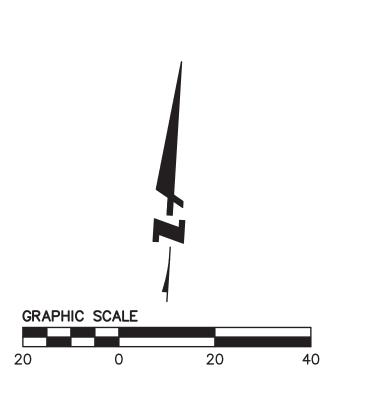
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> EXISTING FIRE HYDRANT PROPOSED FIRE HYDRANT EXISTING FIRE HYDRANT COVERAGE – 150' RADIUS PROPOSED FIRE HYDRANT COVERAGE – 150' RADIUS

FIRE ACCESS PATH

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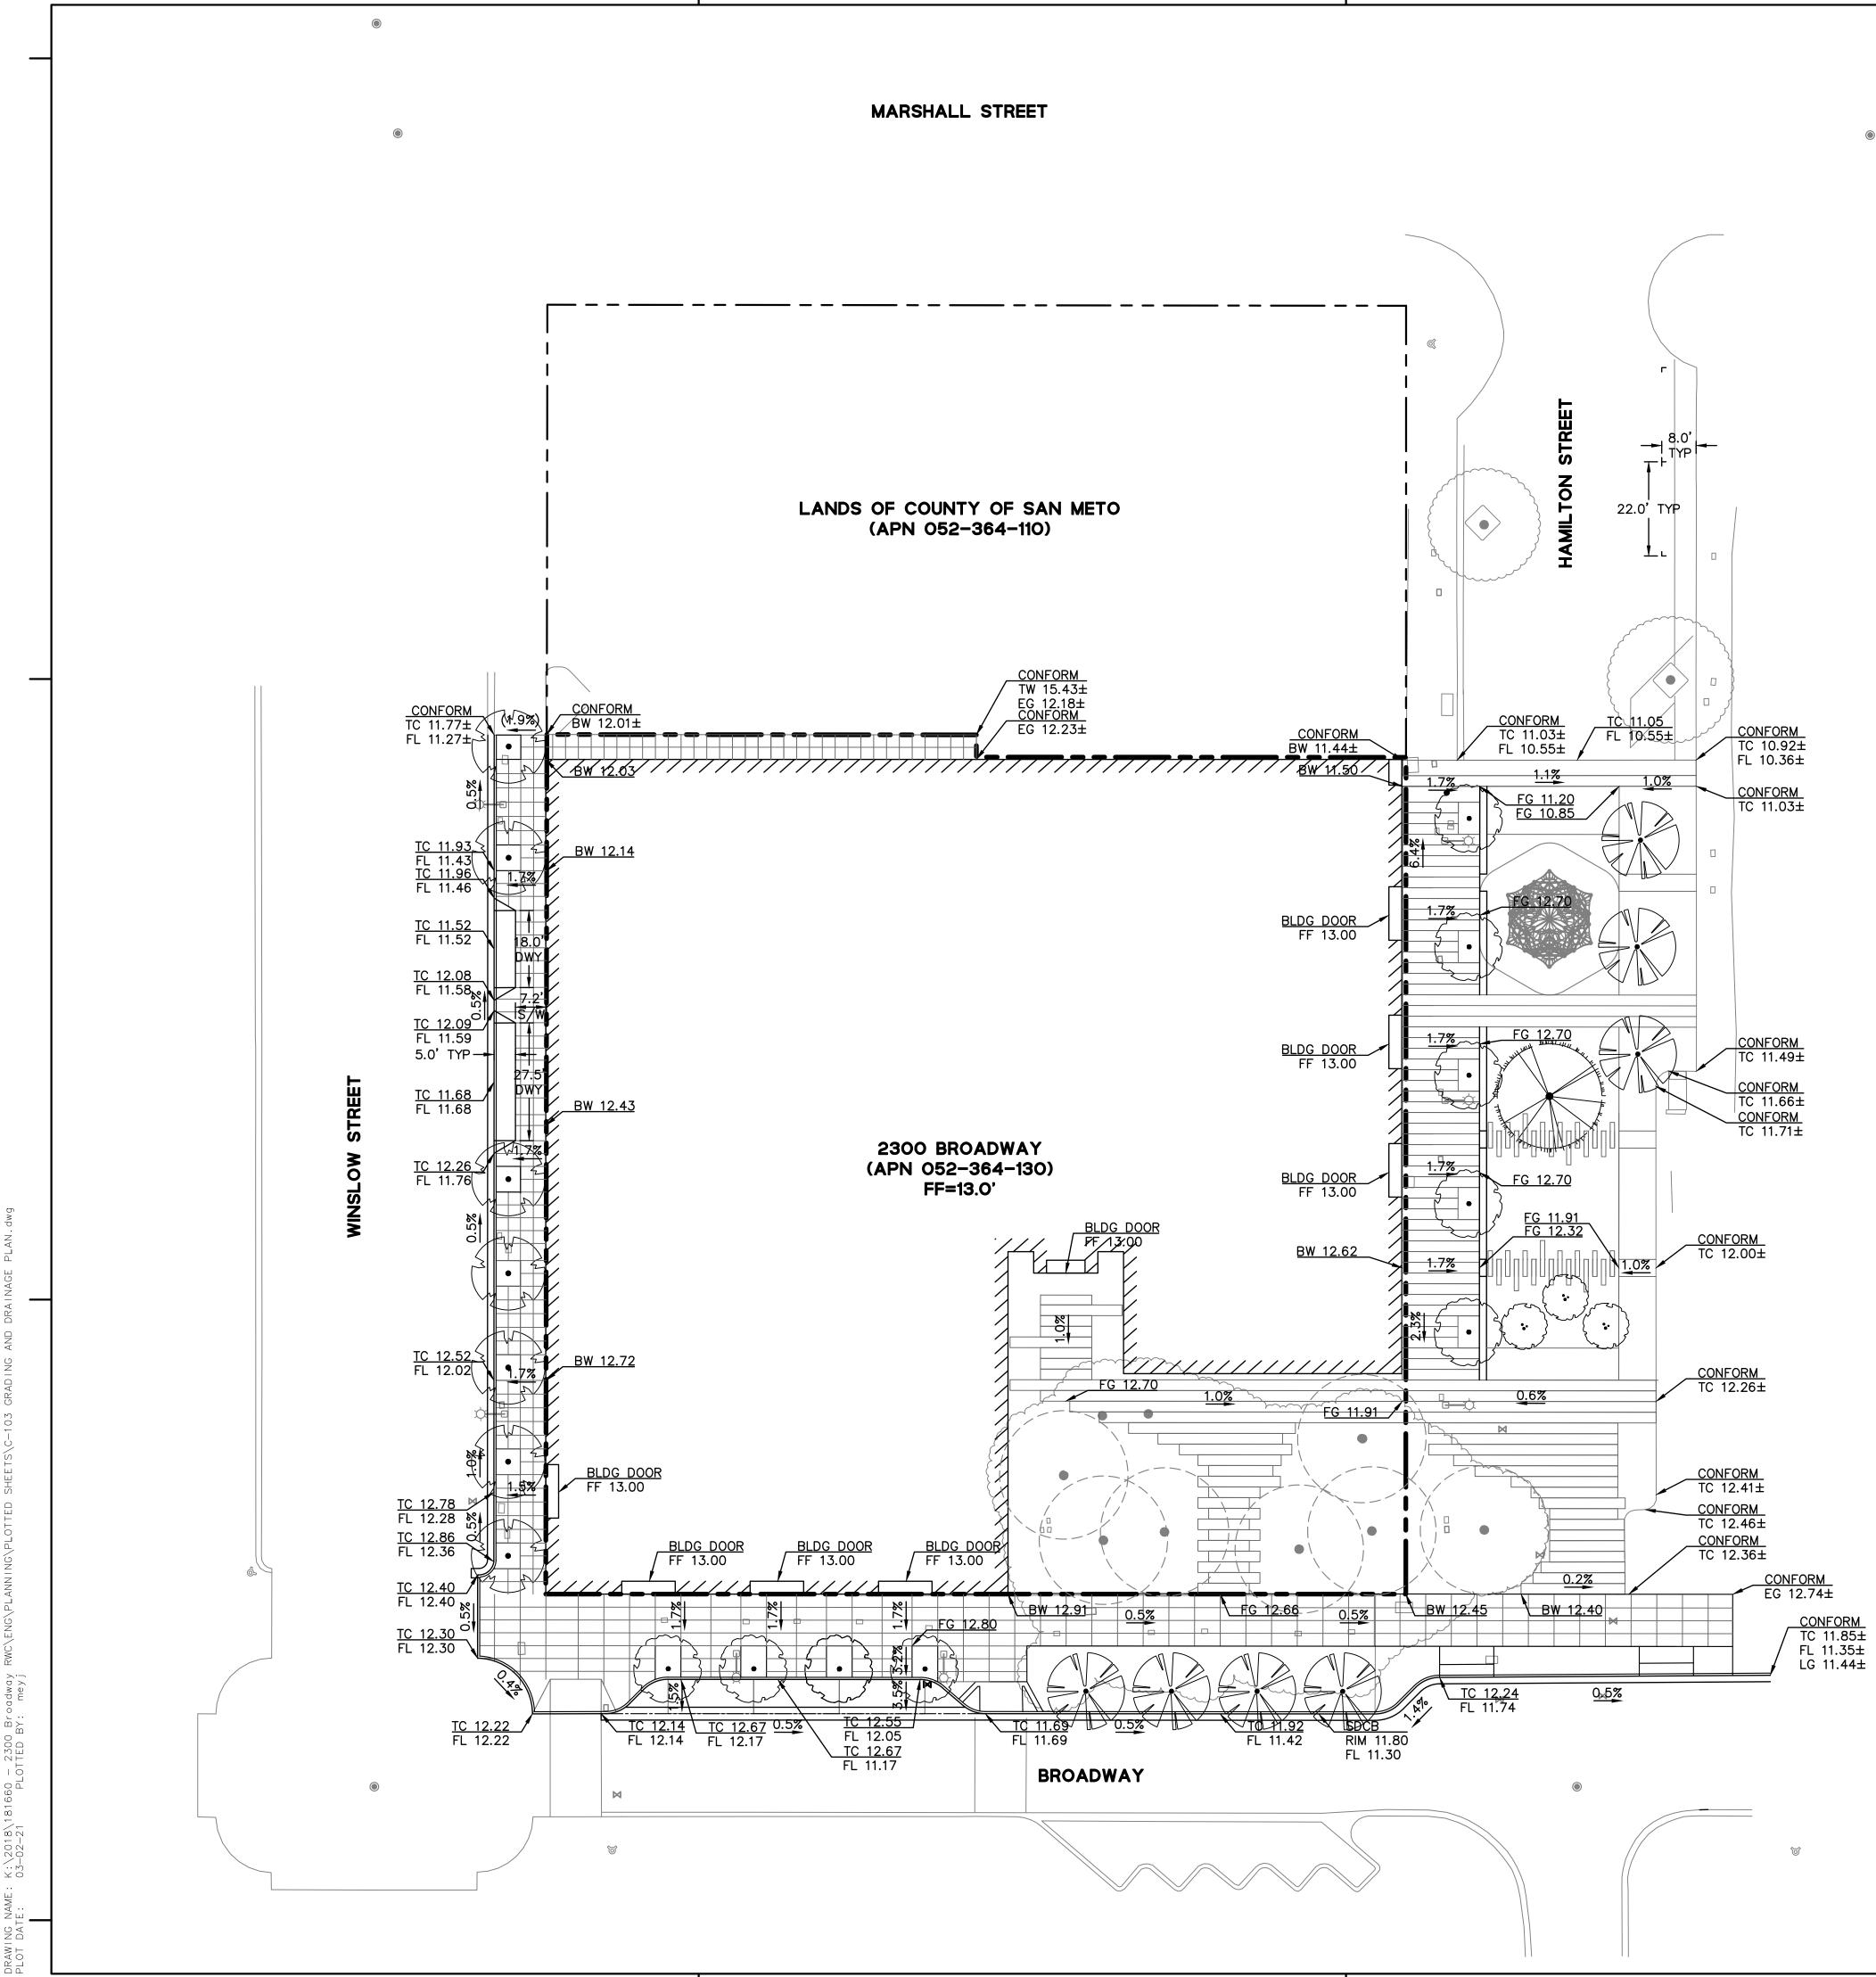
PROJECT NO.: 20181660 DATE: 03/05/2021 SCALE: AS SHOWN

SHEET TITLE:



SHEET NO:

1



NOTES:

- SURVEY BY BKF ENGINEERS.


- OTHERWISE NOTED.

LEGEND:

1.0% <u> EG 10.00±</u> (1.0%)

ABBREVIATIONS:

BLDG	BUILDING
BW	BACK OF
DWY	DRIVEWAY
EG	EXISTING
FG	FINISH FL
FG	FINISH GR
FL	FLOW LINE
LG	LIP OF Gl
S/W	SIDEWALK
TĊ	TOP OF C
TYP	TYPICAL

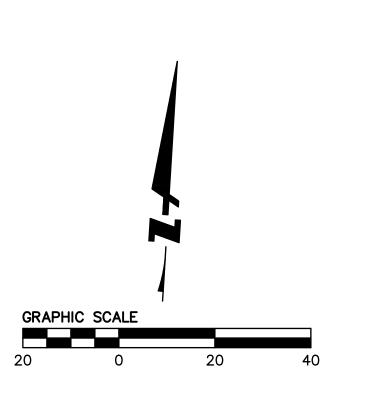

1. EXISTING BOUNDARY AND EASEMENT INFORMATION IS BASED ON A REVIEW OF AVAILABLE RECORD MAPS AND TITLE REPORTS FOR THE PROJECT AREA. 2. EXISTING TOPOGRAPHIC INFORMATION SHOWN ON THESE PLANS IS BASED ON A SITE FIELD

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6. DIMENSIONS SHOWN REFERS TO THE FACE OF CURB OR EDGE OF PATHWAY, UNLESS

- PROPOSED GRADE
- PROPOSED SLOPE
- EXISTING GRADE
- EXISTING SLOPE

ING OF WALK WAY ING GRADE H FLOOR H GRADE LINE DF GUTTER WALK OF CURB

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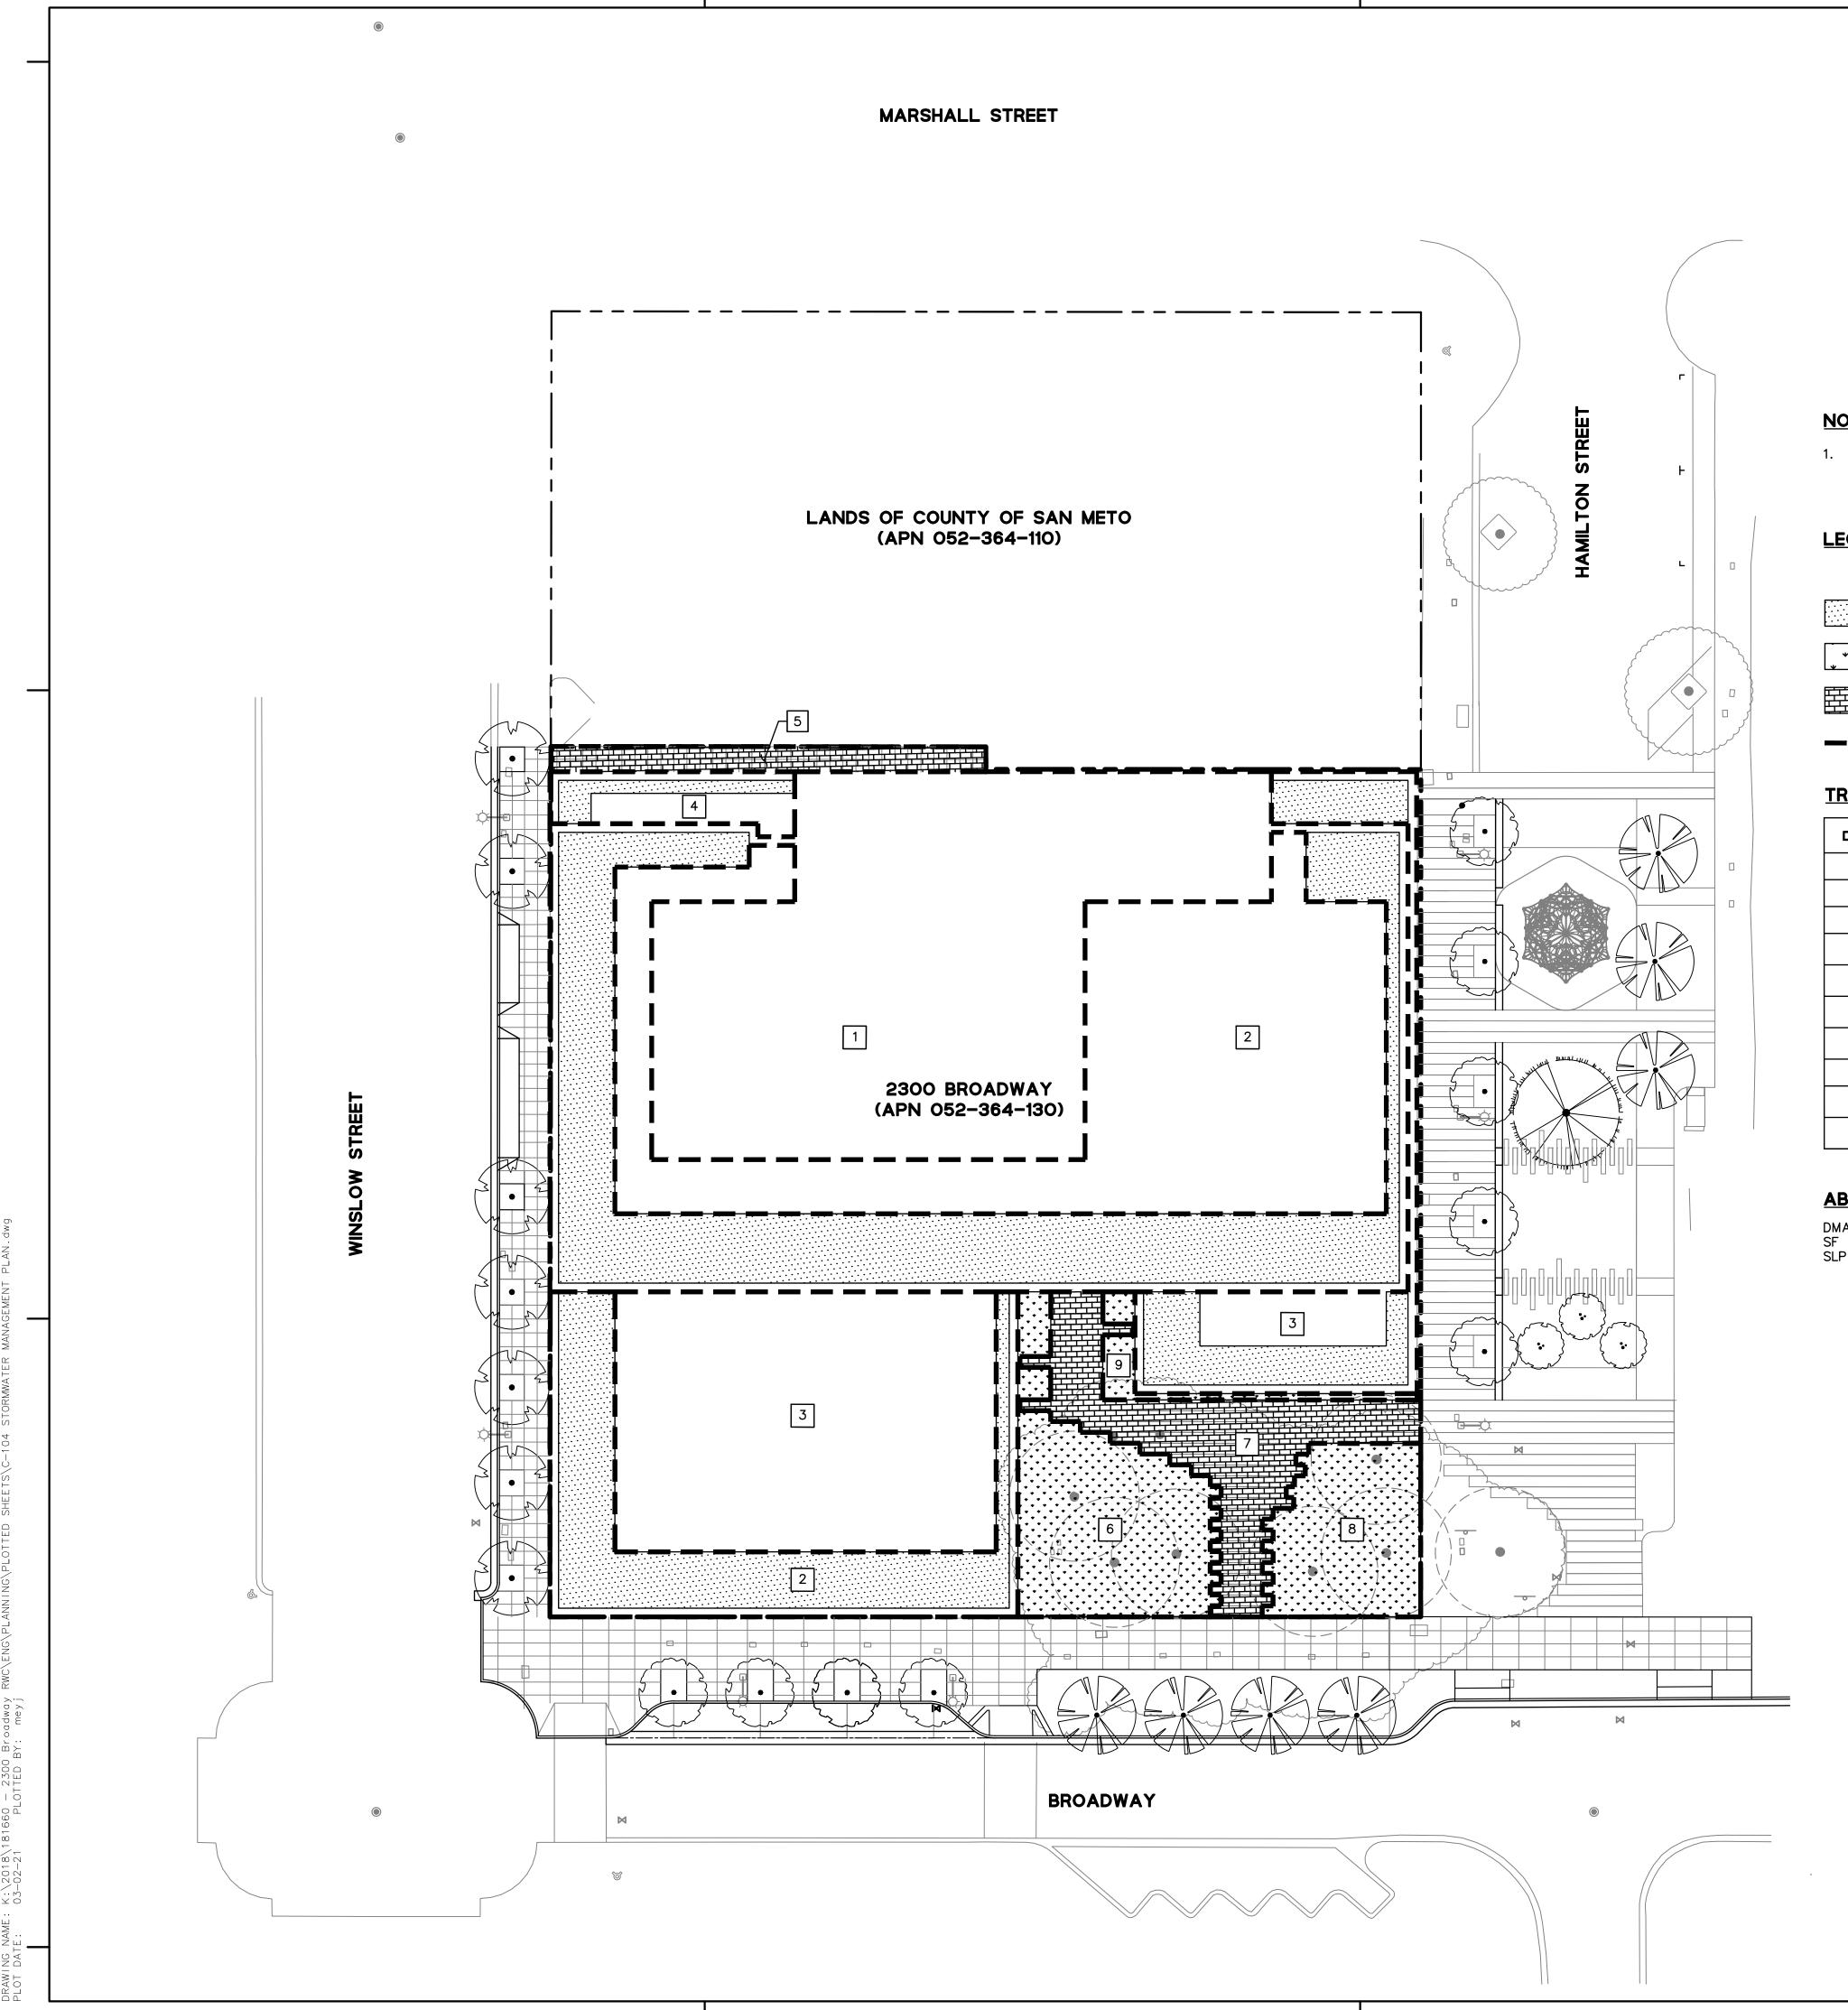
PROJECT NO.: 20181660 DATE: 03/05/2021 SCALE: AS SHOWN

SHEET TITLE:

GRADING AND DRAINAGE PLAN

SHEET NO:

3



20

NOTES:

LEGEND:


1	DRAINAGE AREA I
	BIO-RETENTION AF
+ + + + + +	LANDSCAPE AREA,
	PERMEABLE PAVER
	DRAINAGE MANAGE

TREATMENT SUMMARY TABLE

DMA NO.	DMA AREA (SF)	IMPERMOUS AREA (SF)	PERVIOUS AREA (SF)	TREATMENT AREA REQUIRED (SF)	TREATMENT AREA PROVIDED (SF)	TREATMENT MEASURE	
1	15,300	10,244	5,056	410	5,056	BIO-RETENTION AREA	
2	10,198	7,886	2,312	315	2,312	BIO-RETENTION AREA	
3	7,436	6,347	1,089	254	1,089	BIO-RETENTION AREA	
4	704	488	216	20	216	BIO-RETENTION AREA	
5	579	_	579	_	579	SELF-TREATING	
6	2,021	_	2,021	_	2,021	SELF-TREATING	
7	1,985	-	1,985	_	1,985	SELF-TREATING	
8	1,310	_	1,310	_	1,310	SELF-TREATING	
9	263	_	263	_	263	SELF-TREATING	
TOTAL	39,796	24,965	14,831	999	14,831		

ABBREVIATIONS:

DMA	DRAINAGE MANAGEMENT AREA
SF	SQUARE FEET
SLP	SEE LANDSCAPE PLANS

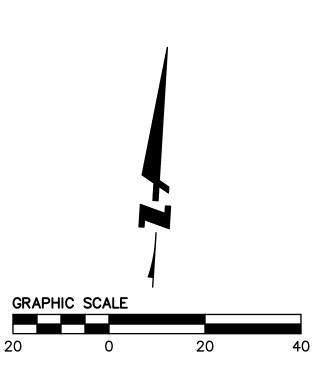

1. POST CONSTRUCTION IMPERVIOUS AREAS TO BE TREATED AS REQUIRED BY THE BAY AREA MUNICIPAL REGIONAL STORMWATER PERMIT (MRP) PROVISION C.3.

REA

, SLP

ERS, SLP

GEMENT AREA

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DATE 03/03/2021



DATE

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KEYPLAN

PROJECT NO.: 20181660 DATE: 03/05/2021 SCALE: AS SHOWN

SHEET TITLE:



SHEET NO:

4



2/16/2021 4:41:29 PM

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GLS LANDSCAPE ARCHITECTURE 2677 Mission Street, No. 200 San Francisco, CA 94110-3105 415.285.3614 | glsarch.com

ISSUES PLANNING APPLICATION

DATE 03/03/2021

REVISION LIST

DATE

2300 BROADWAY Redwood City, CA

KEYPLAN

PROJECT NO.: 19046.00 DATE: 03/05/2021 SCALE:


SHEET TITLE:

PROPOSED ILLUSTRATIVE LANDSCAPE PLAN

SHEET NO:

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Public Open Space Character

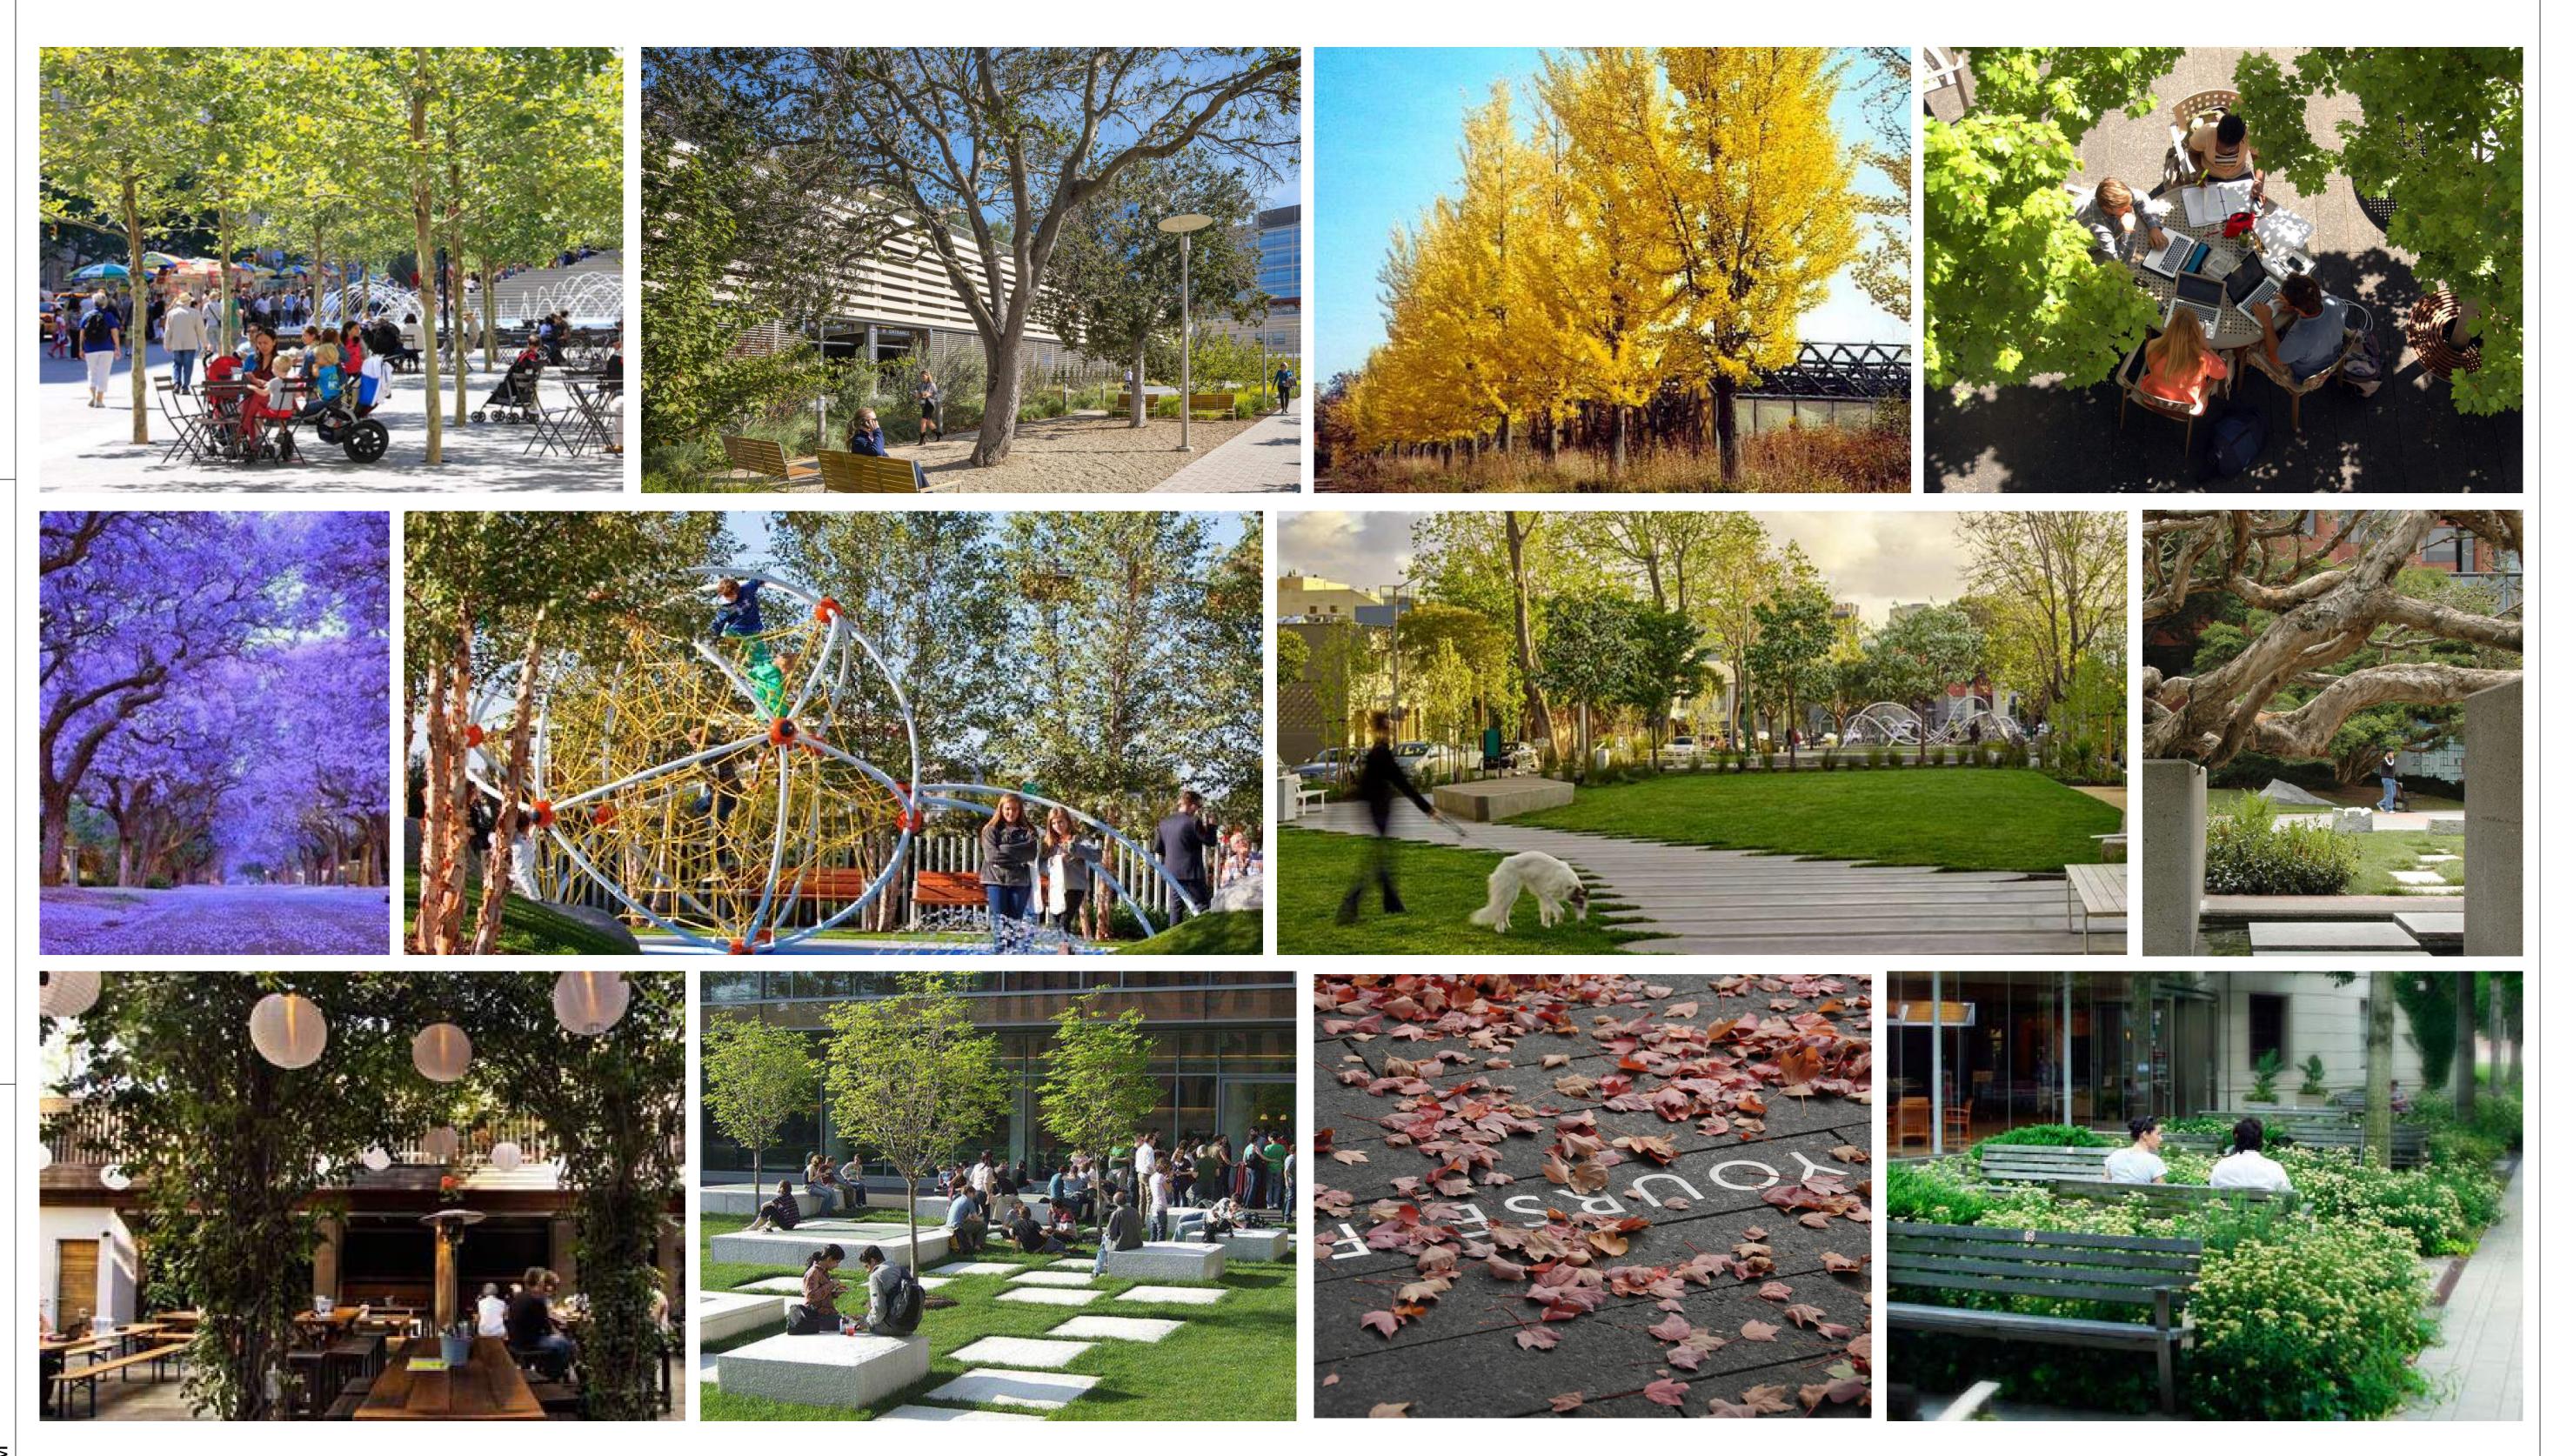

2/22/2021 10:28:51 AM

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DATE

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KEYPLAN

PROJECT NO.: 19046.00 DATE: 03/05/2021 SCALE:


SHEET TITLE:

PUBLIC OPEN SPACE CHARACTER

SHEET NO:

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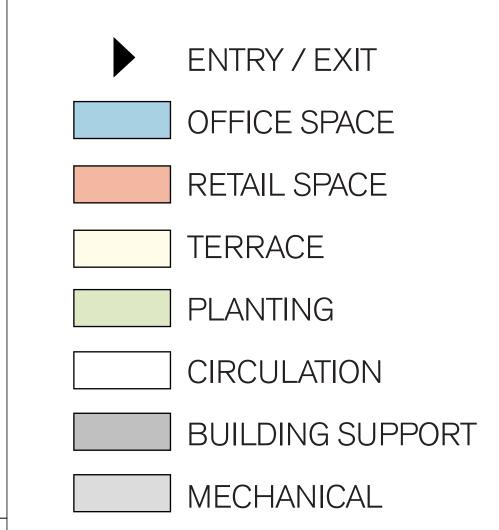
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0' 5' 11' 21' 3/32" = 1'-0"

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		PROJECT NO.: 19046.00	
		DATE: 10/22/2021	
		SCALE: 1/16" = 1'-0"	
		SHEET TITLE:	
		FLOOR PLAN - LEVEL B	2
		SHEET NO:	
	43'	A-10E	32

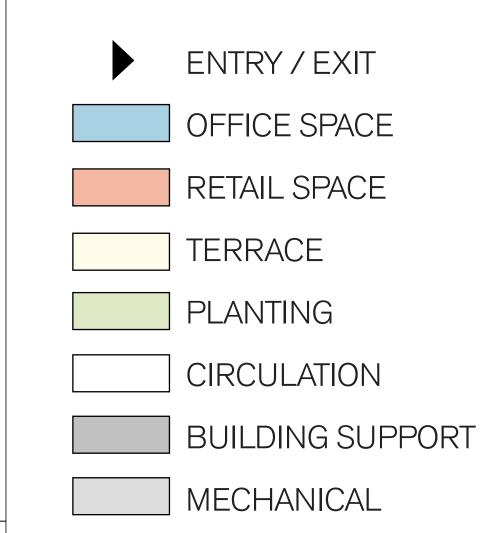




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	Redwood City, CA
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	PROJECT NO.: 19046.00 DATE: 10/22/2021 SCALE: 1/16" = 1'-0"
	SHEET TITLE:
	FLOOR PLAN - LEVEL B1
	SHEET NO:
43'	A-10B1



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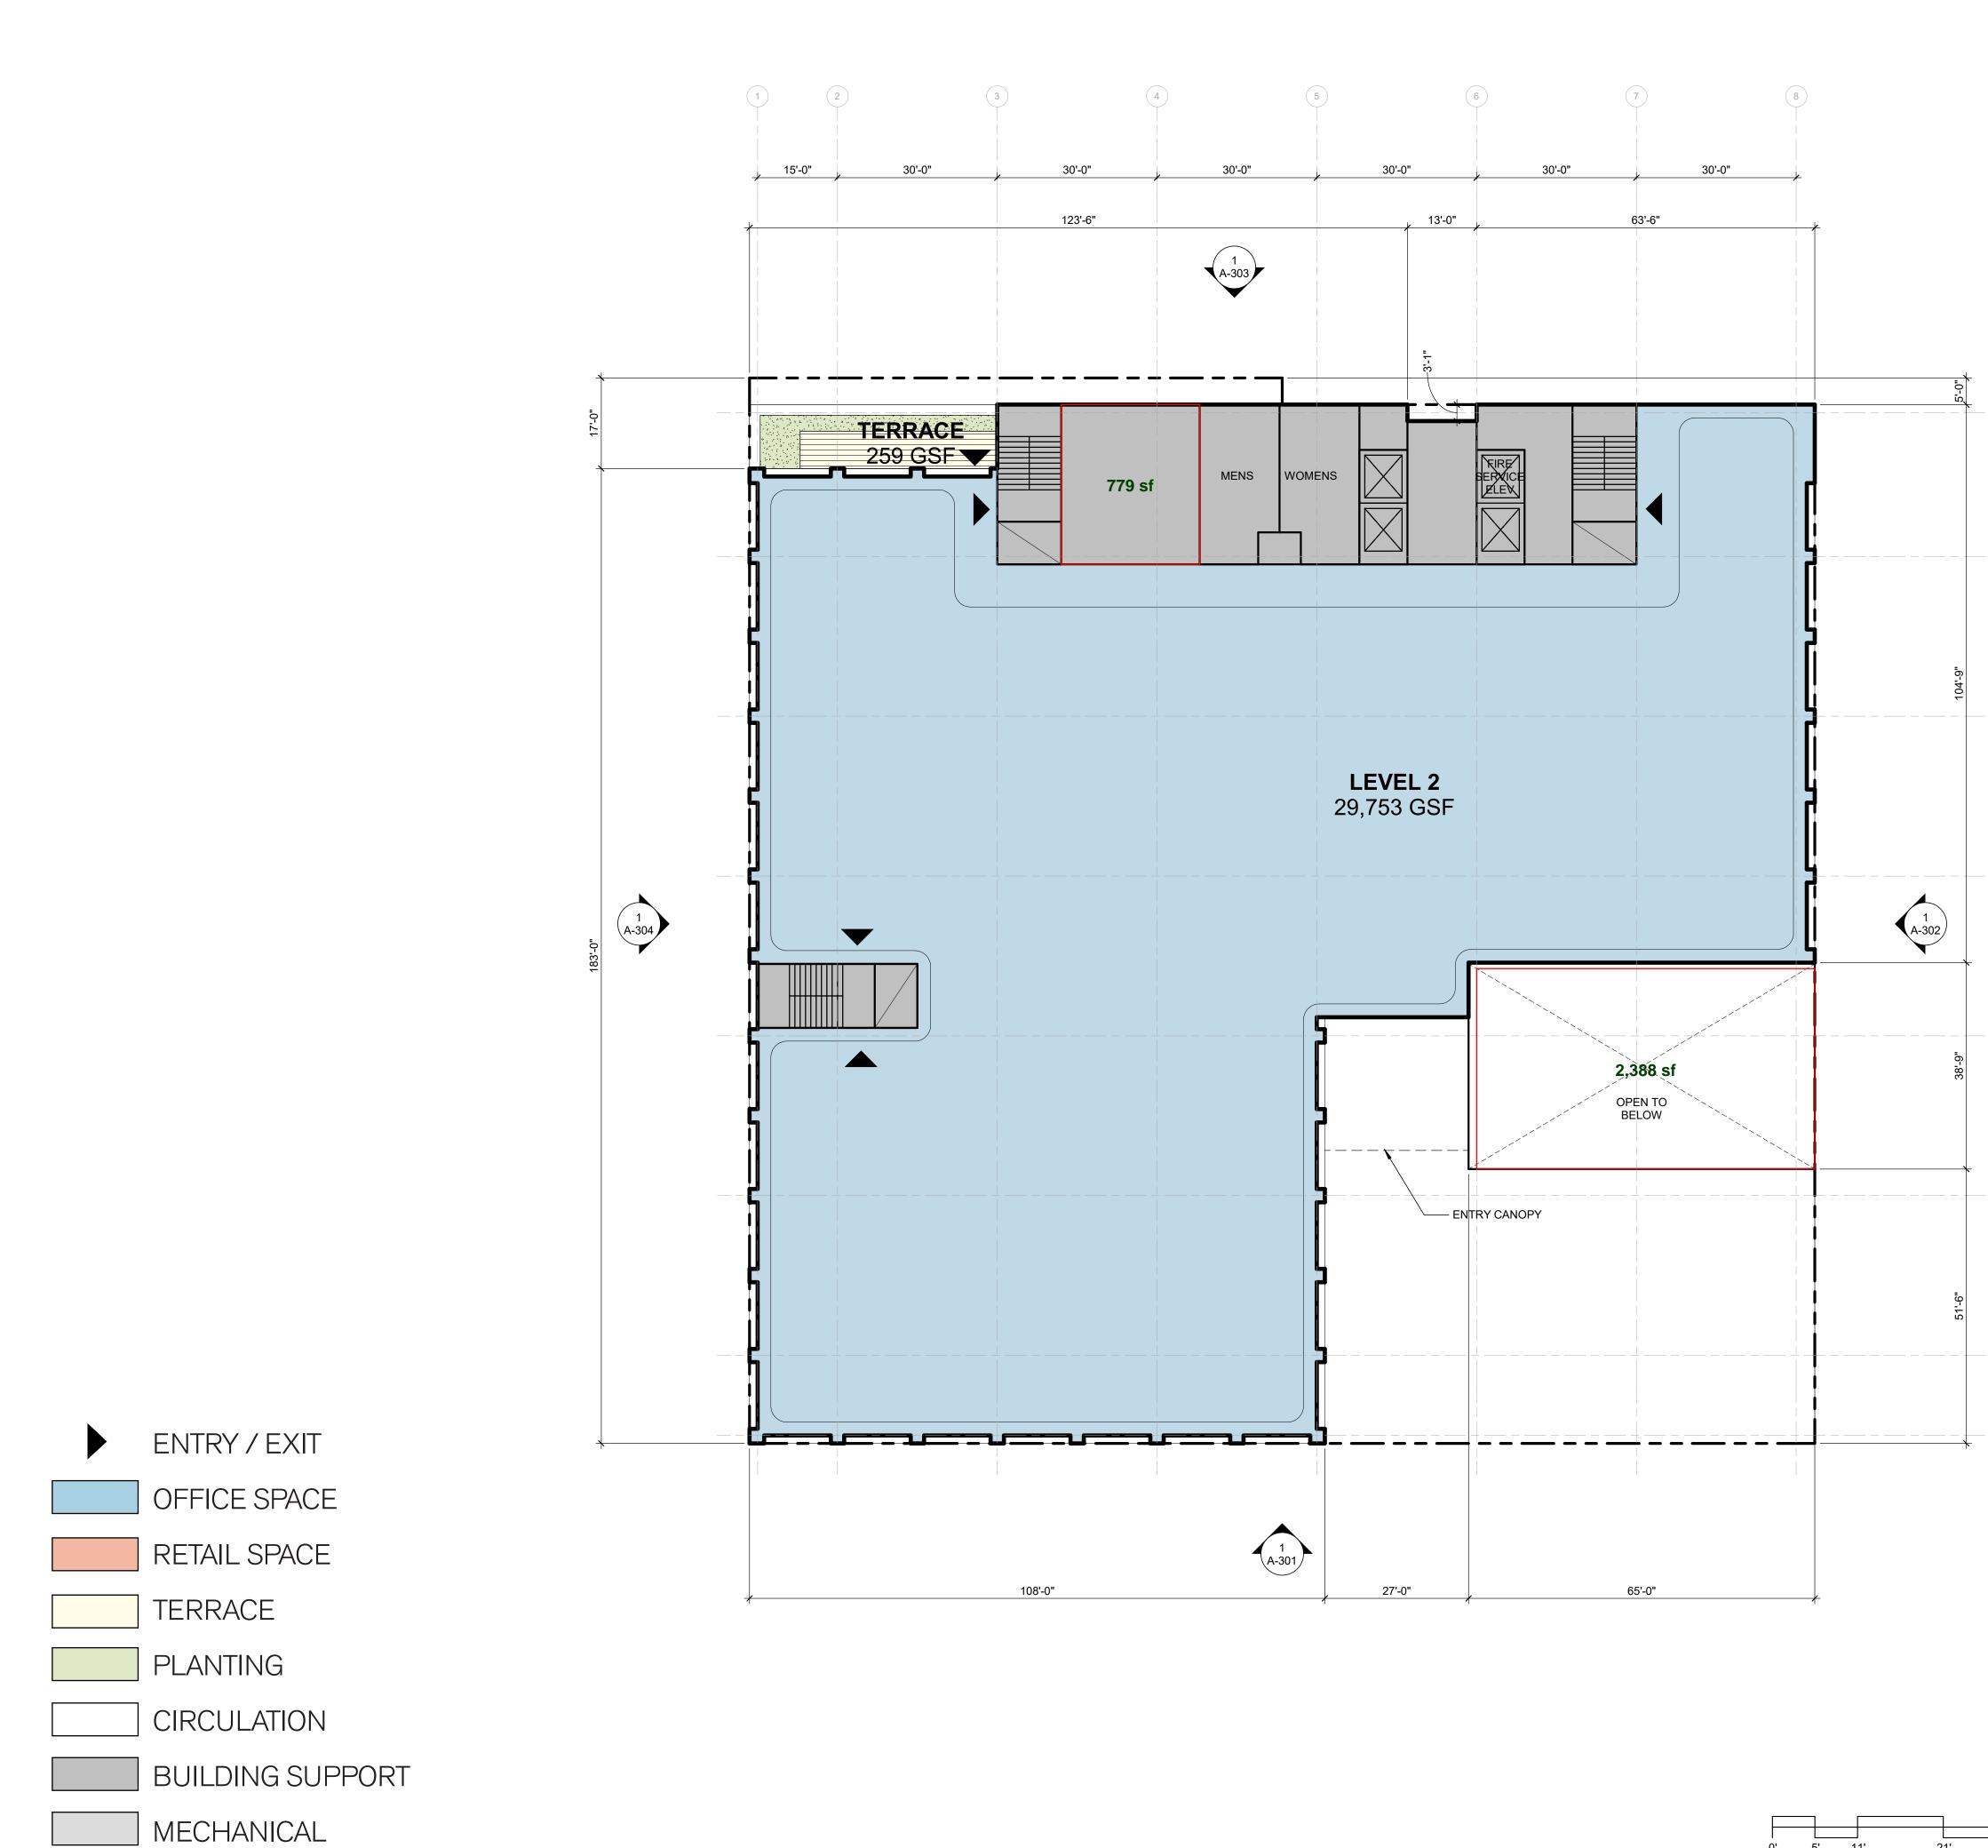
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REVISION LIST	DATE
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PROJECT NO.: 19046.00 DATE: 10/22/2021 SCALE: 1/16" = 1'-0" SHEET TITLE:	
FLOOR PLAN - LEVEL 1	

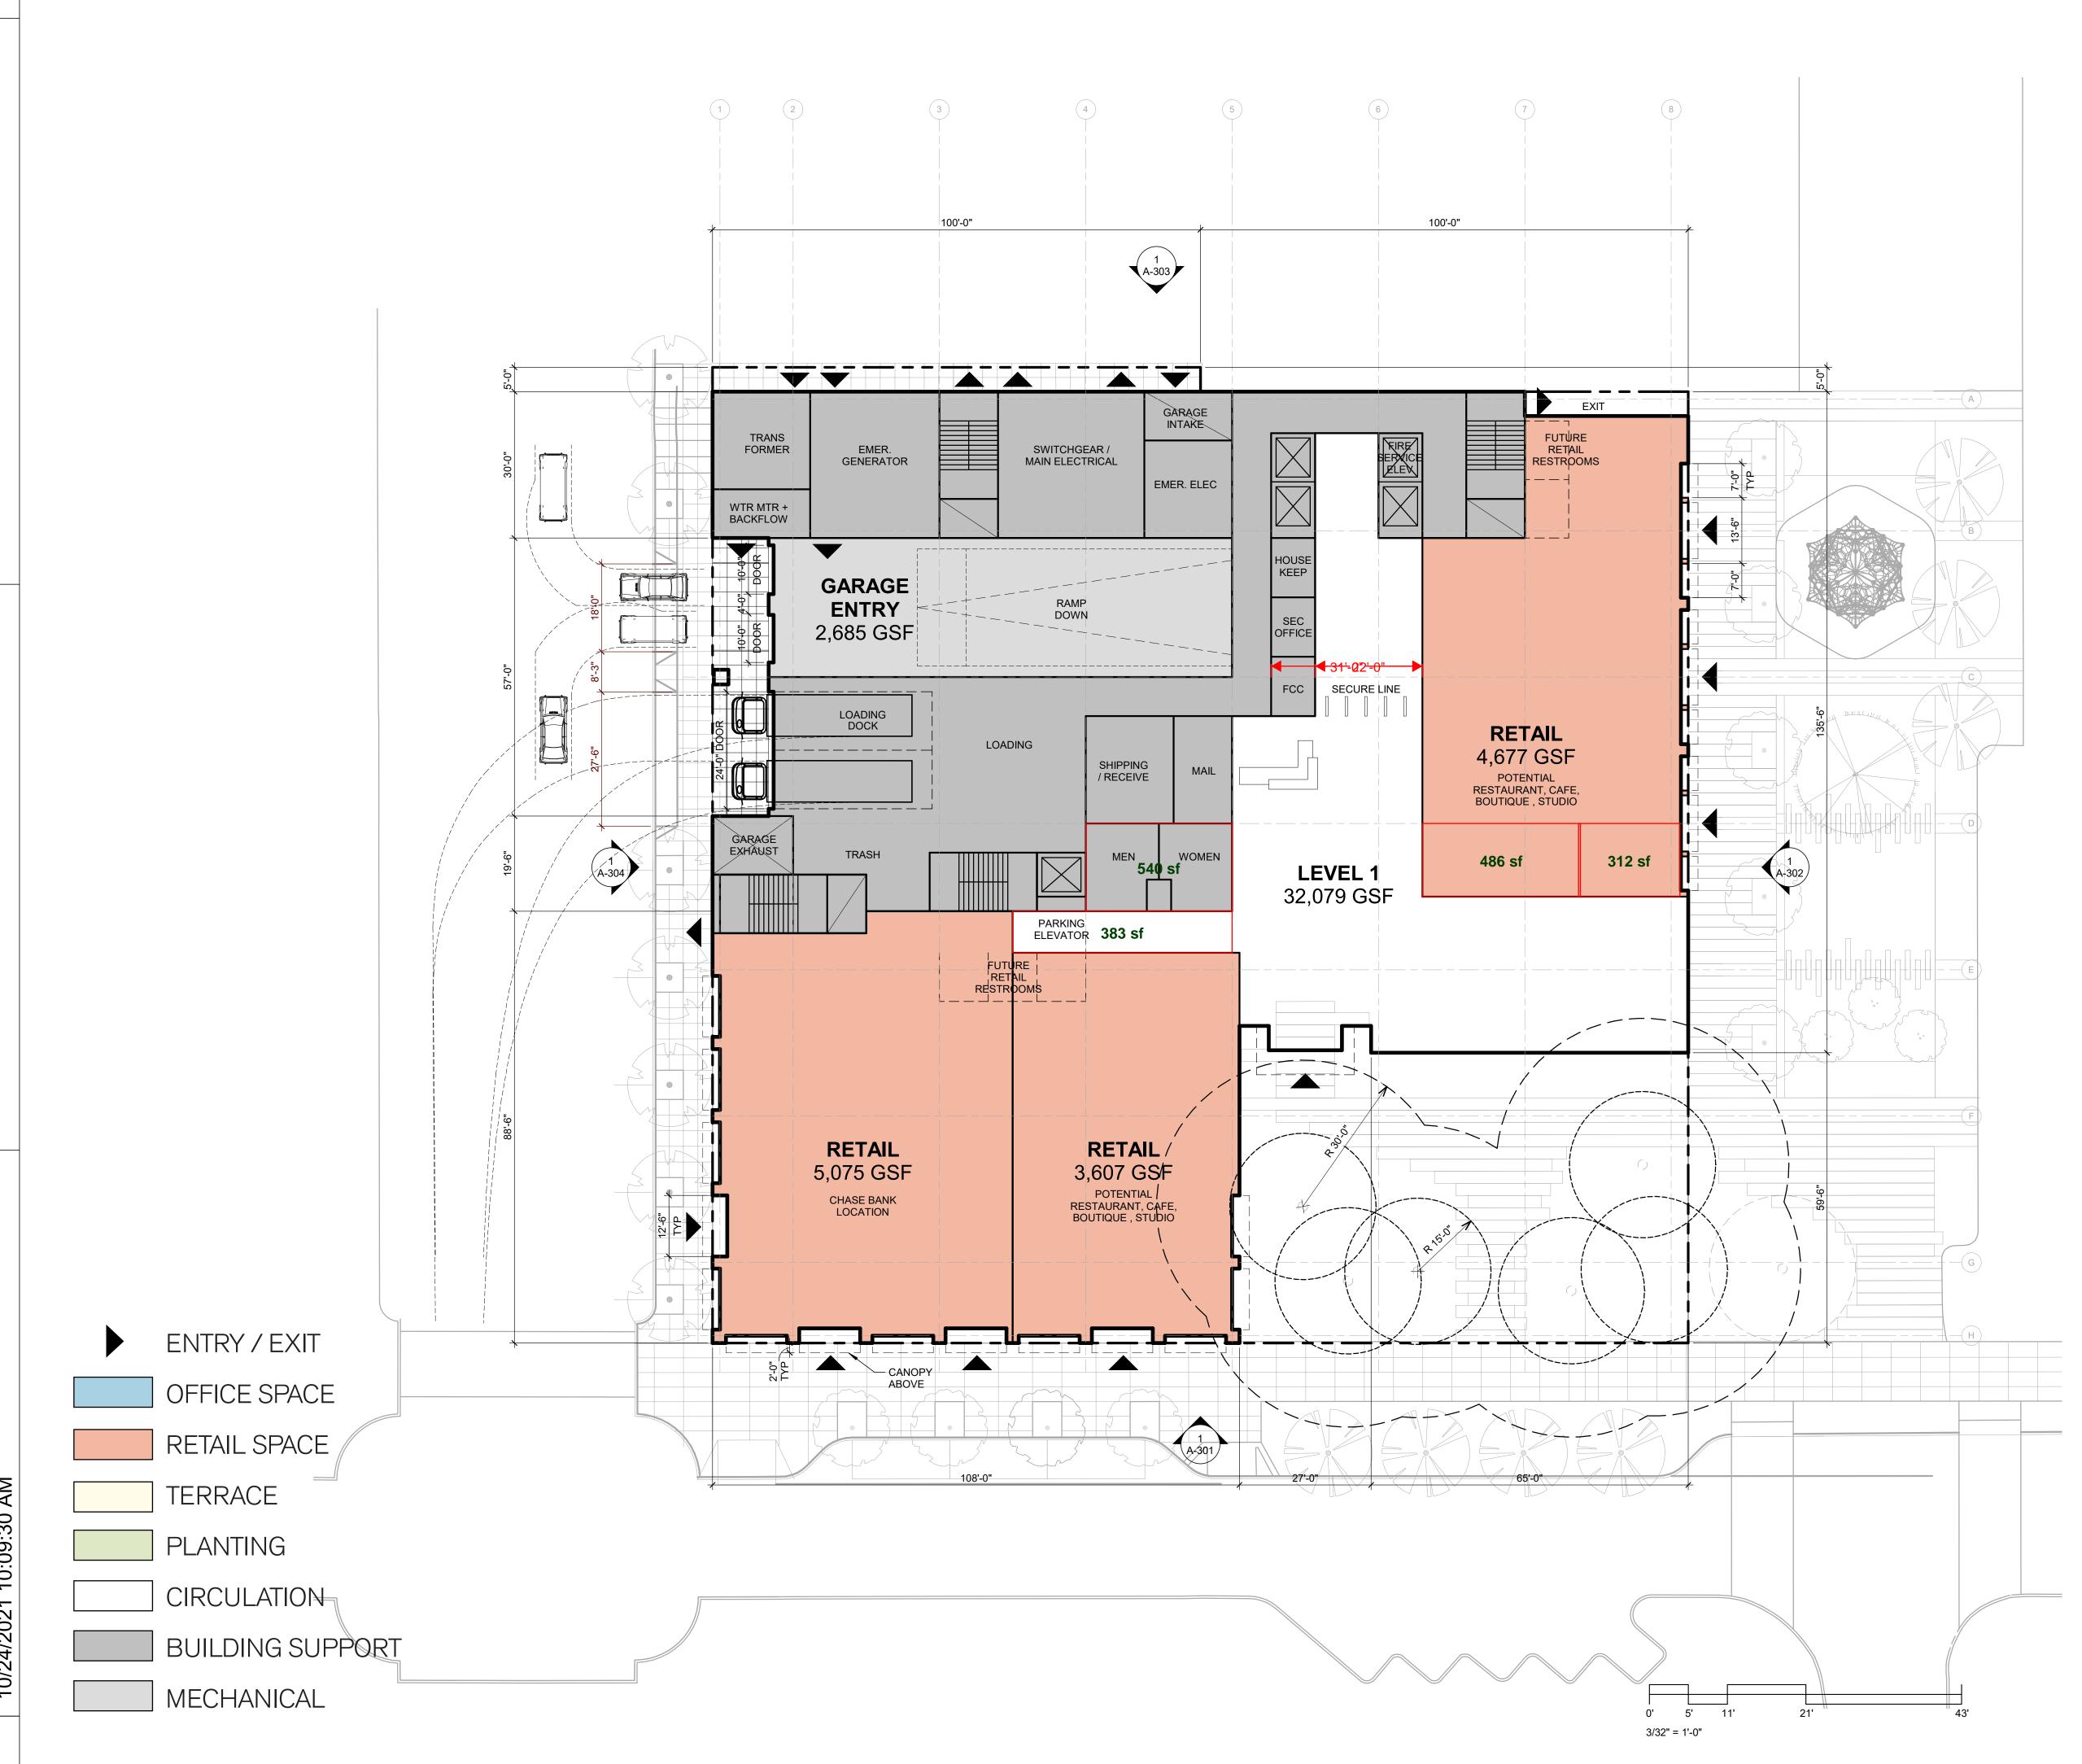
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SHEET NO:


A-101



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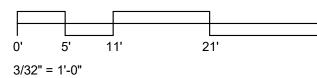


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	CALIFORNIA 94107 415.489.2224 TEL 415.358.9100 FAX WWW.WRNSSTUDIO.COM
	ISSUES DATE PLANNING APPLICATION 03/03/2021 PLANNING APPLICATION #2 10/22/2021
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x F	2300 BROADWAY Redwood City, CA
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	PROJECT NO.: 19046.00 DATE: 10/22/2021
	SCALE: 1/16" = 1'-0" SHEET TITLE: FLOOR PLAN - LEVEL 2
43'	SHEET NO: A-102

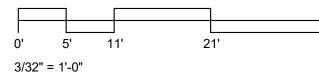

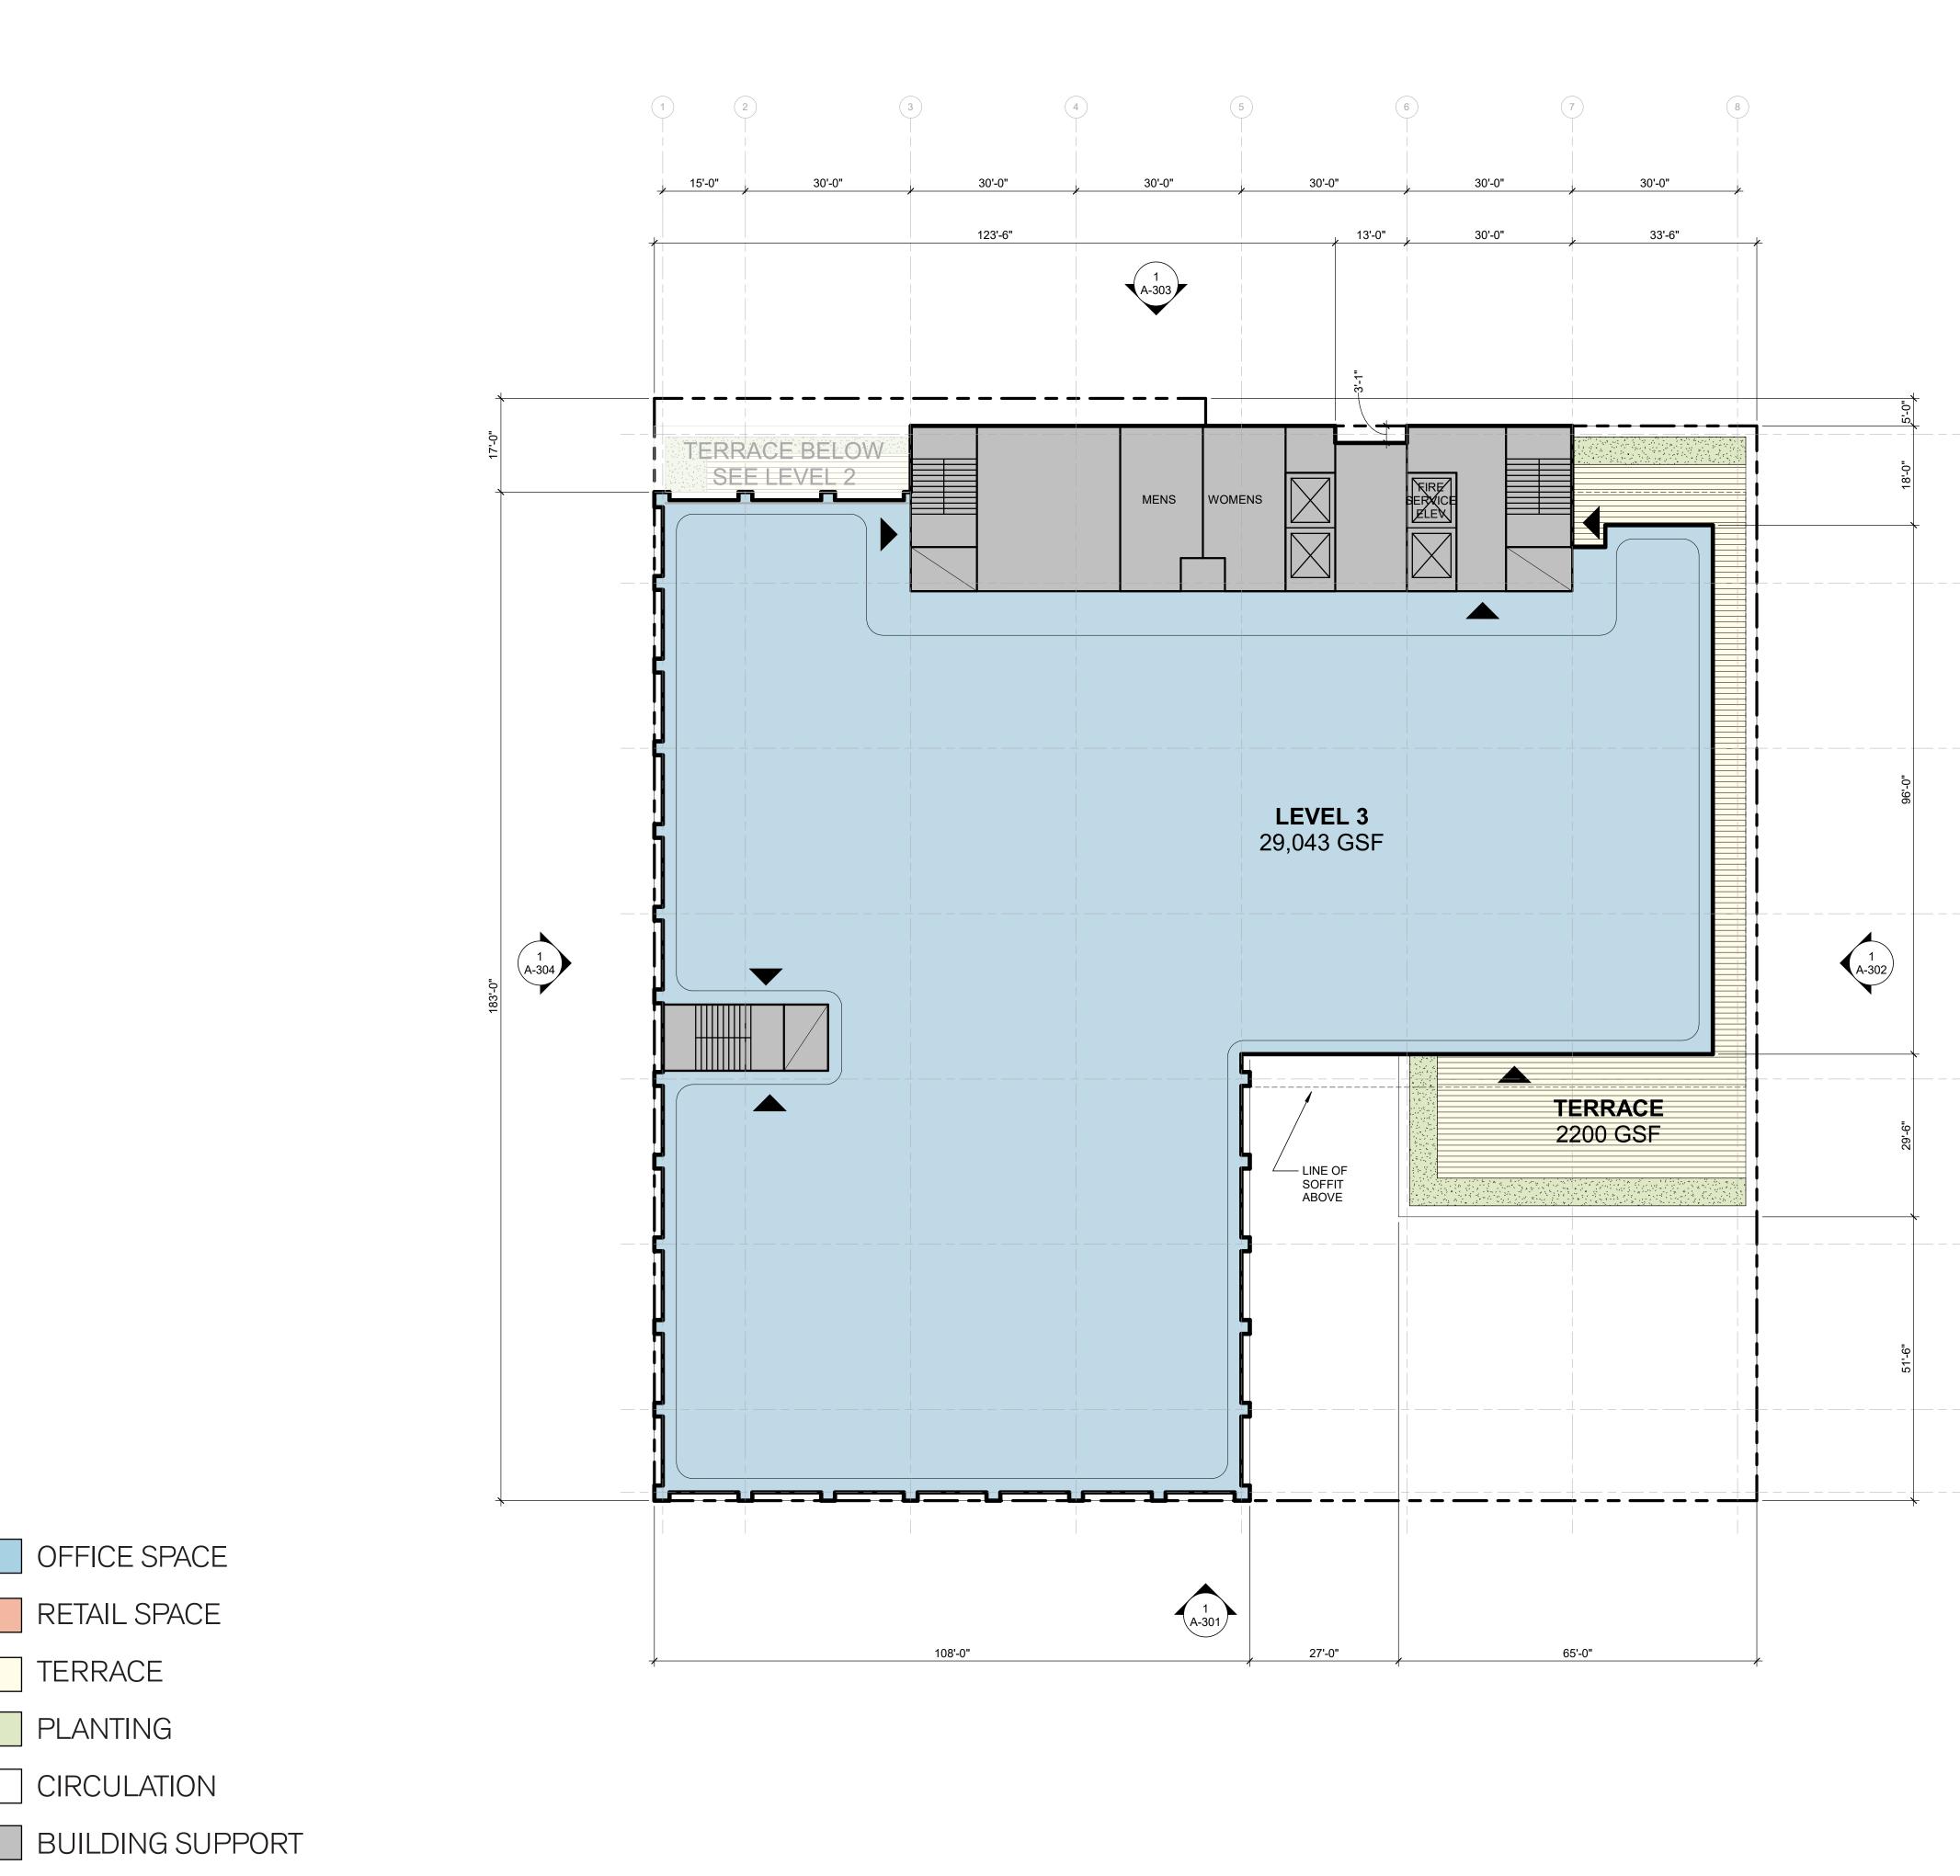
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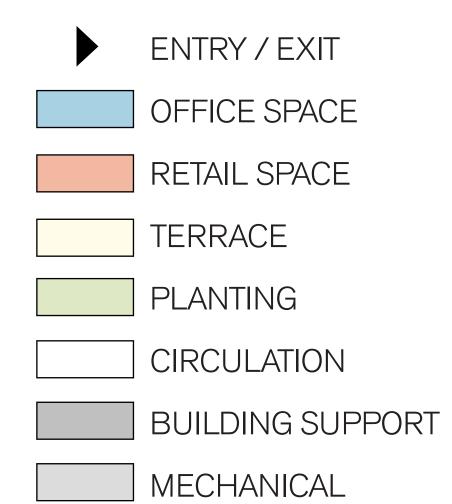
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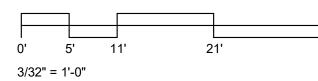


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	 43'	SHEET NO:	A-103






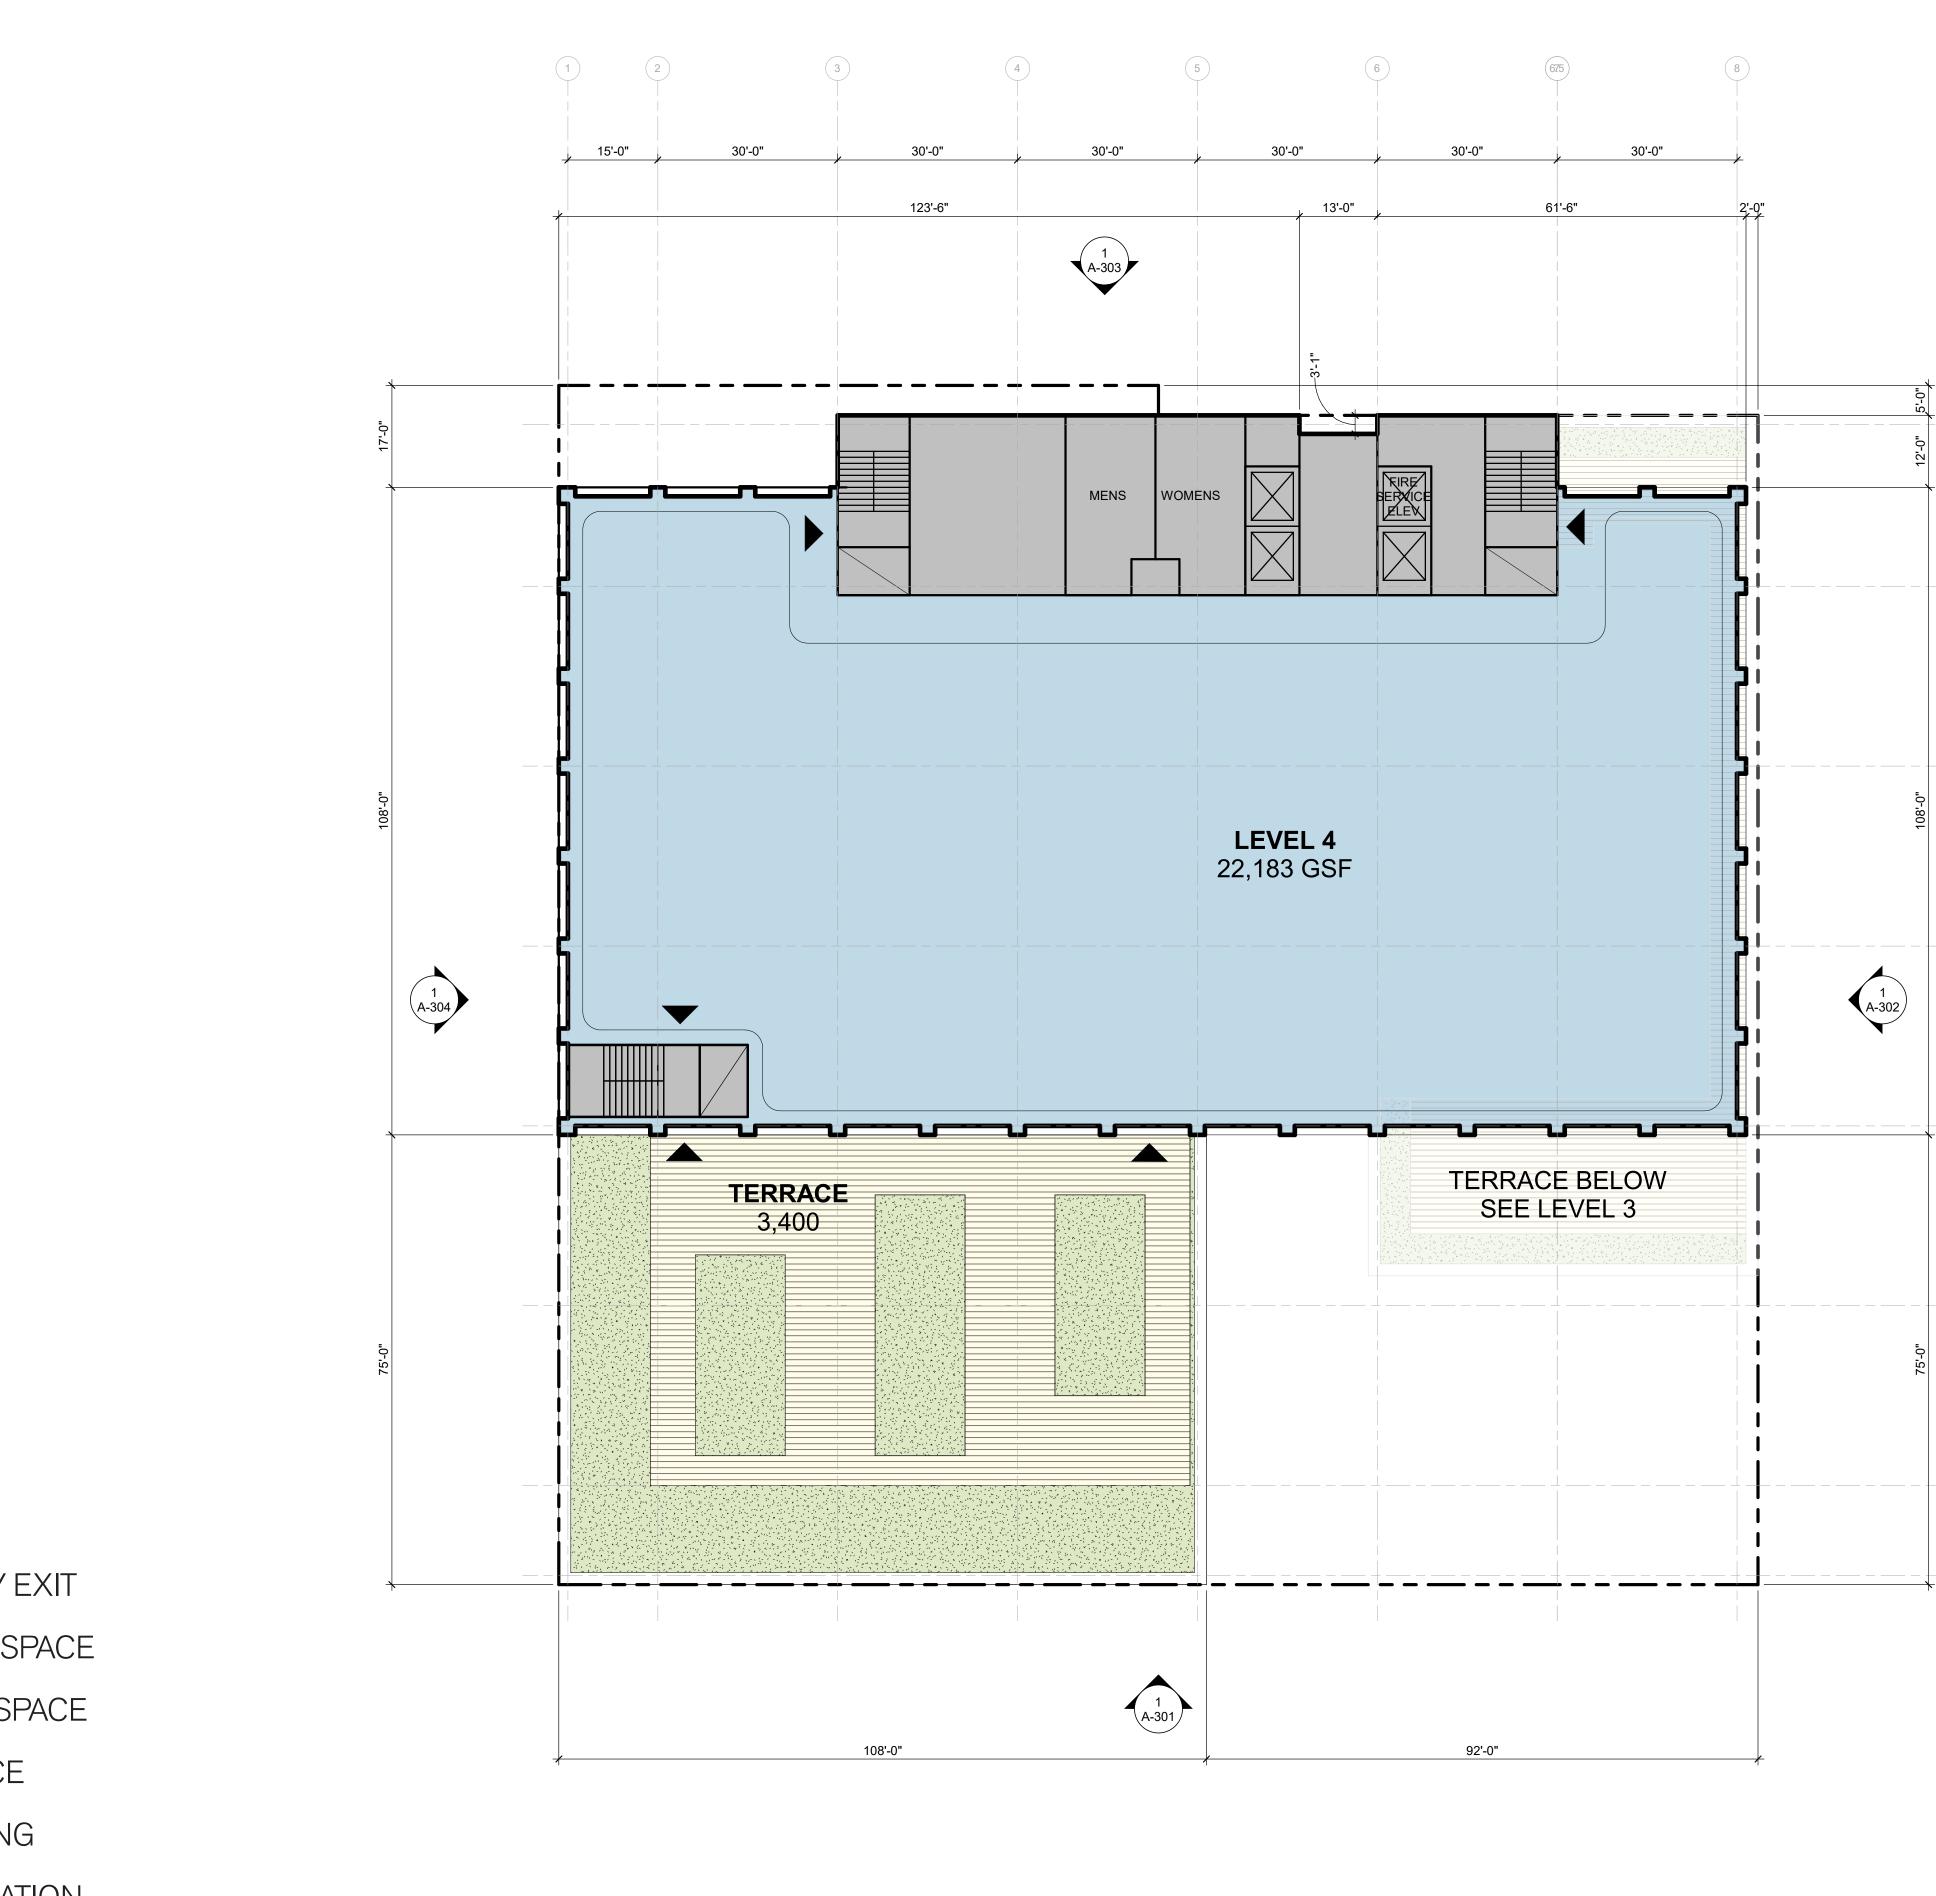



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2 	—(F)	2300 BROADWAY Redwood City, CA
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¥		PROJECT NO.: 19046.00 DATE: 10/22/2021 SCALE: 1/16" = 1'-0" SHEET TITLE: FLOOR PLAN - LEVEL 4
	 43'	SHEET NO: A-104

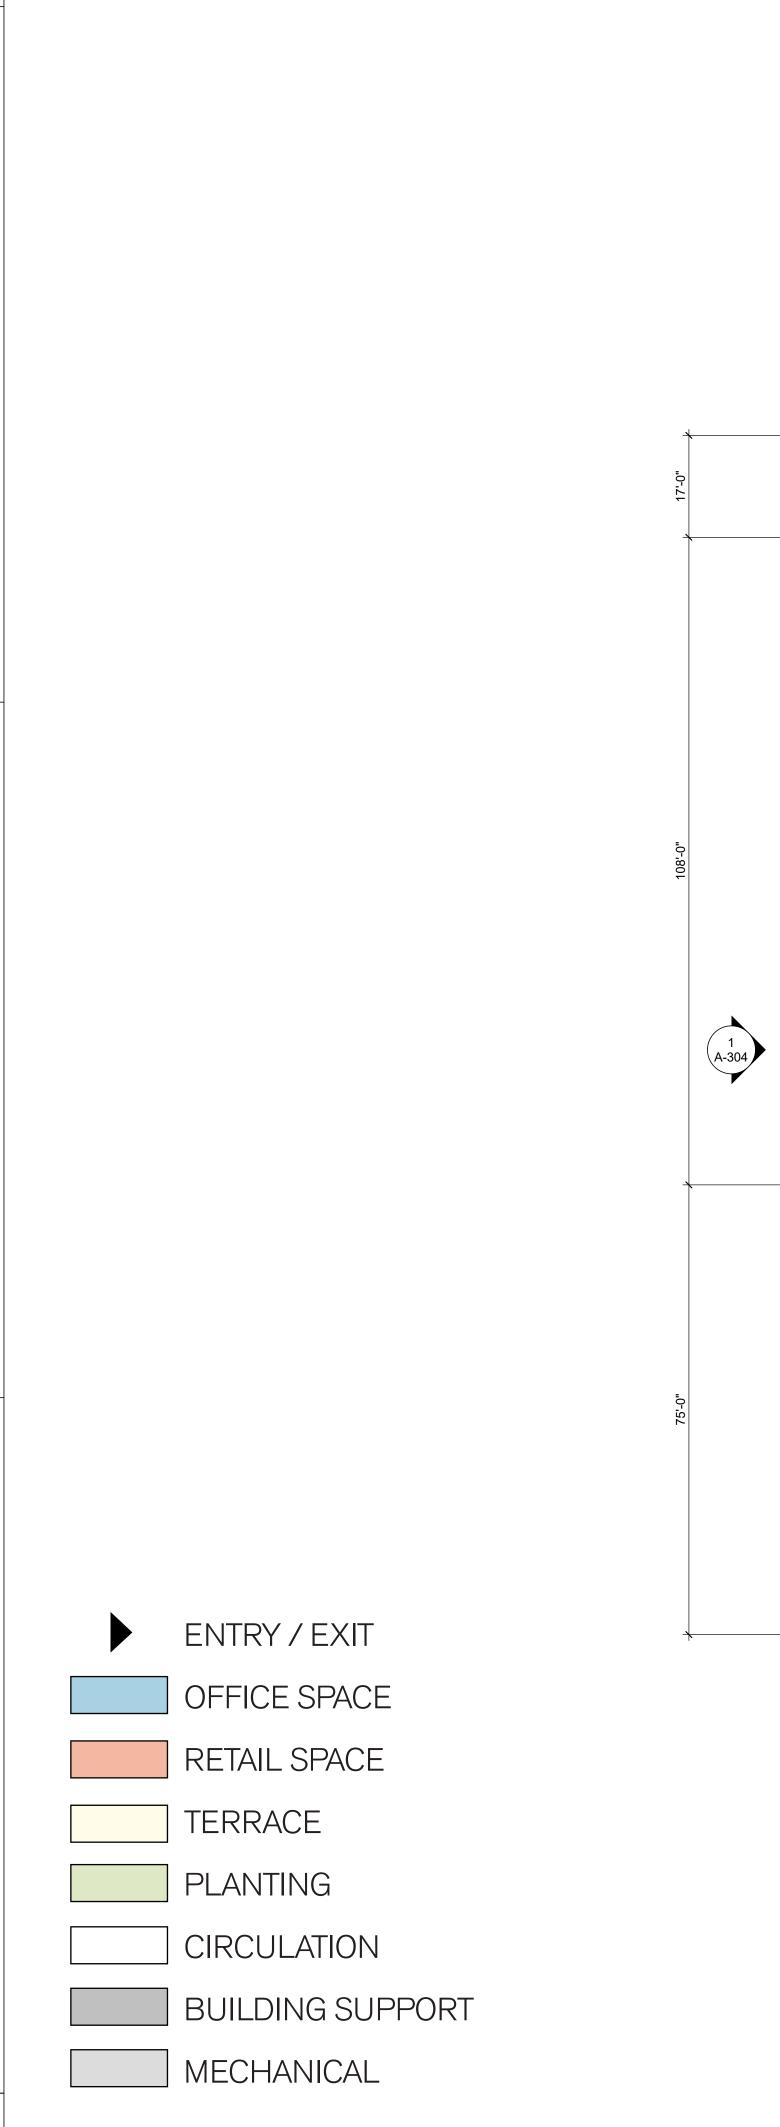


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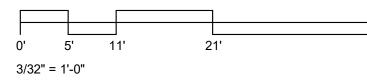
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15'-0"


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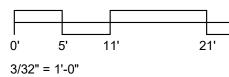



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		PROJECT NO.: 19046.00 DATE: 10/22/2021 SCALE: 1/16" = 1'-0" SHEET TITLE: FLOOR PLAN - LEV (TYP)	/EL 5-9
43'		SHEET NO:	A-105

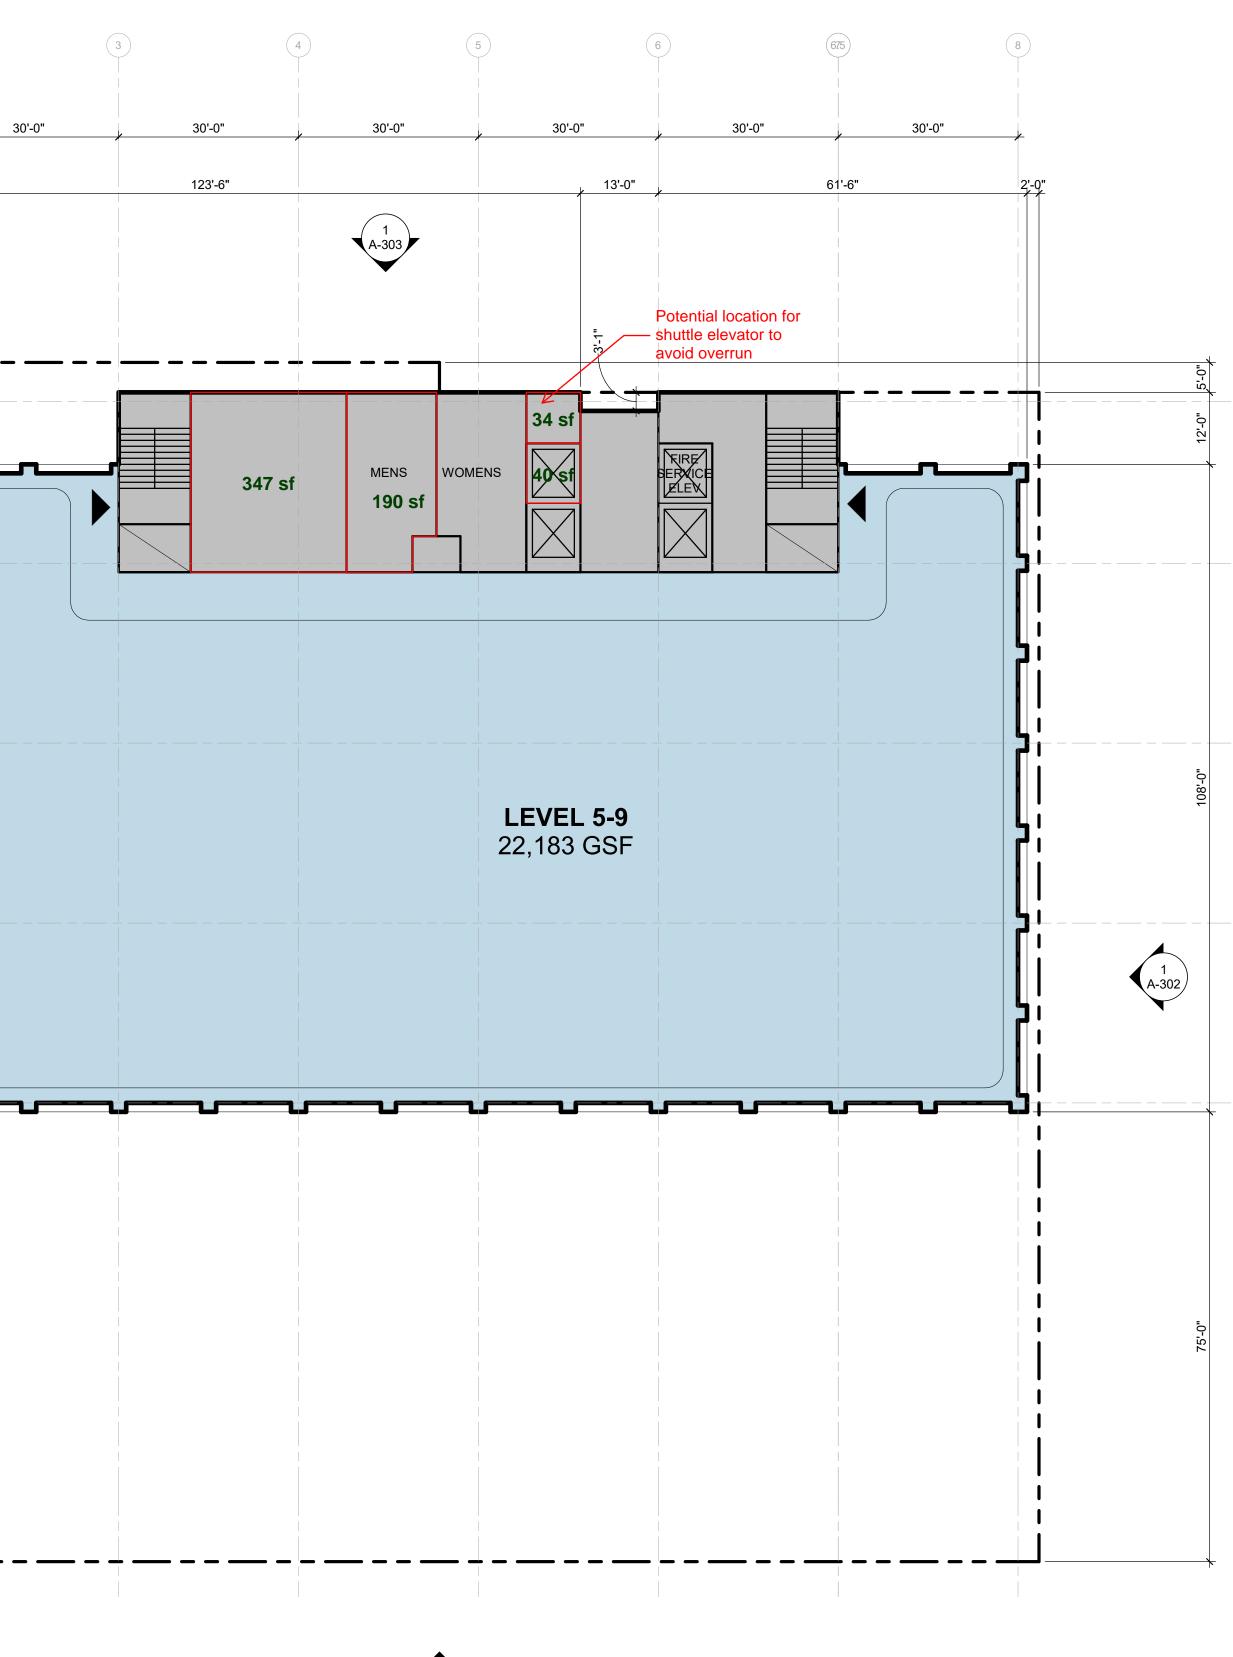

10/24/2021 10:09:32 AM

MECHANICAL

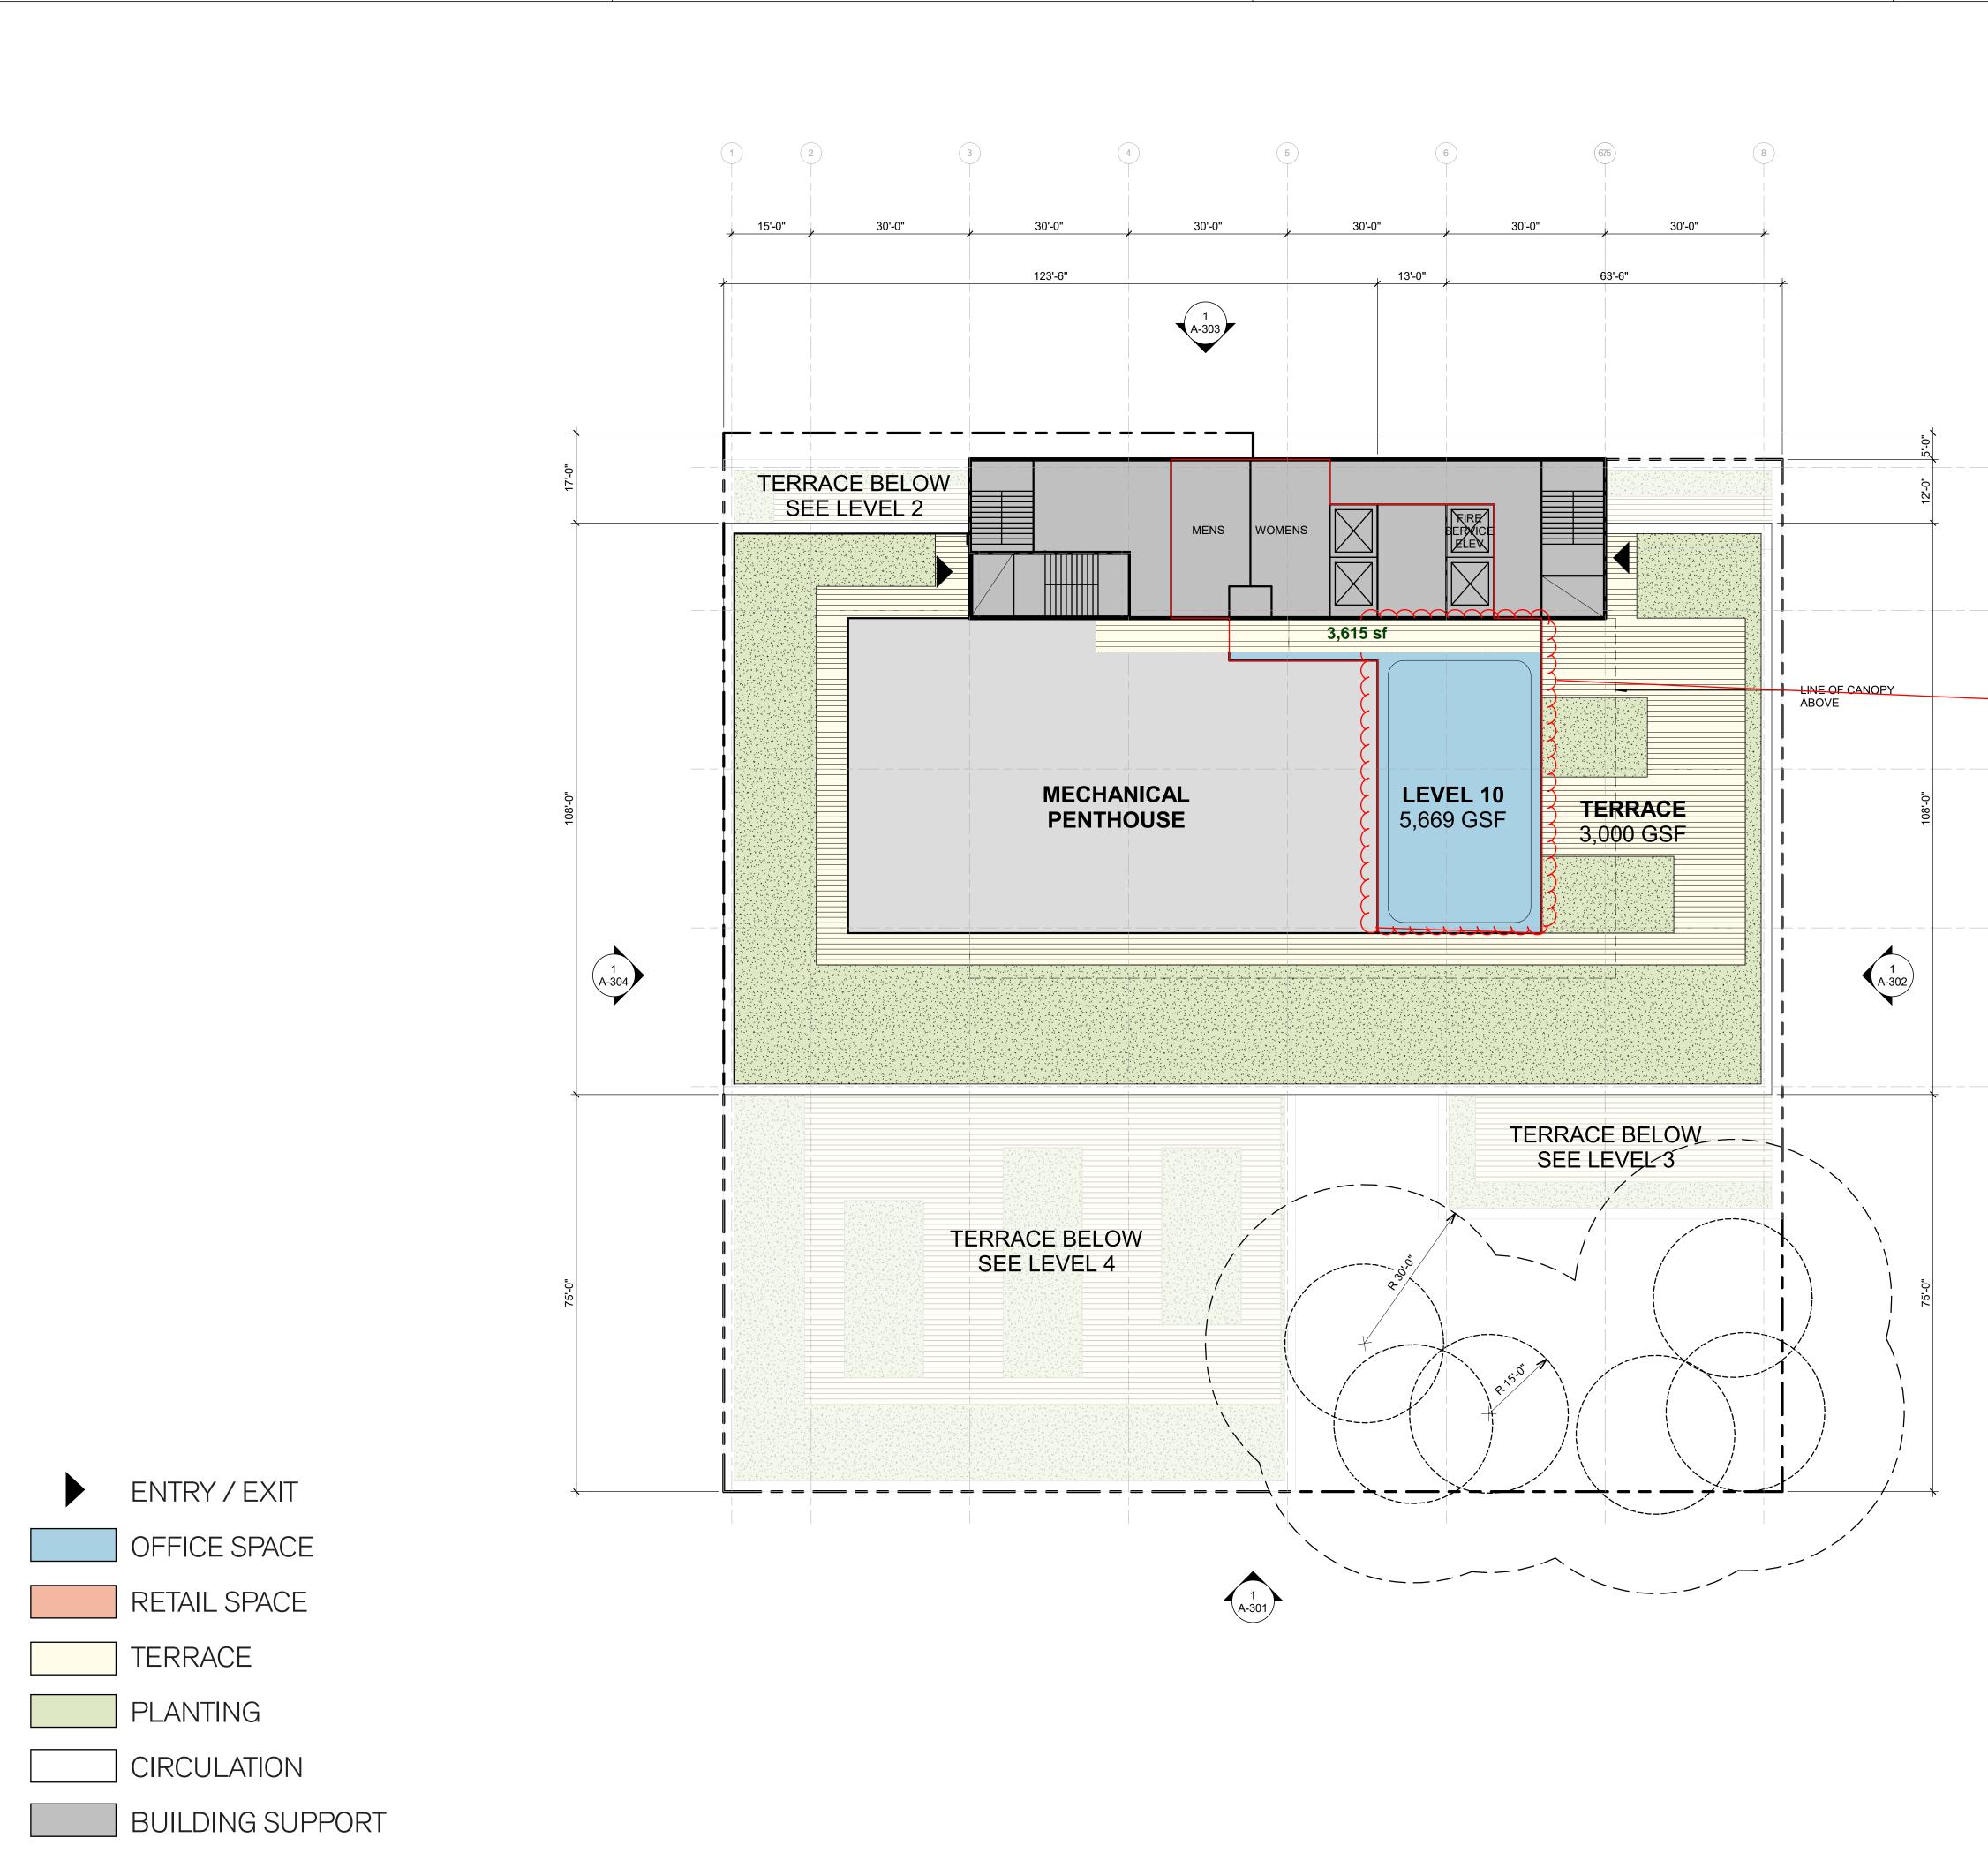

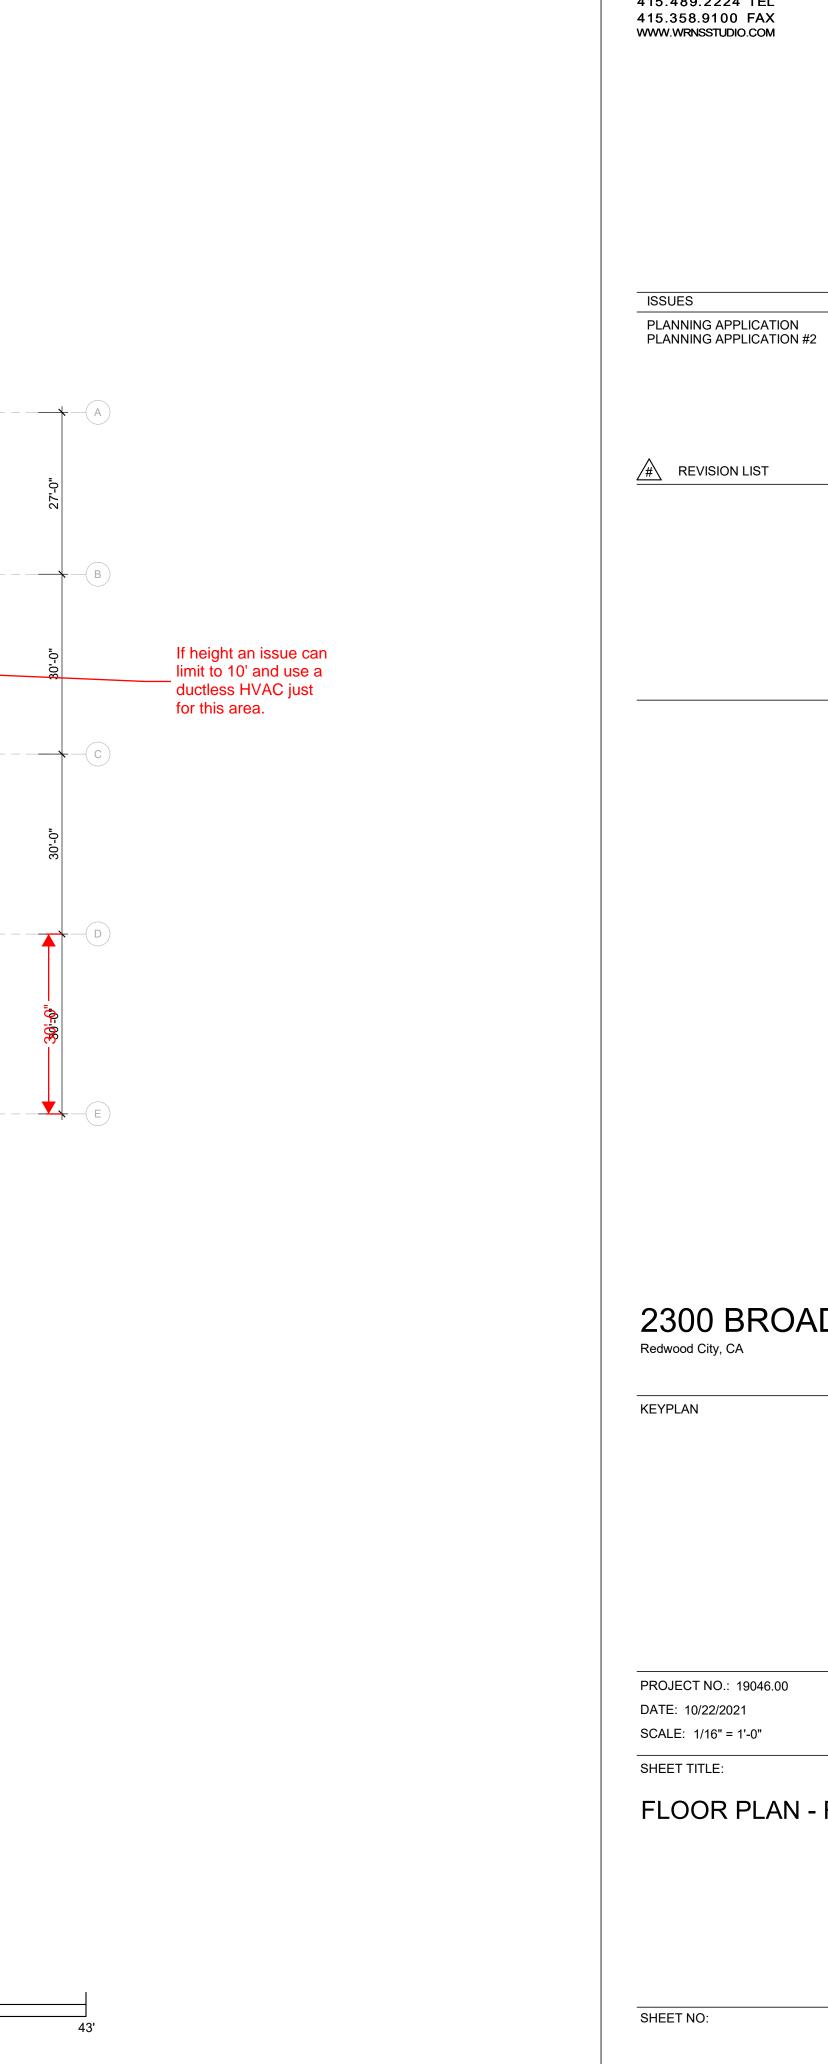

501 SECOND STREET 4TH FLOOR, STE. 402 SAN FRANCISCO CALIFORNIA 94107 415.489.2224 TEL

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DATE 03/03/2021 10/22/2021

DATE

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PROJECT NO.: 19046.00 DATE: 10/22/2021 SCALE: 1/16" = 1'-0"

FLOOR PLAN - ROOF

If this drawing is not 24"x36", then the drawing has been revised from its original size. Noted scales must be adjusted. This line should be equal to one inch


A-106







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ISSUES PLANNING APPLICATION PLANNING APPLICATION #2	DATE 03/03/2021 10/22/2021
REVISION LIST	DATE
2300 BROADWA Redwood City, CA	Υ
KEYPLAN	
PROJECT NO.: 19046.00 DATE: 10/22/2021 SCALE: As indicated SHEET TITLE: BUILDING ELEVATIO SOUTH	NS -

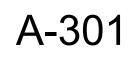









AM 10/24/2021 10:09:33

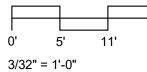








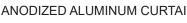







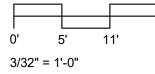



MASONRY PRECEDENT



Sequoia Hotel Redwood City




Diller-Chamberlain Store (726 Main St) Redwood City




Wahl Building Redwood City

MASONRY COLOR RANGE

BUFF - TAN

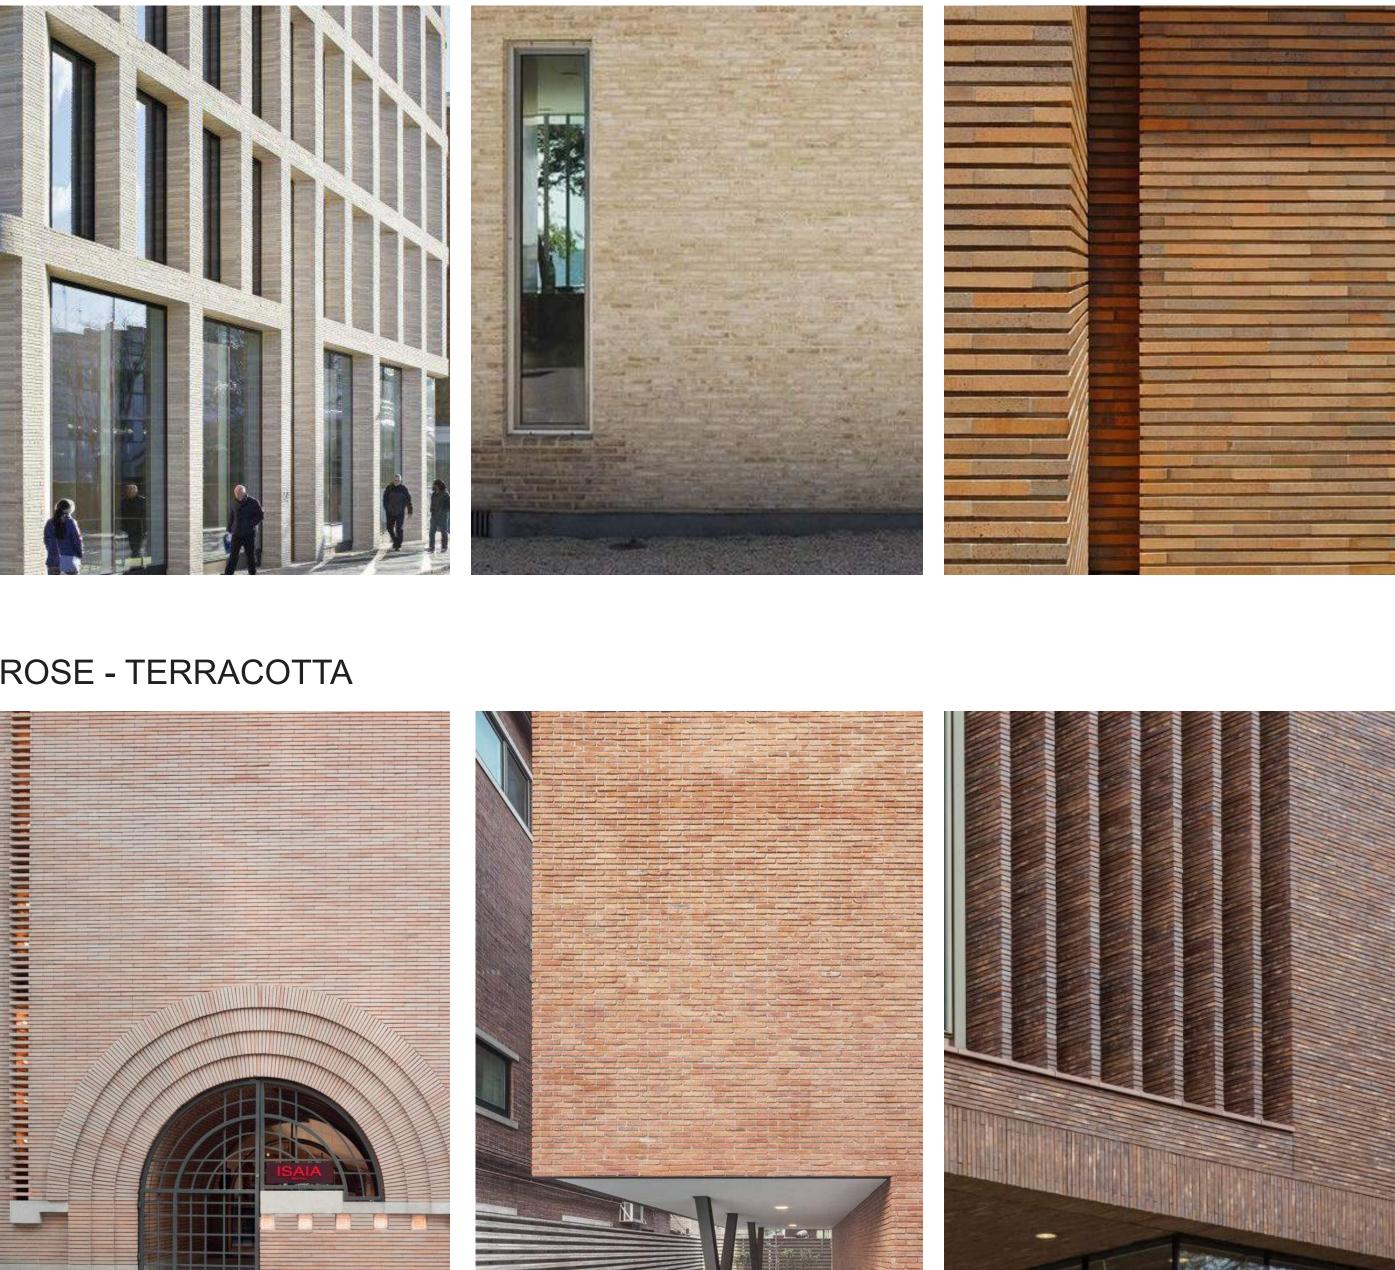


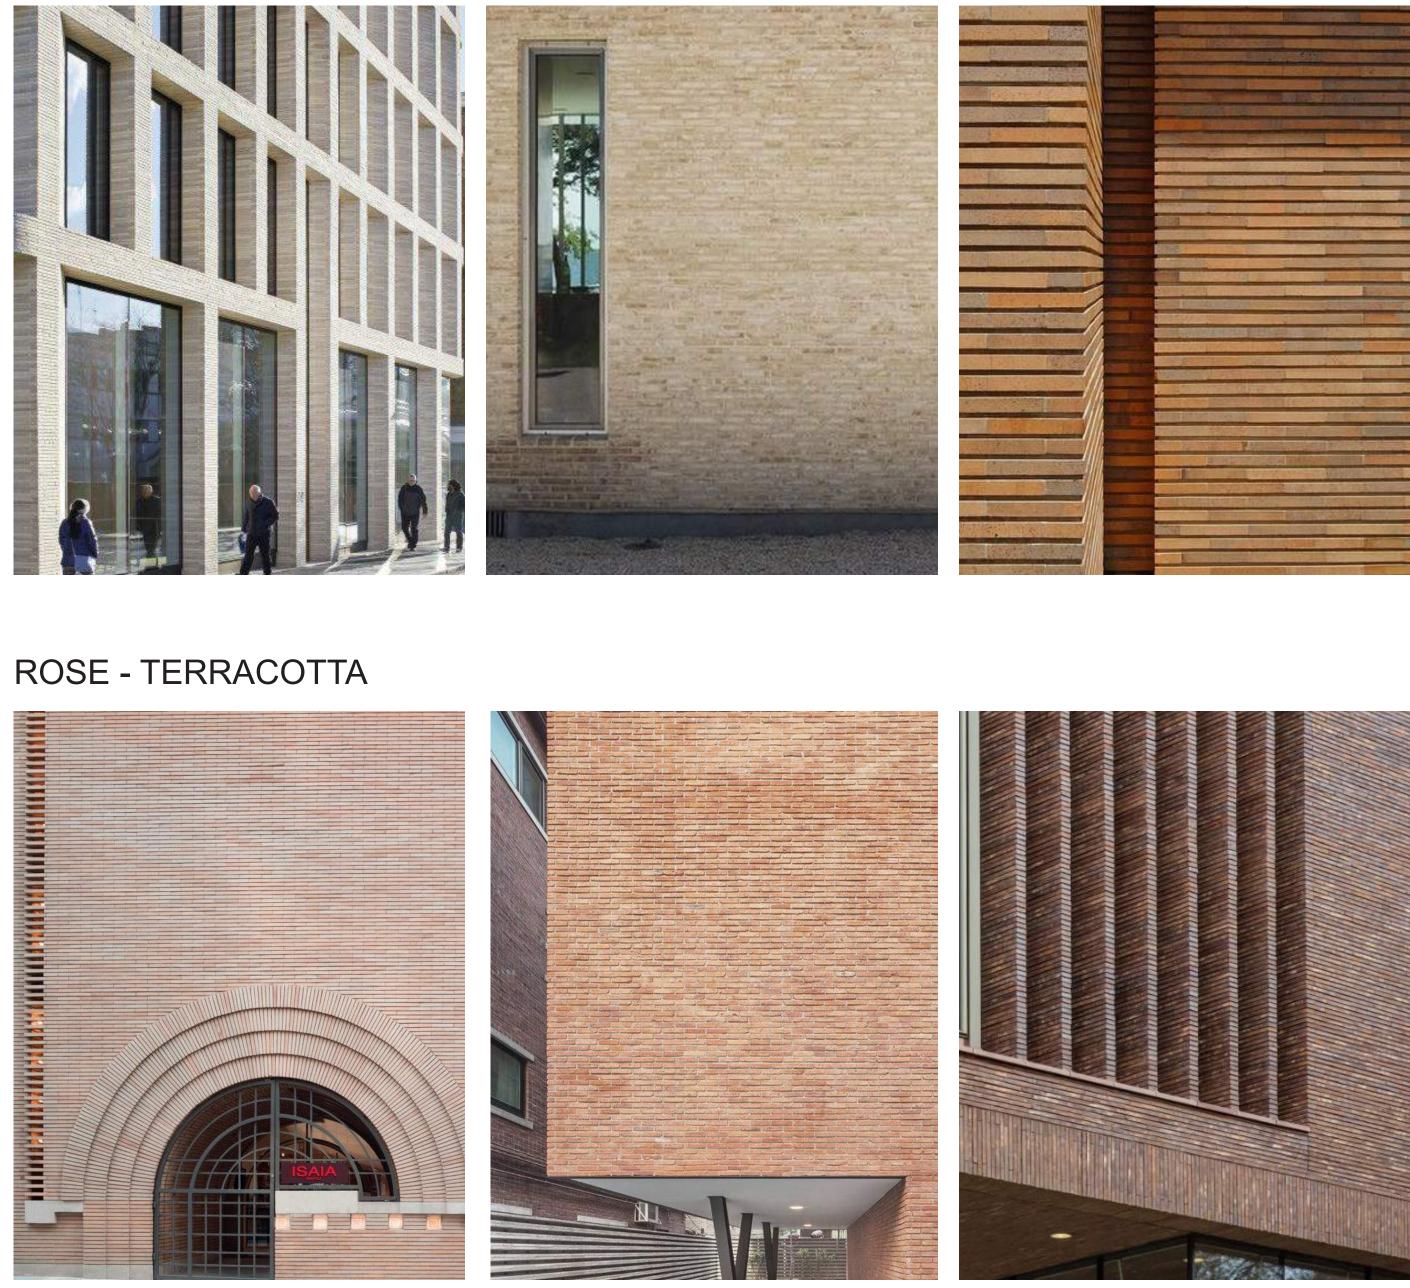

GREY - CARUB



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KEYPLAN

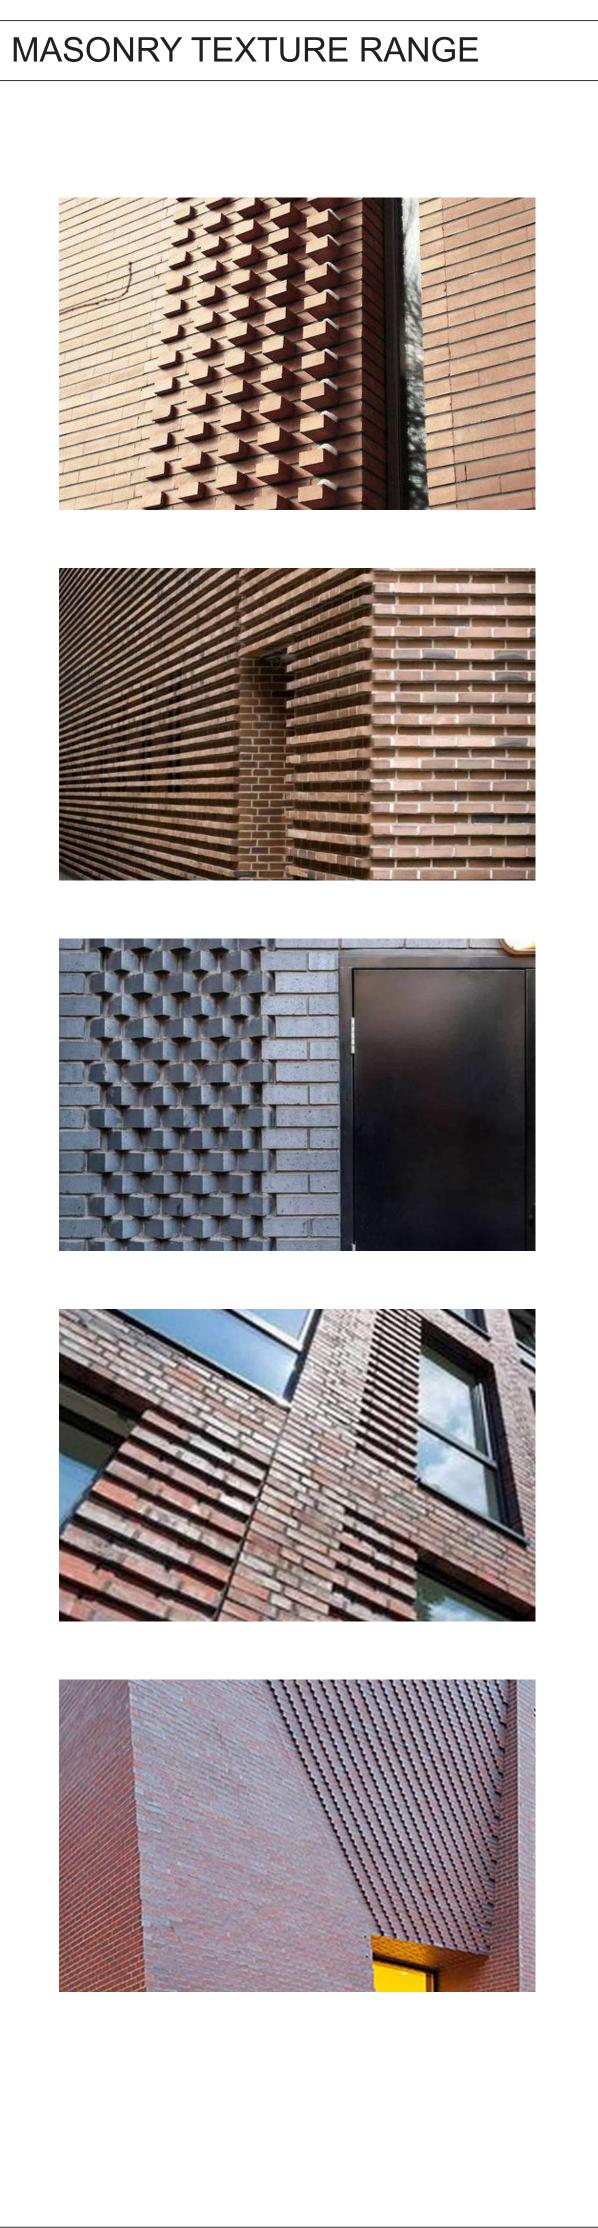PROJECT NO.: 19046.00 DATE: 03/05/2021 SCALE:

SHEET TITLE:

BUILDING MATERIAL CONCEPTS

SHEET NO:

A-305

METALWORK PRECEDENT



San Mateo County History Museum Redwood City



Sentinel Building San Francisco



War Memorial Veterans Building San Francisco

METALWORK RANGE

ZINC







ALUMINUM PANEL





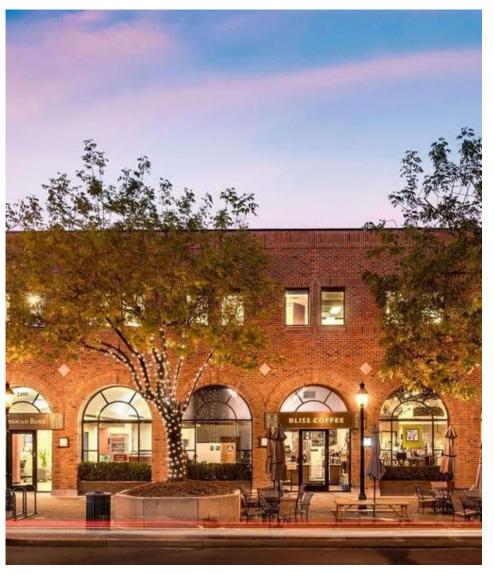

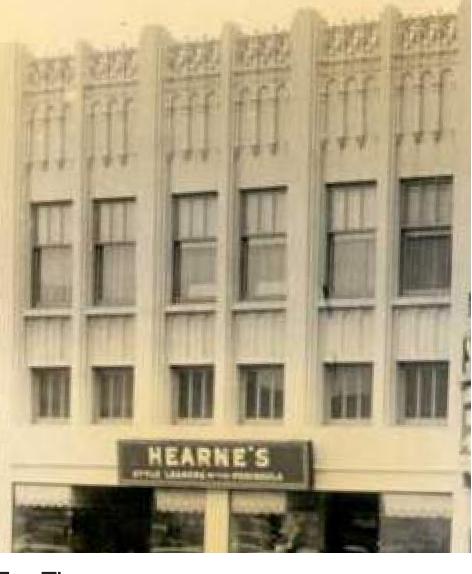

REPETITION PRECEDENT



801 Jefferson Redwood City

2400 Broadway Redwood City

Fox Theatre Redwood City

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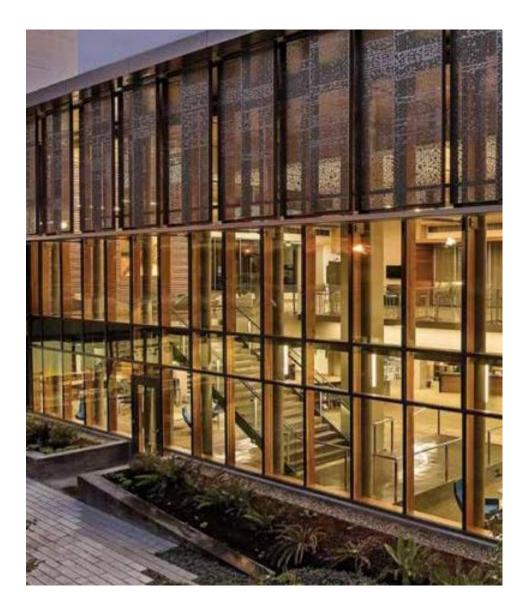
BUILDING MATERIAL CONCEPTS

SHEET NO:


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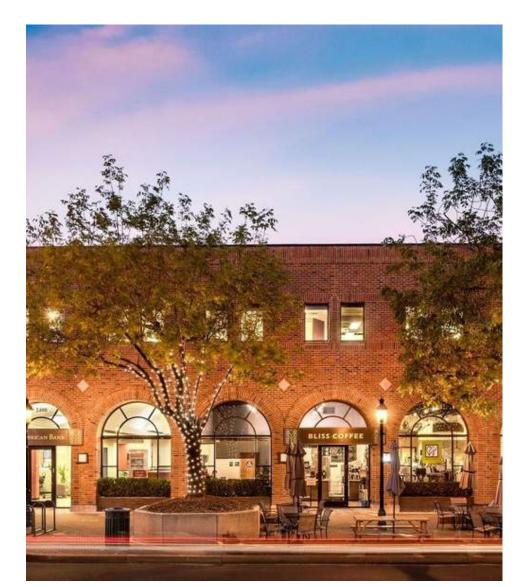
STOREFRONT PRECEDENT










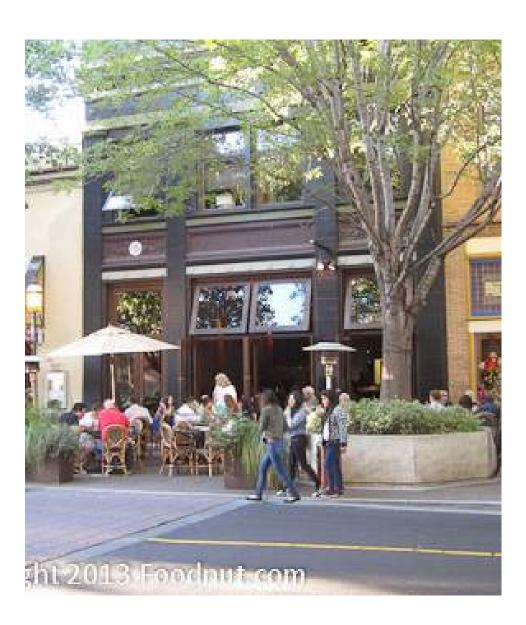





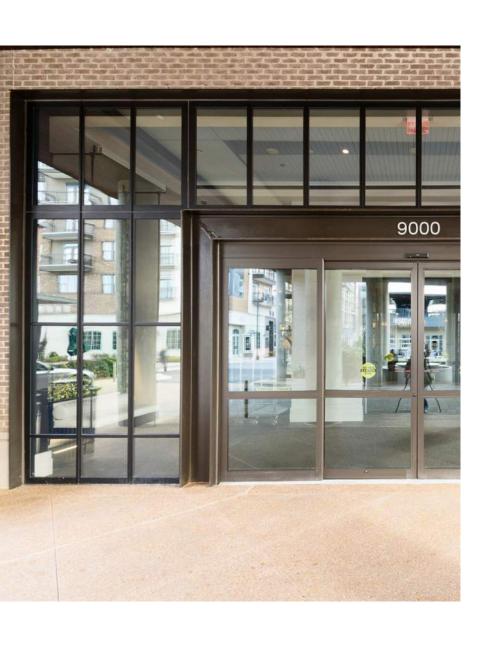





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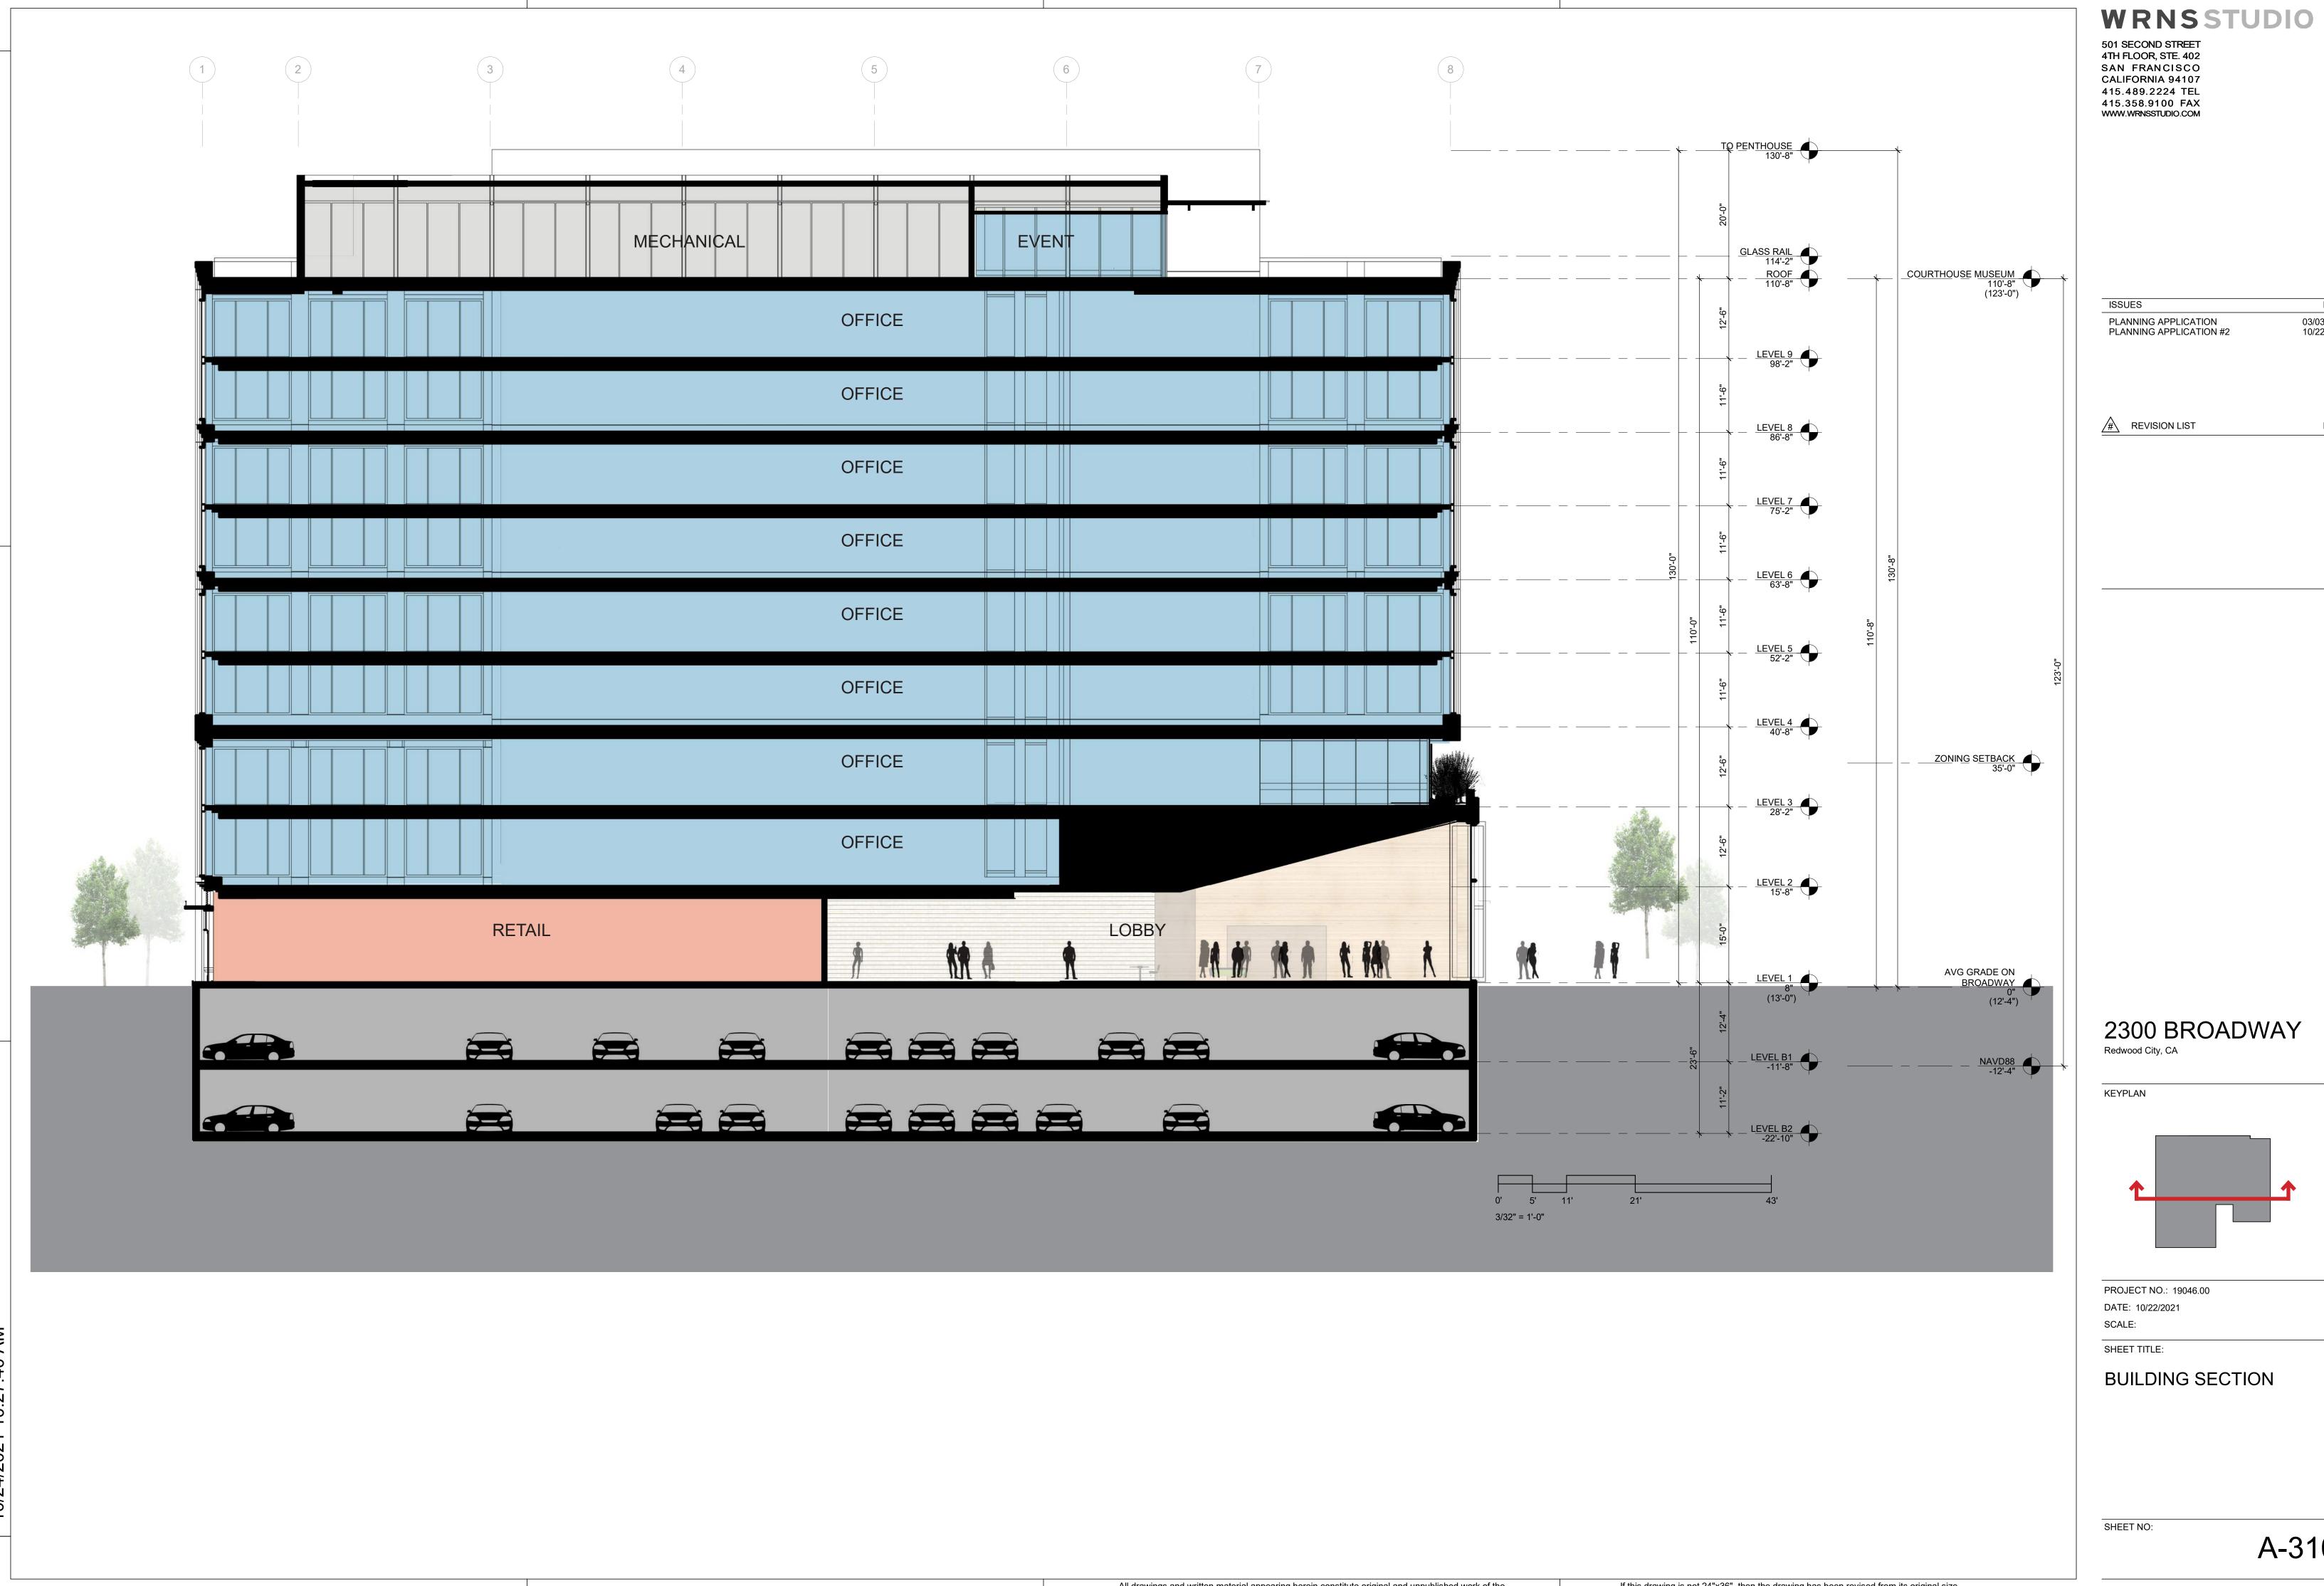
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PROJECT NO.: 19046.00 DATE: 03/05/2021 SCALE:

SHEET TITLE:

BUILDING MATERIAL CONCEPTS

SHEET NO:




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2300 BROADWAY **BUILDING SECTION** A-310


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03/03/2021 10/22/2021



WRNSSTUDIO 501 SECOND STREET 4TH FLOOR, STE. 402 SAN FRANCISCO CALIFORNIA 94107 415.489.2224 TEL 415.358.9100 FAX WWW.WRNSSTUDIO.COM DATE PLANNING APPLICATION PLANNING APPLICATION #2 03/03/2021 10/22/2021 # REVISION LIST DATE 2300 BROADWAY Redwood City, CA PROJECT NO.: 19046.00 DATE: 10/22/2021 **BUILDING SECTION**

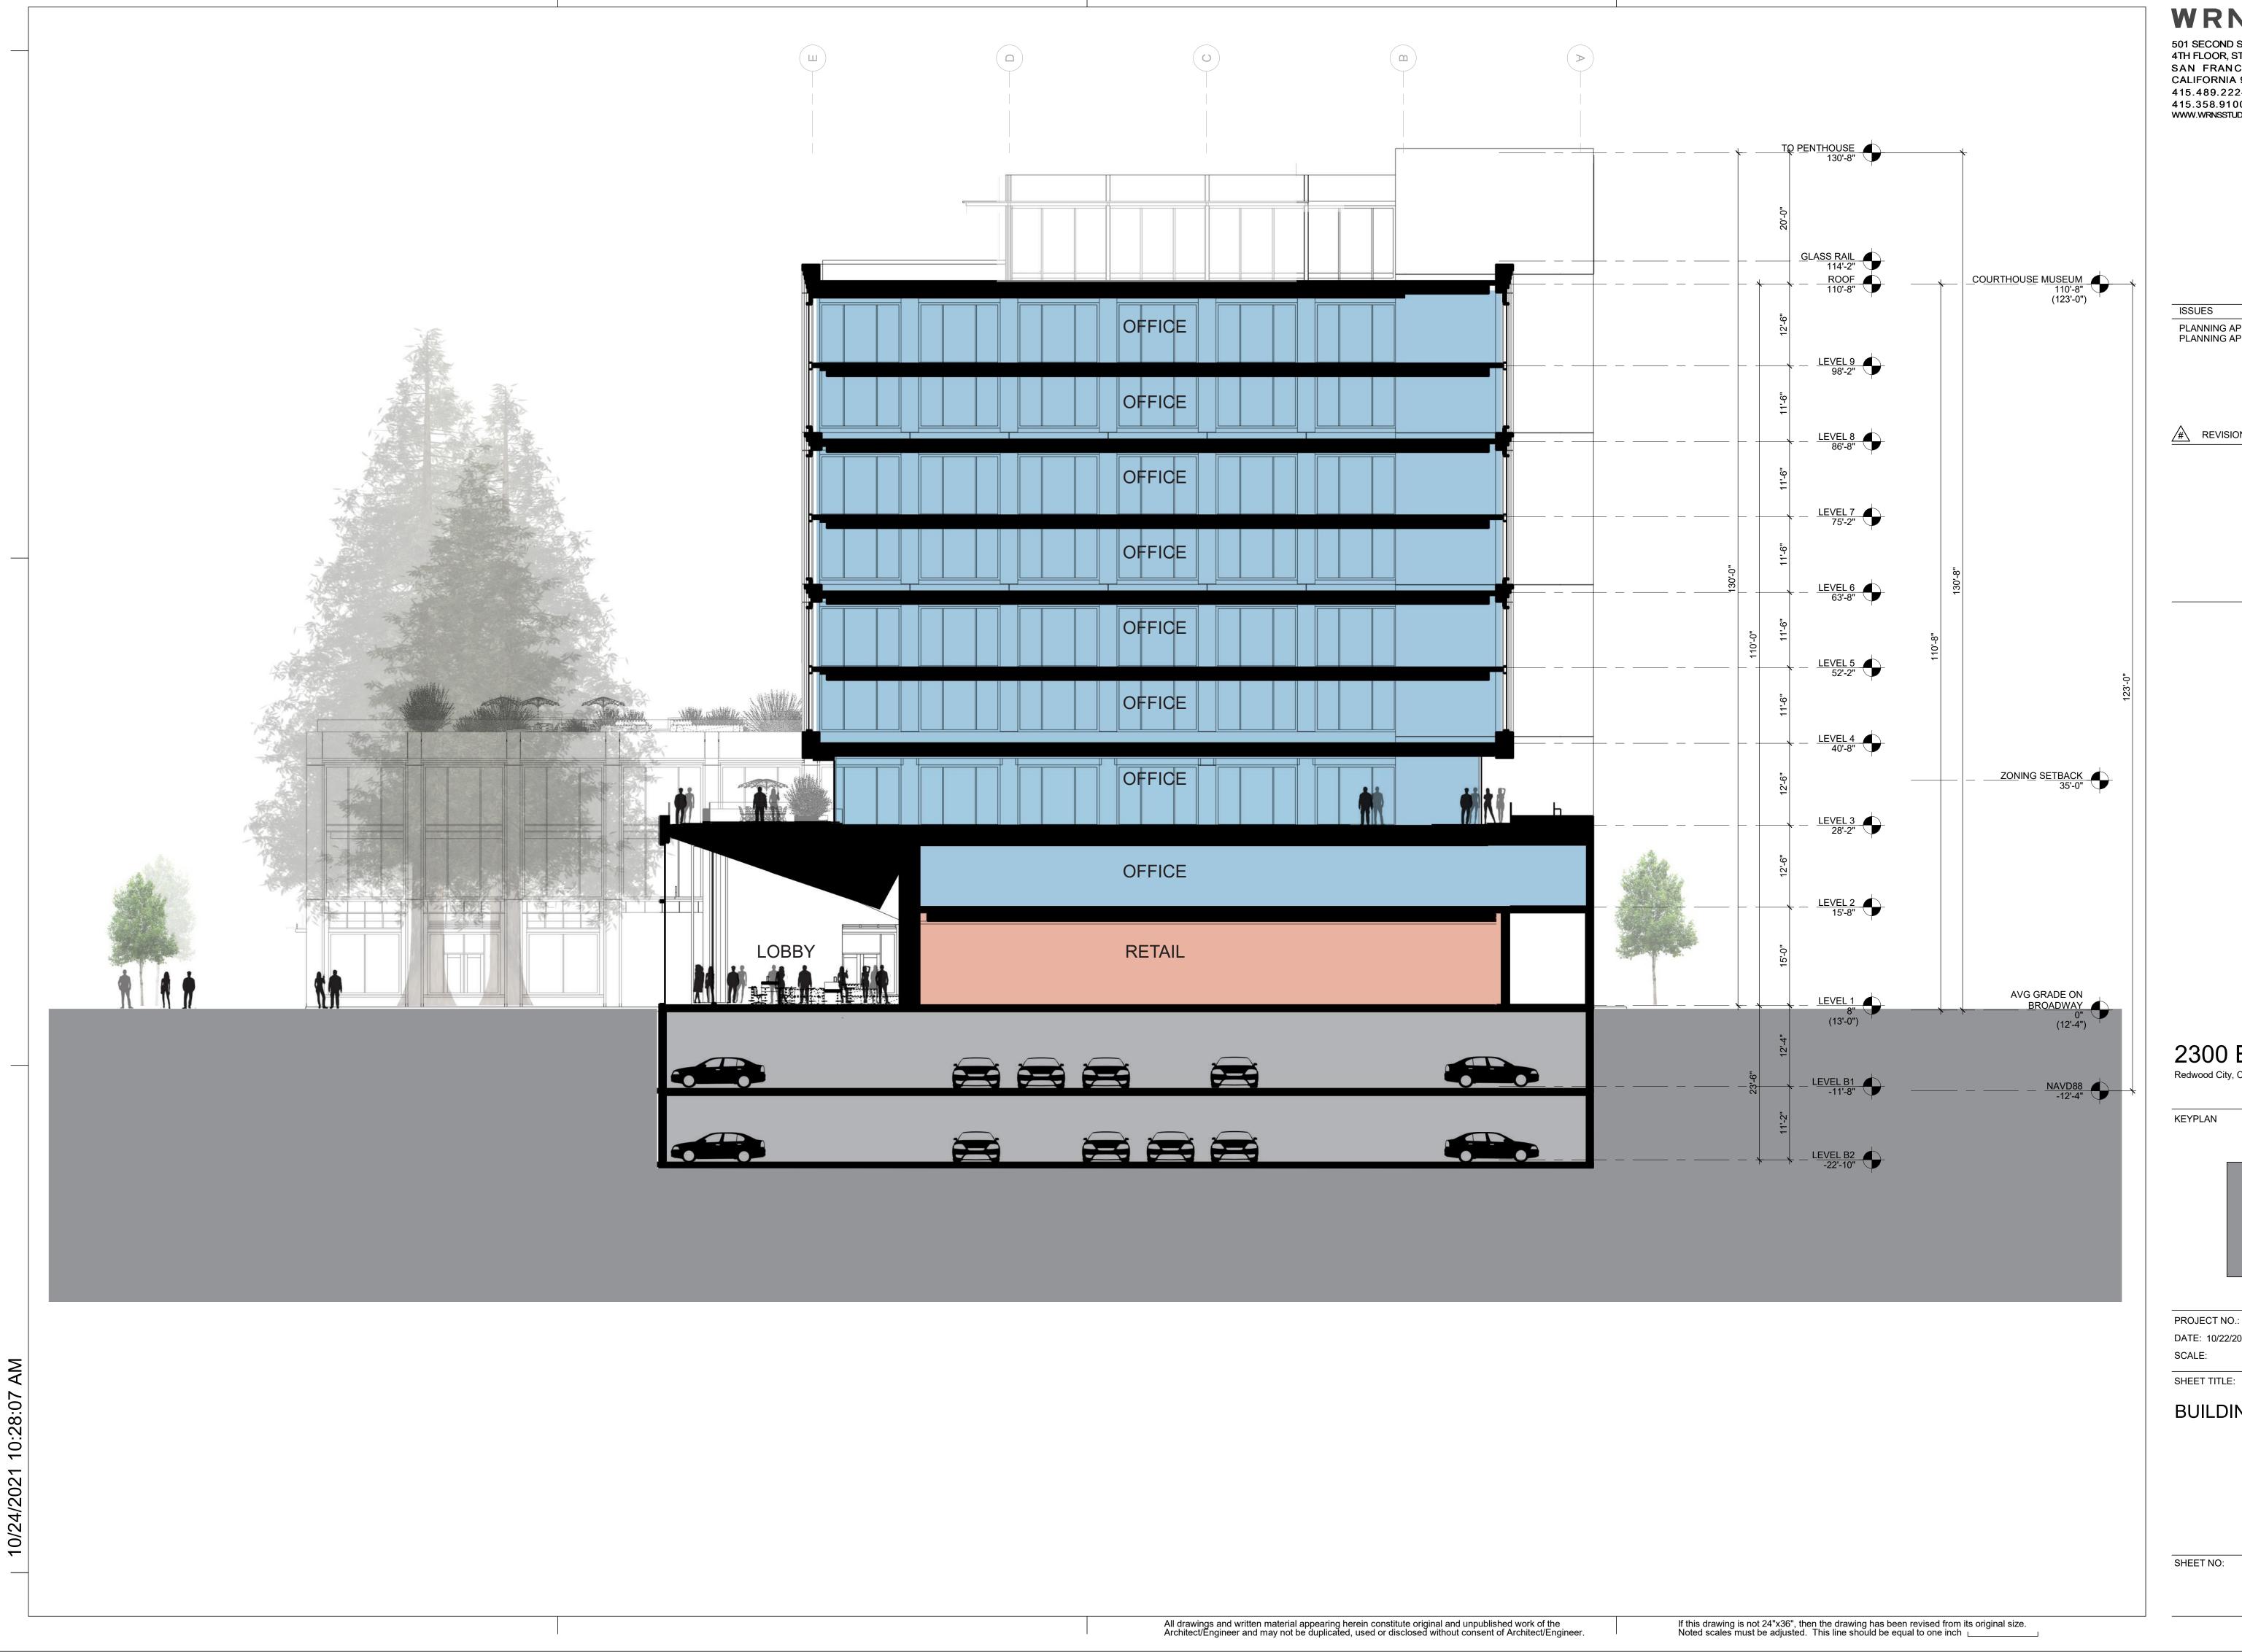

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View of Hamilton Green from Hamilton / Broadway

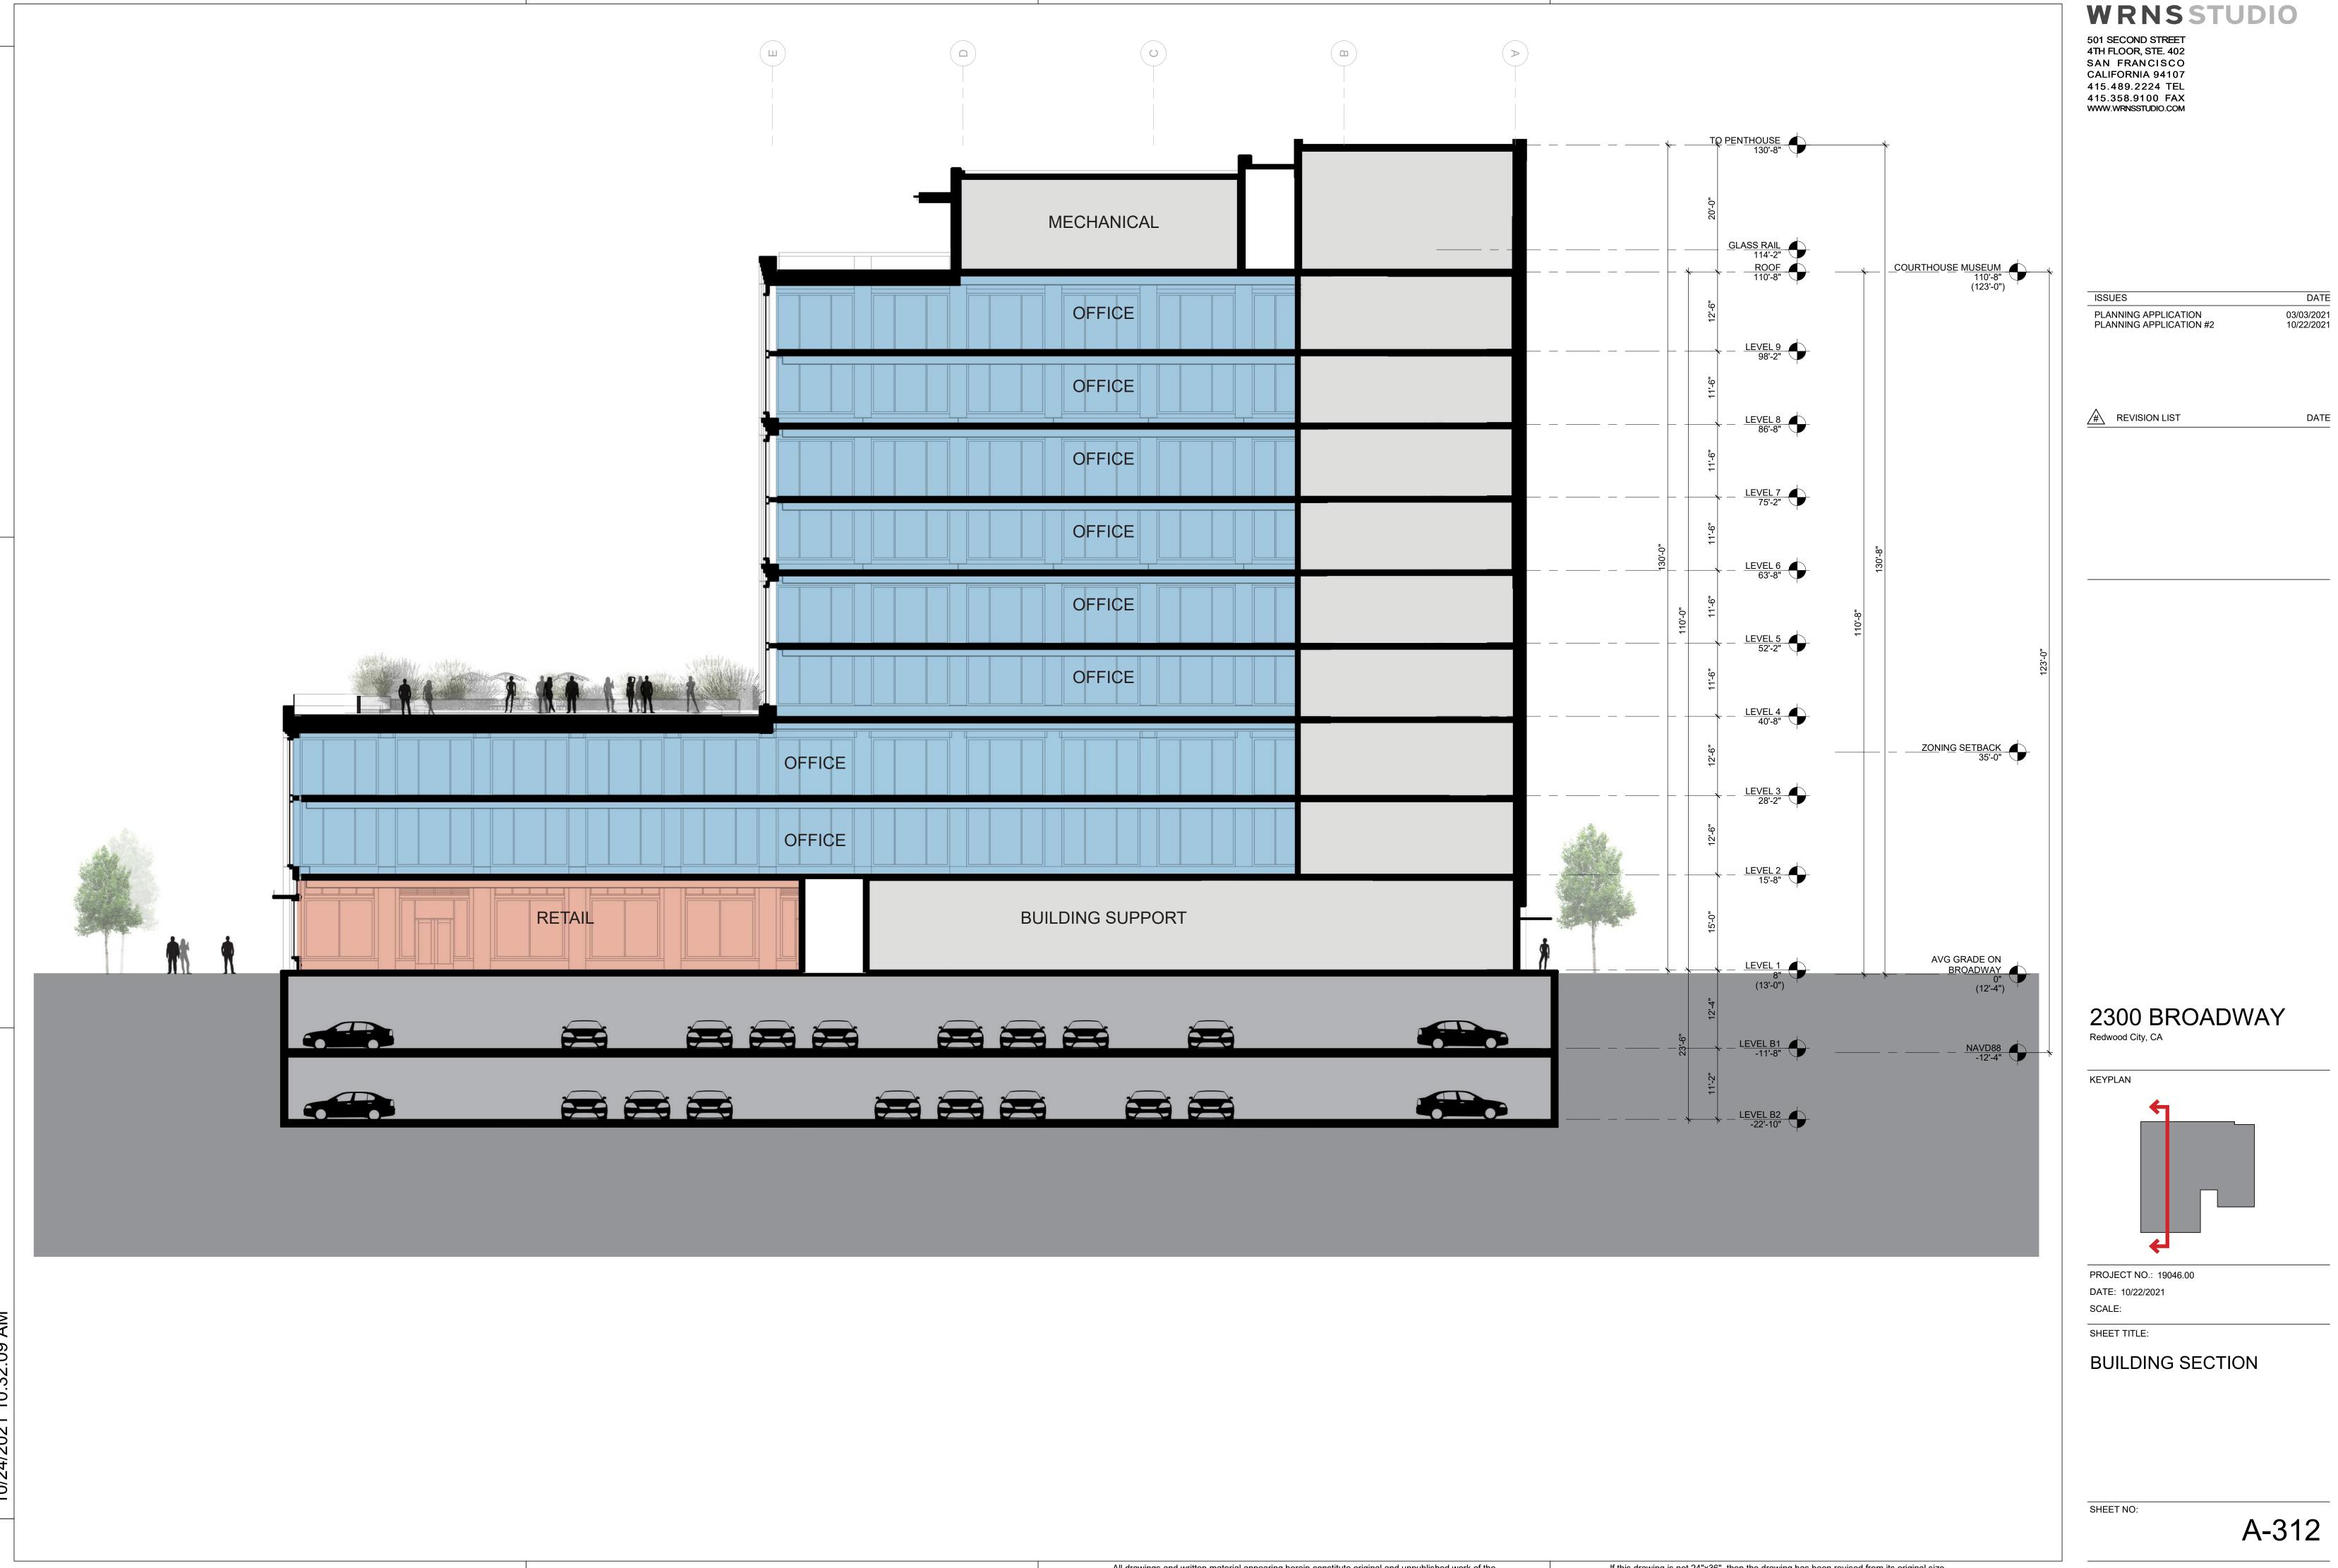

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PROJECT NO.: 19046.00 DATE: 10/22/2021 SCALE: SHEET TITLE:

PROJECT VIEWS

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View from Winslow / Broadway

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View along Broadway Street

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View from south side of Broadway

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View from the Courthouse Plaza Pavilion

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